

CITY INFORMATION

986 SOUTH VAN NESS AVENUE
 BLOCK: 3610
 LOT: 010
 ZONING: RTO-M
 HT. LIMIT: 50'
 OCCUPANCY: R-2, S-2
 CONSTRUCTION: IIIA - SPRINKLERED
 FULLY SPRINKLERED PER NFPA 13-2016
 STANDPIPES PER NFPA 14-2016
 FIRE ALARM SYSTEM PER NFPA 72

SQUARE FOOTAGE:
EXISTING:
 LOT SIZE: 5,225 SQ.FT. BUILDABLE AREA: 5,225 SQ.FT.
 BUILDING SIZE: 1,296 SQ.FT.
 PARKING: 14-CARS

PROPOSED:
 BUILDING FOOTPRINT: 3,291 SQ.FT.
 GROSS BUILDING SIZE: 15,498


	ALLOWED	PROPOSED
PER TABLE 506.2, TYPE IIIA R-2	72,000 SQ.FT.	3291 SQ.FT.
PER TABLE 506.2, TYPE IIIA R-2	72,000 SQ.FT.	3190 SQ.FT.
PER TABLE 506.2, TYPE IIIA R-2	72,000 SQ.FT.	3190 SQ.FT.
PER TABLE 506.2, TYPE IIIA R-2	72,000 SQ.FT.	2644 SQ.FT.
PER TABLE 506.2, TYPE IIIA R-2	72,000 SQ.FT.	2622 SQ.FT.
PER TABLE 506.2, TYPE IIIA R-2	72,000 SQ.FT.	0464 SQ.FT.
TOTAL		15,401 SQ.FT.

CBC 506.2.4: PROPOSED FLOOR AREA / ALLOWED FLOOR AREA (At +NS X II)
 1ST FLOOR: 3291 SQ.FT. / (36000 + (12000 X 0)) = .091
 2ND FLOOR: 3190 SQ.FT. / (36000 + (12000 X 0)) = .088
 3RD FLOOR: 3190 SQ.FT. / (36000 + (12000 X 0)) = .088
 4TH FLOOR: 2644 SQ.FT. / (36000 + (12000 X 0)) = .073
 5TH FLOOR: 2622 SQ.FT. / (36000 + (12000 X 0)) = .072
 ROOF: 464 SQ.FT. / (36000 + (12000 X 0)) = .012
TOTAL = .424
 .424 IS LESS THAN 3.0

FLOORS: 5
 UNITS: 15
 PARKING SPACES: 5
 BICYCLE PARKING: 19

BUILDING CODE:
 2016 CALIFORNIA BUILDING CODE (CBC)
 2016 SAN FRANCISCO BUILDING CODE & ADDENDUMS TO CBC
 ENERGY CODE - TITLE 24
 2016 SAN FRANCISCO MECH. & ELEC. CODES
 2016 SAN FRANCISCO FIRE CODES
 2016 CALIFORNIA PLUMBING CODE
BUILDING HEIGHT & STORIES:
 PER TABLE 504.3, TYPE IIIA, R-2 = 85 FEET ALLOWED (50 FEET PROPOSED)
 PER TABLE 504.4, TYPE IIIA, R-2 = 5 STORIES ALLOWED (5 STORIES PROPOSED)
 EMERGENCY RESPONDER RADIO COVERAGE TEST REQUIRED DURING CONSTRUCTION.

SYMBOLS

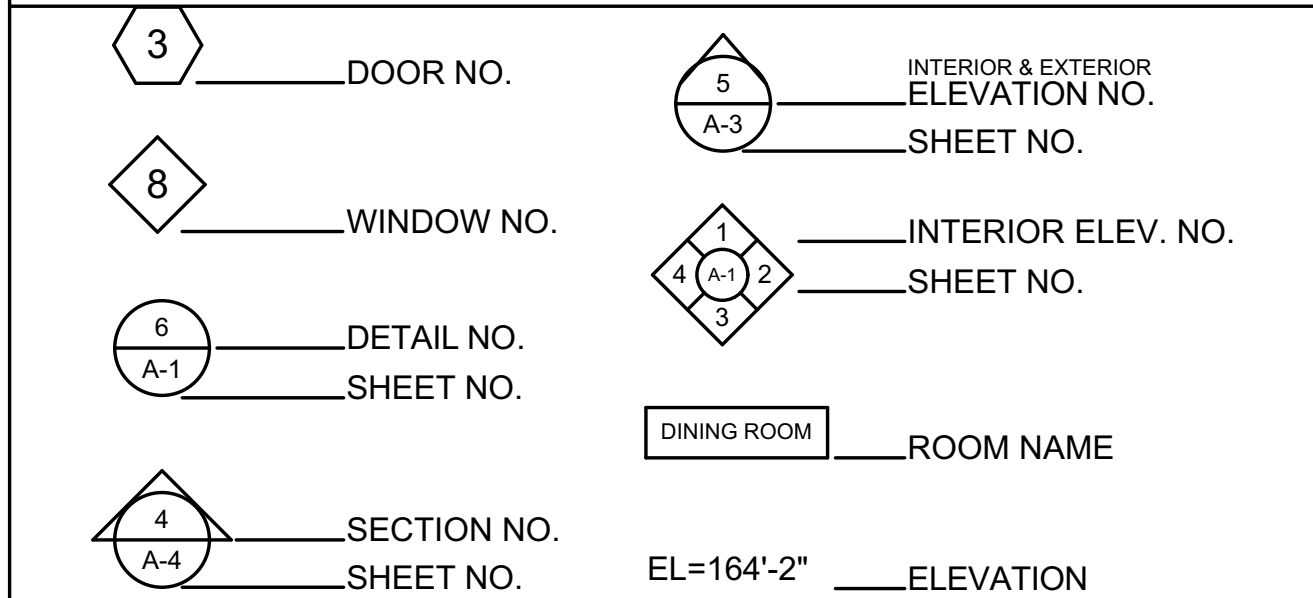

ABBREVIATIONS

&	AND	FDN.	FOUNDATION	PT.	POINT
<	ANGLE	FIN.	FINISH	PTN.	PARTITION
@	AT	FL.	FLOOR		
C	CENTERLINE	FLUOR.	FLUORESCENT	R.	RISER
#	DIAMETER OR ROUND POUND OR NUMBER	F.O.C.	FACE OF CONCRETE	R.D.	ROOF DRAIN
P	PROPERTY LINE	F.O.F.	FACE OF FINISH	REF.	REFRIGERATOR
ABV	ABOVE	F.T.	FACE OF STUDS	REIN.	REINFORCED
AC	AIR CONDITIONER	FTG.	FOOT OR FEET	REQ.	REQUIRED
ADJ.	ADJUSTABLE	FUR.	FOOTING	RM.	ROOM
A.F.F.	ABOVE FINISH FLOOR	FUT.	FURRING	R.O.	ROUGH OPENING
AL.	ALUMINUM	GALV.	FUTURE	RWD.	REDWOOD
APPROX.	APPROXIMATE	GD.	GALVANIZED	R.W.L.	RAIN WATER LEADER
ARCH.	ARCHITECTURAL	GYP.	GRADE	S.C.	SOLID CORE
BD.	BOARD	H.C.	GYPSUM	SCHED.	SCHEDULE
BLDG.	BUILDING	H.B.		SECT.	SECTION
BLK.	BLOCK	H/C		SHIT.	DRAWING SHEET
BLKG.	BLOCKING	H.C.		SIM.	SIMILAR
BM.	BEAM	H.D.W.		SPEC.	SPECIFICATION
B.W.	BOTTOM OF WALL	H.D.W.		H.C.	HOLLOW CORE
CAB.	CABINET	H.D.W.		HDW.	HARDWARE
CER.	CERAMIC	H.D.W.		HDWD.	HARDWOOD
CLG.	CERAMIC	H.M.		HT.	HOLLOW METAL
CL.	CLOSET	HT.		HT.	HEIGHT
CLR.	CLEAR	HTH		HTH	HOT WATER HEATER
COL.	COLLUMIN	INSUL.		INSUL.	INSULATION
CONC.	CONCRETE	INT.		INT.	INTERIOR
CONT.	CONTINUOUS	JAN.		JAN.	JANITOR
CTR.	CENTER	JT.		JT.	JOINT
DBL.	DOUBLE	LAM.		LAM.	LAMINATE
DEPT.	DEPARTMENT	LAV.		LAV.	LAVATORY
D.F.	DRINKING FOUNTAIN	LT.		LT.	LIGHT
DET.	DETAIL	MAX.		MAX.	MAXIMUM
DIA.	DIAMETER	MECH.		MECH.	MECHANICAL
DIM.	DIMENSION	MEMB.		MEMB.	MEMBRANE
DN.	DOWN	MFR.		MFR.	MANUFACTURER
DTL.	DETAIL	MIN.		MIN.	MINIMUM
DW.	DISHWASHER	MISC.		MISC.	MISCELLANEOUS
DWG.	DRAWING	M.O.		M.O.	MASONRY OPENING
(E)	EXISTING	MTD.		MTD.	MOUNTED
EA.	EACH	(N)		(N)	NEW
EL.	ELEVATION	N.I.C.		N.I.C.	NOT IN CONTRACT
ELEC.	ELECTRICAL	NO. OR #		NO. OR #	NUMBER
ELEV.	ELEVATOR	N.T.S.		N.T.S.	NOT TO SCALE
EQ.	EQUAL	O.C.		O.C.	ON CENTER
EQPT.	EQUIPMENT	O.D.		O.D.	OUTSIDE DIAMETER
EXP.	EXPANSION	PL.		PL.	PLATE
EXT.	EXTERIOR	P.LAM.		P.LAM.	PLASTIC LAMINATE
FAU	FORCED AIR UNIT	PLYWD.		PLYWD.	PLYWOOD
F.D.	FLOOR DRAIN	PR.		PR.	PAIR
		P.T.		P.T.	PRESSURE TREATED

GENERAL NOTES

- ALL DIMENSIONS SHOWN ARE TO FACE OF STUD, FACE OF CONCRETE, OR FACE OF BLOCK, U.O.N. VERTICAL DIMENSIONS ARE SHOWN TO TOP OF SLAB, FLOOR JOISTS OR FLOOR FRAMING.
- CONTRACTOR AND SUBCONTRACTORS SHALL FAMILIARIZE THEMSELVES WITH EXISTING CONDITIONS PRIOR TO COMMENCING WORK.
- DO NOT SCALE DRAWINGS. WRITTEN DIMENSIONS TAKE PRECEDENCE. CONTRACTOR TO NOTIFY ARCHITECT OF ANY DISCREPANCIES BETWEEN FIELD CONDITIONS AND DIMENSIONS/CONDITIONS SHOWN IN THESE DRAWINGS.
- MECHANICAL, PLUMBING, ELECTRICAL AND SPRINKLER PERMITS SHALL BE THE RESPONSIBILITY OF THOSE SUBCONTRACTORS.
- AUTOMATIC FIRE SPRINKLER SYSTEM DESIGN AND CONSTRUCTION IS TO BE PERFORMED UNDER A SEPARATE PERMIT OBTAINED BY THE FIRE PROTECTION SUBCONTRACTOR. FIRE SPRINKLERS ARE DESIGNED TO BE ZONED BY FLOOR. FIRE ALARM ZONED BY FLOOR AND DEVICE.
- STREET AND SIDEWALK IMPROVEMENTS SHALL BE CONDUCTED UNDER SEPARATE PERMITS.
- CONTRACTOR SHALL REVIEW AND UTILIZE SPECIFICATIONS PROVIDED IN CONJUNCTION WITH THIS SET OF CONSTRUCTION DOCUMENTS. ARCHITECT SHOULD BE NOTIFIED OF ANY DISCREPANCY BETWEEN DRAWINGS AND SPECIFICATIONS.
- ELEVATOR TO COMPLY WITH CODES SET FORTH IN CHAPTER 30 OF THE CBC. INSTALLATION OF THE ELEVATOR ACCESS HATCH WILL BE IN COMPLIANCE WITH NFPA 72, 2016 EDITION, UNDER SEPARATE PERMIT.
- SHORING AND UNDERPINNING WORK TO BE UNDER SEPARATE PERMITS.
- ALL WORK PERFORMED WILL COMPLY WITH THE AMERICAN DISABILITIES ACT OUTLINED IN SECTIONS 10, 11, 11A & 11B IN THE CBC & FHA GUIDELINES. SEE SHEET AS.0 FOR STANDARD ACCESSIBILITY DETAILS APPLICABLE THROUGHOUT PROJECT.
- SOUND TRANSMISSION CONTROL TO BE PROVIDED AS REQUIRED BY APPENDIX CHAPTER 35, 2013 SFBCC (STC AND IIC OF 50 BETWEEN UNITS).
- THE BUILDING SHALL COMPLY WITH VENTILATION REQUIREMENTS. SEE CODE SECTION 1203.1.

PROJECT SCOPE

REMOVE EXISTING 1-STORY GARAGE. NEW 5-STORY, TYPE IIIA, 15 UNIT MULTI-FAMILY RESIDENTIAL BUILDING W/ A ROOF DECK.

2 BELOW MARKET RATE UNITS REQUIRED AND PROVIDED. ADDITIONAL 1 STUDIO VOLUNTEERED BY PROJECT SPONSOR.

3 COMPACT & 1 SUB-COMPACT PARKING SPACES & 1 ADA VAN SPACE AS REQUIRED PER CBCB 11A-1109A. ALL PARKING UNASSIGNED.

CONC. MAT SLAB FOUNDATION.

PROJECT DIRECTORY

ARCHITECT
 TONY PANTALEONI
 KOTAS/PANTALEONI
 70 ZOE SUITE 200
 SAN FRANCISCO, CA 94107
 415.495.4051

OWNER
 LUCAS EASTWOOD
 986 S. VAN NESS LLC
 3520 20TH STREET UNIT B
 SAN FRANCISCO, CA 94110
 LUCAS@EASTWOODSF.COM

SURVEY
 GREG IPPOLITO
 FORESIGHT LAND SURVEYING
 301 CALIFORNIA DR. SUITE #2
 BURLINGAME, CA 94010
 415.735.6180

GEOTECHNICAL
 BEN WELLS
 ENVIRONMENTAL RESOURCE GROUP INC.
 15 LOCUST AVE.
 MILL VALLEY, CA 94941
 415.381.6574

OPEN SPACE

OPEN SPACE REQUIREMENTS - 06.30.20			
	PRIVATE REQUIRED 100 SQ.FT./UNIT	COMMON REQUIRED 133 SQ.FT./UNIT	
	PRIVATE SPACE PROVIDED (SQ.FT.)	COMMON SPACE REQUIRED (SQ.FT.)	
1st FLOOR:	101	107	0
2nd FLOOR:	201	0	133
	202	0	133
	203	0	133
	204	0	133
3rd FLOOR:	301	0	133
	302	0	133
	303	0	133
	304	0	133
4th FLOOR:	401	0	133
	402	0	133
	403	517	0
5th FLOOR:	501	0	133
	502	0	133
	503	0	133
COMMON OPEN SPACE SQ.FT. REQUIRED		1,729	
COMMON OPEN SPACE ON 1ST FLOOR PROVIDED		211	
COMMON OPEN SPACE ROOF PROVIDED		1,532	
TOTAL COMMON OPEN SPACE PROVIDED		1,743	

DRAWING SCHEDULE


TOTAL SHEET COUNT: 26

- ARCHITECTURAL**
- A1.0 SITE & CITY INFO.
 - 1 of 1 SURVEY
 - GS1 SITE PERMIT GREENPOINT CHECKLIST
 - A1.1 PROPOSED SITE PLAN
 - A1.2 EXITING
 - A1.3 EXITING
 - A1.4 EXISTING SITE PLAN
 - A1.5 PROPOSED DEMO PLAN
 - A1.6 EXISTING EXTERIOR ELEVATIONS
 - A1.7 EXISTING EXTERIOR ELEVATIONS
 - A1.8 EXISTING EXTERIOR ELEVATIONS
 - A1.9 PROPOSED EXTERIOR AXONS
 - A1.10 PROPOSED EXTERIOR PERSPECTIVES
 - A2.0a DOOR SCHEDULES
 - A2.0b WINDOW SCHEDULES & DETAILS
 - A2.1 1ST FLOOR
 - A2.2 2ND FLOOR
 - A2.3 3RD FLOOR
 - A2.4 4TH FLOOR
 - A2.5 5TH FLOOR
 - A2.6 ROOF PLAN
 - A3.0 EXTERIOR ELEVATIONS
 - A3.1 EXTERIOR ELEVATIONS
 - A4.0 SECTIONS
 - A5.0 ADA DETAILS
 - A5.1 ADA DETAILS

CALGREEN PLUMBING FIXTURE FLOW RATES

- PER 2016 CALIFORNIA GREEN BUILDING STANDARDS CODE (CGBSC):
- WATER CLOSET:
 - EFFECTIVE FLUSH VOLUME SHALL NOT EXCEED 1.28 GALLONS PER FLUSH.
 - TANK-TYPE WATER CLOSETS SHALL BE CERTIFIED TO THE CRITERIA OF THE U.S. EPA WATERSENSE SPECIFICATION.
 - EFFECTIVE FLUSH VOLUME OF DUAL-FLUSH TOILETS IS DEFINED AS THE COMPOSITE, AVERAGE FLUSH VOLUME OF TWO REDUCED FLUSHES AND ONE FULL FLUSH.
 - URINALS:
 - EFFECTIVE FLUSH VOLUME IS .5 GALLONS PER FLUSH.
 - SHOWER HEADS:
 - SINGLE SHOWER HEADS SHALL HAVE A MAXIMUM FLOW RATE OF NOT MORE THAN 2.0 GALLONS PER MINUTE AT 80 PSI.
 - SHOWER HEADS SHALL BE CERTIFIED TO THE CRITERIA OF THE U.S. EPA WATERSENSE SPECIFICATION.
 - WHEN MULTIPLE SHOWER HEADS SERVE A SINGLE SHOWER, THE COMBINED FLOW RATE OF ALL SHOWER HEADS AND/OR OTHER SHOWER OUTLETS CONTROLLED BY A SINGLE VALVE SHALL NOT EXCEED 2.0 GALLONS PER MINUTE AT 80 PSI, OR THE SHOWER WILL BE DESIGNED TO ALLOW ONLY ONE SHOWER OUTLET TO BE IN OPERATION AT A TIME.
 - A HANDHELD SHOWER SHALL BE CONSIDERED A SHOWERHEAD.
 - FAUCETS:
 - RESIDENTIAL LAVATORY FAUCETS SHALL NOT EXCEED A MAXIMUM FLOW RATE OF 1.2 GALLONS PER MINUTE AT 80 PSI. THE MINIMUM FLOW RATE SHALL NOT BE LESS THAN .8 GALLONS PER MINUTE AT 20 PSI.
 - LAVATORY FAUCETS IN COMMON AND PUBLIC USE AREAS (OUTSIDE OF DWELLING OR SLEEPING UNITS) IN RESIDENTIAL BUILDINGS SHALL NOT EXCEED A MAXIMUM FLOW RATE OF .5 GALLONS PER MINUTE AT 60 PSI.
 - METERING FAUCETS IN RESIDENTIAL BUILDINGS SHALL NOT DELIVER MORE THAN .2 GALLONS PER CYCLE.
 - KITCHEN FAUCETS SHALL NOT EXCEED A MAXIMUM FLOW RATE OF 1.8 GALLONS PER MINUTE AT 60 PSI. KITCHEN FAUCET MAY TEMPORARILY INCREASE TO 2.2 GALLONS PER MINUTE AT 60 PSI AND MUST DEFAULT TO A MAXIMUM FLOW RATE OF 1.8 GALLONS PER MINUTE AT 60 PSI. WERE COMPLYING FAUCETS ARE UNAVAILABLE, AERATORS OR OTHER MEANS MAY BE USED TO ACHIEVE REDUCTION.
 - PLUMBING FITRES AND FITTINGS SHALL BE INSTALLED IN ACCORDANCE WITH THE CALIFORNIA PLUMBING CODE, AND SHALL MEET THE APPLICABLE STANDARDS REFERENCE IN TABLE 1401.1.

VICINITY MAP

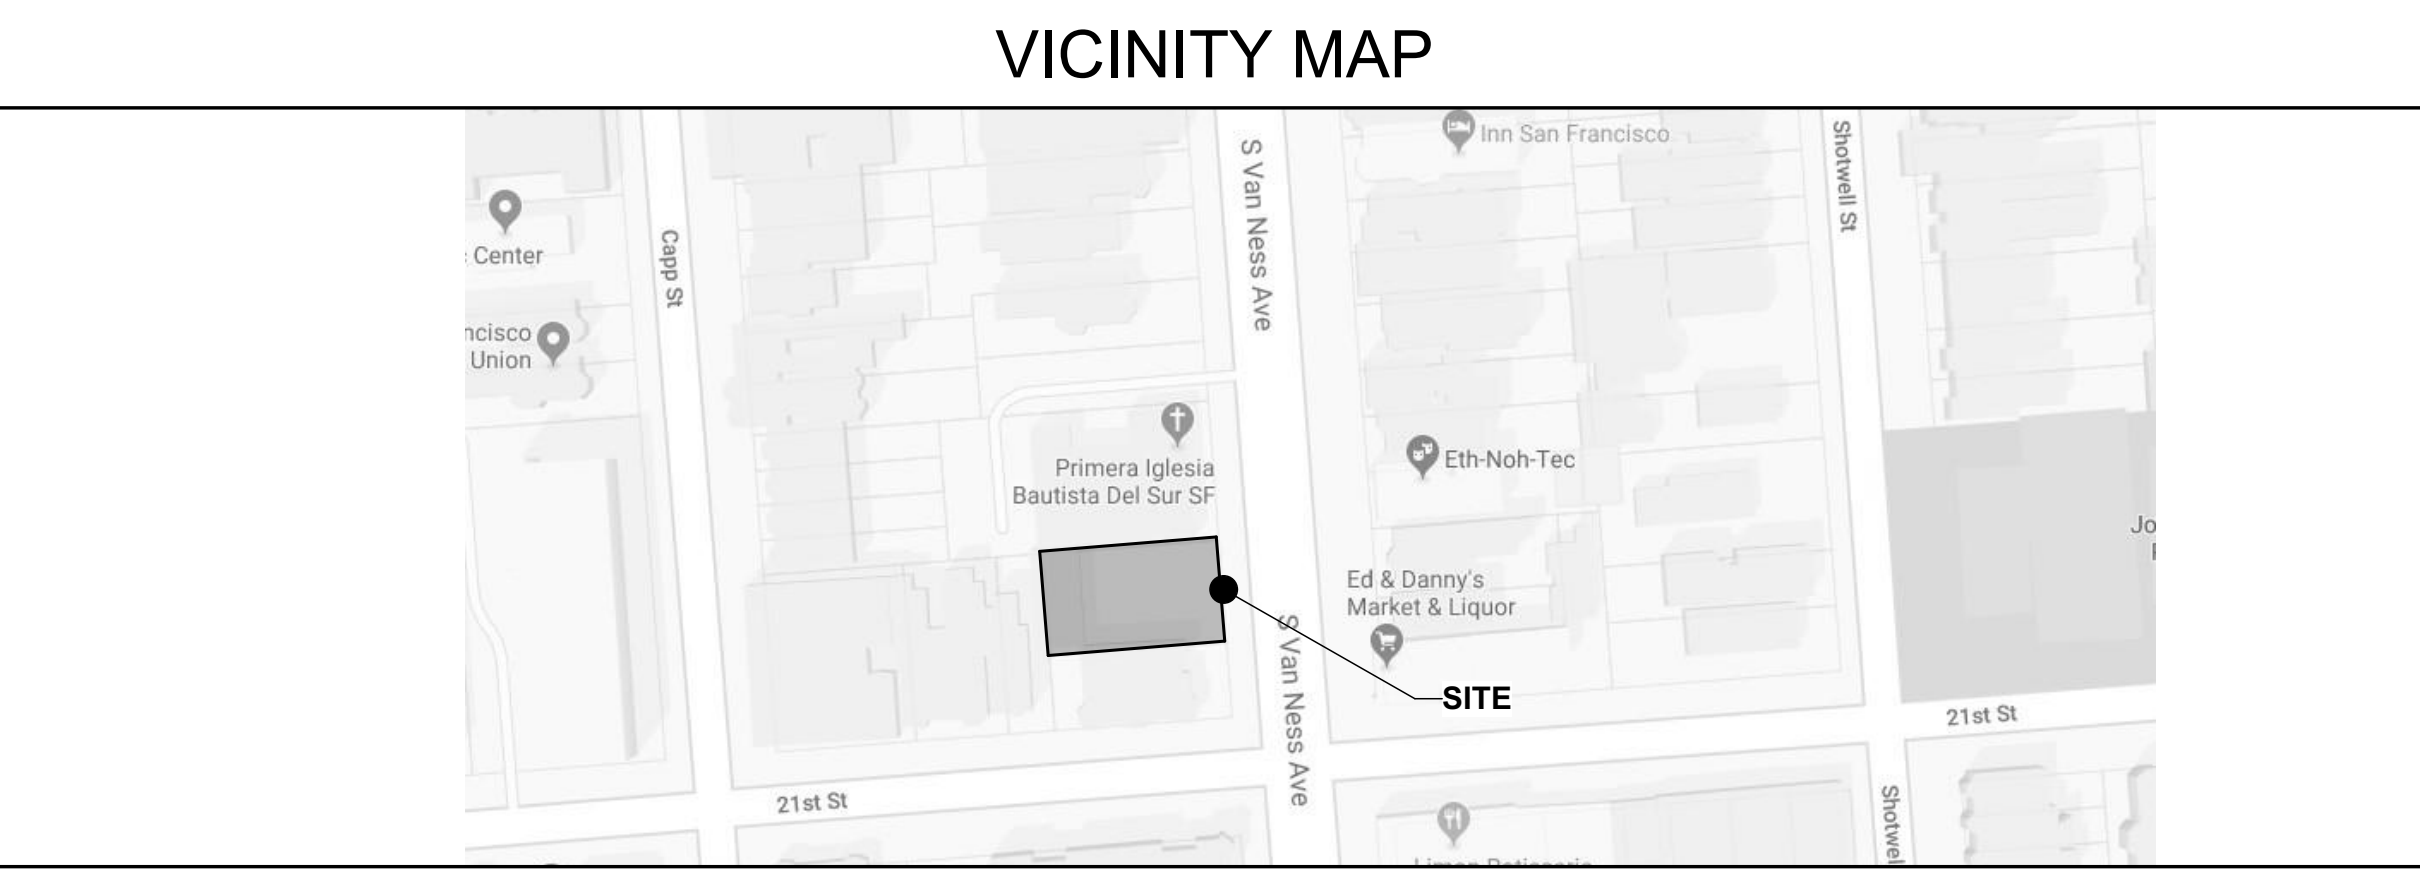

SAN FRANCISCO FIRE DEPARTMENT
 BUREAU OF FIRE PREVENTION
 PLAN CHECK DIVISION / WATER FLOW
 1660 MISSION STREET, 4TH FLOOR
 SAN FRANCISCO, CA 94103
 Email: WaterFlowSFFD@sfgov.org
 Phone: 415-558-6361
 Payment (VISA/MC): 415-558-6177 (M-F: 8am-4pm)

Mitigation Monitoring and Reporting Program
 986 SOUTH VAN NESS AVENUE
 Case No. 2018-01291REV N

San Francisco Planning

REQUEST FOR WATER FLOW INFORMATION


(For additional information, see Water Flow FAQs at: <https://sf.fire.org/plan-check/water/>)

REQUEST IS FOR: FIRE FLOW- YES NO SPRINKLER DESIGN- YES NO

DATE: 02.14.20

CONTACT PERSON: TONY PANTALEONI ADDRESS: 70 ZOE SUITE 200, S.F., CA 94107
 PHONE #: 415.495.4051 EMAIL: TONY@KP-ARCHITECTS.COM
 OWNER'S NAME: LUCAS EASTWOOD PHONE #: 415-341-0473

ADDRESS FOR WATER FLOW INFORMATION: 986 SOUTH VAN NESS
 CROSS STREETS (BOTH ARE REQUIRED): 20TH STREET & 21ST STREET
 SPECIFY STREET FOR WATER DEPT CONNECTION: SOUTH VAN NESS
 PROVIDE PROJECT LOCATION SKETCH HERE:

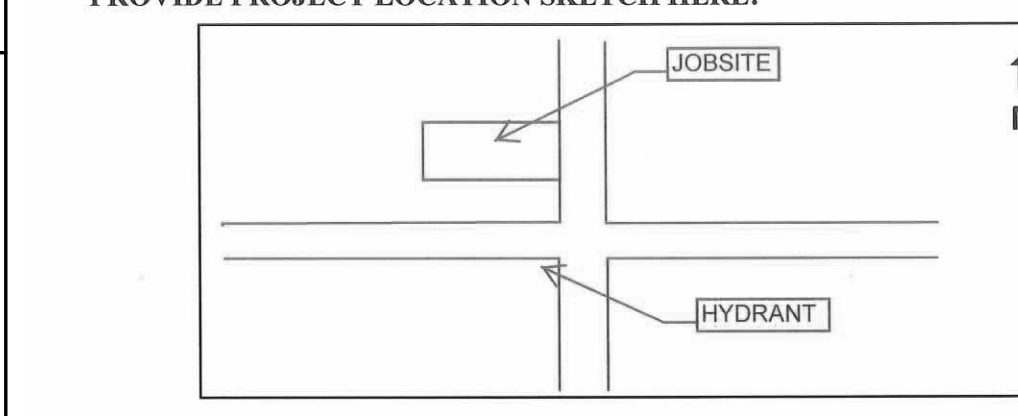

OCCUPANCY TYPE (CIRCLE ONE): R3 R2 LIVEWORK COMMERCIAL OTHER _____
 HAZARD CLASSIFICATION: LIGHT ORD1 ORD2 EXT1 EXT2 OTHER _____
 CAR-STACKER: YES NO

- NUMBER OF STORIES: 5 HEIGHT OF BLDG (FT): 50'-0"
- SUBMIT FORM WITH A \$100.00 CHECK (PAYABLE TO "SFFD") OR PAY BY CREDIT CARD (PHONE # ABOVE)
 - REQUESTS REQUIRING A FIELD FLOW TEST WILL BE NOTIFIED BY EMAIL AND AN ADDITIONAL FEE OF \$200 WILL BE REQUIRED.
 - WATER FLOW INFORMATION WILL BE RETURNED BY EMAIL.
 - INCOMPLETE FORMS WILL NOT BE PROCESSED
 - PLEASE ALLOW FOR A MINIMUM OF 7 TO 14 BUSINESS DAYS FOR PROCESSING

Flow data provided by: LAU Date forwarded: 3/4/20

Flow data:

FIELD FLOW TEST
 RECORDS ANALYSIS
 Gate Page 95/104

STATIC 47 PSI
 RESIDUAL 45 PSI
 FLOW 1000 GPM
 8 INCH MAIN on South Van Ness

COVER SHEET

MITIGATION MONITORING AND REPORTING PROGRAM

The table below indicates when compliance with each mitigation measure must occur. Some mitigation measures span multiple phases. Substantive descriptions of each mitigation measure's requirements are provided on the following pages of the Mitigation Monitoring and Reporting Program. This cover sheet must be included as the title page of the first construction document submitted to the San Francisco Planning Department for review.

Mitigation Measure	Period of Compliance			Compliance with MM completed?
	Prior to the start of Construction*	During Construction	Post-Construction or Operational	
M-AQ-1: Construction Air Quality	X	X		

*Construction is broadly defined to include any physical activities associated with construction of a development project including, but not limited to: site preparation, clearing, demolition, excavation, shoring, foundation installation, and building construction.

Cover page 1

FOR DBI USE

Date: 11.19
 Drawn By: BM
 Job Number: 2-1119

A1.0

**Kotas/
 Pantaleoni
 Architects**
 Anthony A. Pantaleoni
 LEED AP
 70 Zoe Street Suite 200
 San Francisco, California 94107
 t. 415 495 4051
 design@kp-architects.com



Revisions	By
PROGRESS SET 01.15.20	BM
DBI RESPONSE 03.25.20	BM
FIRE RESPONSE 04.07.20	BM
PLANNING REVISIONS 05.06.20	BM
DBI-PLNG RESPONSE 06.30.20	BM

**15 RESIDENTIAL UNITS
 986 SOUTH VAN NESS AVENUE
 SAN FRANCISCO, CA 94110**

Sheet Title:
**Project Info:
 SITE & CITY
 INFO.**

GS1: San Francisco Green Building Site Permit Submittal Form

Form version: February 1, 2018 (For permit applications January 2017 - December 2019)

INSTRUCTIONS:

- Select one (1) column to identify requirements for the project. For addition and alteration projects, applicability of specific requirements may depend upon project scope.
- Provide the Project Information in the box at the right.
- A LEED or GreenPoint Rated Scorecard is not required with the site permit application, but using such tools as early as possible is recommended.
- To ensure legibility of DBI archives, submittal must be a minimum of 24" x 36".
Attachment GS2, GS3, GS4, GS5 or GS6 will be due with the applicable addendum. A separate "FINAL COMPLIANCE VERIFICATION" form will be required prior to Certificate of Completion. For details, see Administrative Bulletin 93. For Municipal projects, additional Environment Code Chapter 7 requirements may apply; see GS6.

CHECK THE ONE COLUMN
THAT BEST DESCRIBES YOUR PROJECT →

LEED/GPR	TITLE	SOURCE OF REQUIREMENT	DESCRIPTION OF REQUIREMENT	NEW CONSTRUCTION				ALTERATIONS + ADDITIONS					
				LOW-RISE RESIDENTIAL R 1-3 Floors	HIGH-RISE RESIDENTIAL R 4+ Floors	LARGE NON-RESIDENTIAL A,B,E,I,M 25,000 sq.ft. or greater	OTHER NON-RESIDENTIAL F,H,L,S,U or A,B,E,I,M less than 25,000 sq.ft.	RESIDENTIAL MAJOR ALTERATIONS + ADDITIONS R 25,000 sq.ft. or greater	OTHER RESIDENTIAL ALTERATIONS + ADDITIONS R adds any amount of conditioned area	NON-RESIDENTIAL MAJOR ALTERATIONS + ADDITIONS B,M 25,000 sq.ft. or greater	FIRST-TIME NON-RESIDENTIAL INTERIORS A,B,I,M 25,000 sq.ft. or greater	OTHER NON-RESIDENTIAL INTERIORS, ALTERATIONS + ADDITIONS A,B,E,F,H,L,I,M,S,U more than 1,000 sq.ft. or \$200,000	
	Project is required to achieve sustainability certification listed at right.	SFGBC 4.103.1.1, 4.103.2.1, 4.103.3.1, 5.103.1.1, 5.103.3.1 & 5.103.4.1		<input type="checkbox"/>	<input type="checkbox"/>	<input type="checkbox"/>	<input type="checkbox"/>	<input type="checkbox"/>	<input type="checkbox"/>	<input type="checkbox"/>	<input type="checkbox"/>	<input type="checkbox"/>	<input type="checkbox"/>
	Enter any applicable point adjustments in box at right.	SFGBC 4.104, 4.105, 5.104 & 5.105											
	Use products that comply with the emission limit requirements of 4.504.2.1-5, 5.504.4.1-6 for adhesives, sealants, paints, coatings, carpet systems including cushions and adhesives, resilient flooring (80% of area), and composite wood products. Major alterations to existing residential buildings must use low-emitting coatings, adhesives and sealants, and carpet systems that meet the requirements for GPR measures K2, K3 and L2 or LEED EQc2, as applicable. New large non-residential interiors and major alterations to existing residential and non-residential buildings must also use interior paints, coatings, sealants, and adhesives when applied on-site, flooring and composite wood that meet the requirements of LEED credit Low-Emitting Materials (EQc2).	CALGreen 4.504.2.1-5 & 5.504.4.1-6, SFGBC 4.103.3.2, 5.103.1.9, 5.103.3.2 & 5.103.4.2		<input type="checkbox"/>	<input type="checkbox"/>	<input type="checkbox"/>	<input type="checkbox"/>	<input type="checkbox"/>	<input type="checkbox"/>	<input type="checkbox"/>	<input type="checkbox"/>	<input type="checkbox"/>	<input type="checkbox"/>
	Meet flush/flow requirements for: toilets (1.28gpf); urinals (0.125gpf wall, 0.5gpf floor); showerheads (2.0gpm); lavatories (1.2gpm private, 0.5gpm public/common); kitchen faucets (1.8gpm); wash fountains (1.8gpm); metering faucets (0.2gpc); food waste disposers (1gpm/8gpm). Residential projects must upgrade all non-compliant fixtures per SF Housing Code sec. 12A10. Large non-residential interiors, alterations & additions must upgrade all non-compliant fixtures per SF Building Code ch. 13A. New large non-residential buildings must also achieve minimum 30% indoor potable water use reduction as calculated to meet LEED credit Indoor Water Use Reduction (WEc2).	CALGreen 4.303.1 & 5.303.3, SFGBC 5.103.1.2, SF Housing Code sec. 12A10, SF Building Code ch. 13A											
	New buildings ≥ 40,000 sq. ft. must calculate a water budget. New buildings ≥250,000 sq. ft. must treat and use available rainwater, graywater, and foundation drainage and use in toilet and urinal flushing and irrigation. See www.sfwater.org for details.	Health Code art.12C											
	New construction projects with aggregated landscape area ≥500 sq. ft., or existing projects with modified landscape area ≥1,000 sq. ft. shall use low water use plants or climate appropriate plants, restrict turf areas and comply with Model Water Efficient Landscape Ordinance restrictions by calculated ETAF (.55 for residential, .45 for non-residential or less) or by prescriptive compliance for projects with ≤2,500 sq. ft. of landscape area. See www.sfwater.org for details.	Administrative Code ch.63											
	Provide submeters for spaces projected to consume >1,000gal/day (or >100gal/day in buildings >50,000 sq. ft.).	CALGreen 5.303.1											
	Comply with all provisions of the CA Title 24 Part 6 Energy Standards.	CA Energy Code											
	New non-residential buildings >2,000 sq. ft. and ≤10 occupied floors, and new residential buildings of any size and ≤10 occupied floors, must designate 15% of roof Solar Ready, per Title 24 rules. Install photovoltaics or solar hot water systems in this area. With Planning Department approval, projects subject to SFPUC Stormwater Requirements may substitute living roof for solar energy systems.	SFGBC 4.201.1 & 5.201.1.2											
	Non-residential buildings with ≥11 floors must acquire at least 1% of energy from on-site renewable sources, purchase green energy credits, or achieve 5 points under LEED credit Optimize Energy Performance (EAc2).	SFGBC 5.201.1.3											
	For projects ≥10,000 sq. ft. include OPR, BOD, and commissioning plan in design & construction. Commission to comply. Alterations & additions with new HVAC equipment must test and adjust all equipment.	CALGreen 5.410.2 - 5.410.4.5.1											
	Provide short- and long-term bike parking equal to 5% of motorized vehicle parking, or meet SF Planning Code sec.155.1-2, whichever is greater.	CALGreen 5.106.4 Planning Code 155.1-2											
	Mark 8% of total parking stalls for low-emitting, fuel efficient, and carpool/van pool vehicles.	CALGreen 5.106.5.2											
	Permit application January 2018 or after: Construct all new off-street parking spaces for passenger vehicles and trucks with dimensions capable of installing EVSE. Install service capacity and panels/sufficient to provide ≥40A 208 or 240V to EV chargers at 20% of spaces. Install ≥40A 208 or 240V branch circuits to ≥10% of spaces, terminating close to the proposed EV charger location. Installation of chargers is not required. Projects with zero off-street parking exempt. See SFGBC 4.106.4 or SFGBC 5.106.5.3 for details. Permit applications prior to January 2018 only: Install infrastructure to provide electricity for EV chargers at 6% of spaces for non-residential (CALGreen 5.106.5.3), 3% of spaces for multifamily with ≥17 units (CALGreen 4.106.4.2), and each space in 1-2 unit dwellings (CALGreen 4.106.4.1). Installation of chargers is not required.	SFGBC 4.106.4 & 5.106.5.3											
	Provide adequate space and equal access for storage, collection and loading of compostable, recyclable and landfill materials.	SF Building Code AB-089											
	For 100% of mixed C&D debris use registered transporters and registered processing facilities with a minimum of 65% diversion rate. Divert a minimum of 75% of total C&D debris if noted.	SFGBC 4.103.2.3 & 5.103.1.3.1, Environment Code ch.14, SF Building Code ch.13B											
	Installers must be trained and certified in best practices.	CALGreen 4.702.1											
	HVAC shall be designed to ACCA Manual J, D, and S.	CALGreen 4.507.2											
	Use no halons or CFCs in HVAC.	CALGreen 5.508.1											
	Comply with CA Energy Code for Lighting Zones 1-4. Comply with 5.106.8 for Backlight/Uplight/Glare.	CA Energy Code, CALGreen 5.106.8											
	Glass facades and bird hazards facing and/or near Urban Bird Refuges may need to treat their glass for opacity.	Planning Code sec.139											
	For non-residential projects, prohibit smoking within 25 feet of building entries, air intakes, and operable windows. For residential projects, prohibit smoking within 10 feet of building entries, air intakes, and operable windows and enclosed common areas.	CALGreen 5.504.7, Health Code art.19F											
	Projects disturbing ≥5,000 sq. ft. in combined or separate sewer areas, or replacing ≥2,500 impervious sq. ft. in separate sewer area, must implement a Stormwater Control Plan meeting SFPUC Stormwater Management Requirements. See www.sfwater.org for details.	Public Works Code art.4.2 sec.147											
	Provide a construction site Stormwater Pollution Prevention Plan and implement SFPUC Best Management Practices. See www.sfwater.org for details.	Public Works Code art.4.2 sec.146											
	Non-residential projects must comply with sound transmission limits (STC-50 exteriors near freeways/airports; STC-45 exteriors if 65db Leq at any time; STC-40 interior walls/floor-ceilings between tenants). New residential projects' interior noise due to exterior sources shall not exceed 45dB.	CALGreen 5.507.4.1-3, SF Building Code sec.1207											
	Seal permanent HVAC ducts/equipment stored onsite before installation.	CALGreen 4.504.1-3 & 5.504.1-3											
	Non-residential projects must provide MERV-8 filters on HVAC for regularly occupied, actively ventilated spaces. Residential new construction and major alteration & addition projects in Air Pollutant Exposure Zones per SF Health Code art.38 must provide MERV-13 filters on HVAC.	CALGreen 5.504.5.3, SF Health Code art.38											
	During construction, meet SMACNA IAQ guidelines; provide MERV-8 filters on all HVAC.	SFGBC 5.103.1.8											
	Show how surface drainage (grading, swales, drains, retention areas) will keep surface water from entering the building.	CALGreen 4.106.3											
	Seal around pipe, cable, conduit, and other openings in exterior walls with cement mortar or DBI-approved similar method.	CALGreen 4.406.1											
	Install only direct-vent or sealed-combustion, EPA Phase II-compliant appliances.	CALGreen 4.503.1											
	Slab on grade foundation requiring vapor retarder also requires a capillary break such as: 4 inches of base 1/2-inch aggregate under retarder; slab design specified by licensed professional.	CALGreen 4.505.2											
	Wall and floor wood framing must have <19% moisture content before enclosure.	CALGreen 4.505.3											
	Must be ENERGY STAR compliant, ducted to building exterior, and its humidistat shall be capable of adjusting between <50% to >80% (humidistat may be separate component).	CALGreen 4.506.1											

PROJECT INFO

PROJECT NAME
3610/010

BLOCK/LOT
986 S. VAN NESS

ADDRESS
R-2

PRIMARY OCCUPANCY
15,401

GROSS BUILDING AREA
01.15.20

DESIGN PROFESSIONAL
or PERMIT APPLICANT
(sign & date)

Kotas/
Pantaleoni
Architects

Anthony A. Pantaleoni
LEED AP
70 Zee Street Suite 200
San Francisco, California 94107
t 415 496 4051
design@kp-architects.com

Revisions	By
PROGRESS SET 01.15.20	BM
DBI RESPONSE 03.25.20	BM
FIRE RESPONSE 04.07.20	BM
PLANNING REVISIONS 05.06.20	BM
DBI-PLNG RESPONSE 06.30.20	BM

15 RESIDENTIAL UNITS
986 SOUTH VAN NESS AVENUE
SAN FRANCISCO, CA 94110


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**Project Info:
GREENPOINT
CHECKLIST**

Date: 11.19

Drawn By: BM

Job Number: 2-1119

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Kotas/
Pantaleoni
Architects
Anthony A. Pantaleoni
LEED AP
712 Zee Street Suite 200
San Francisco, California 94107
t. 415 496 4051
design@kpa-architects.com

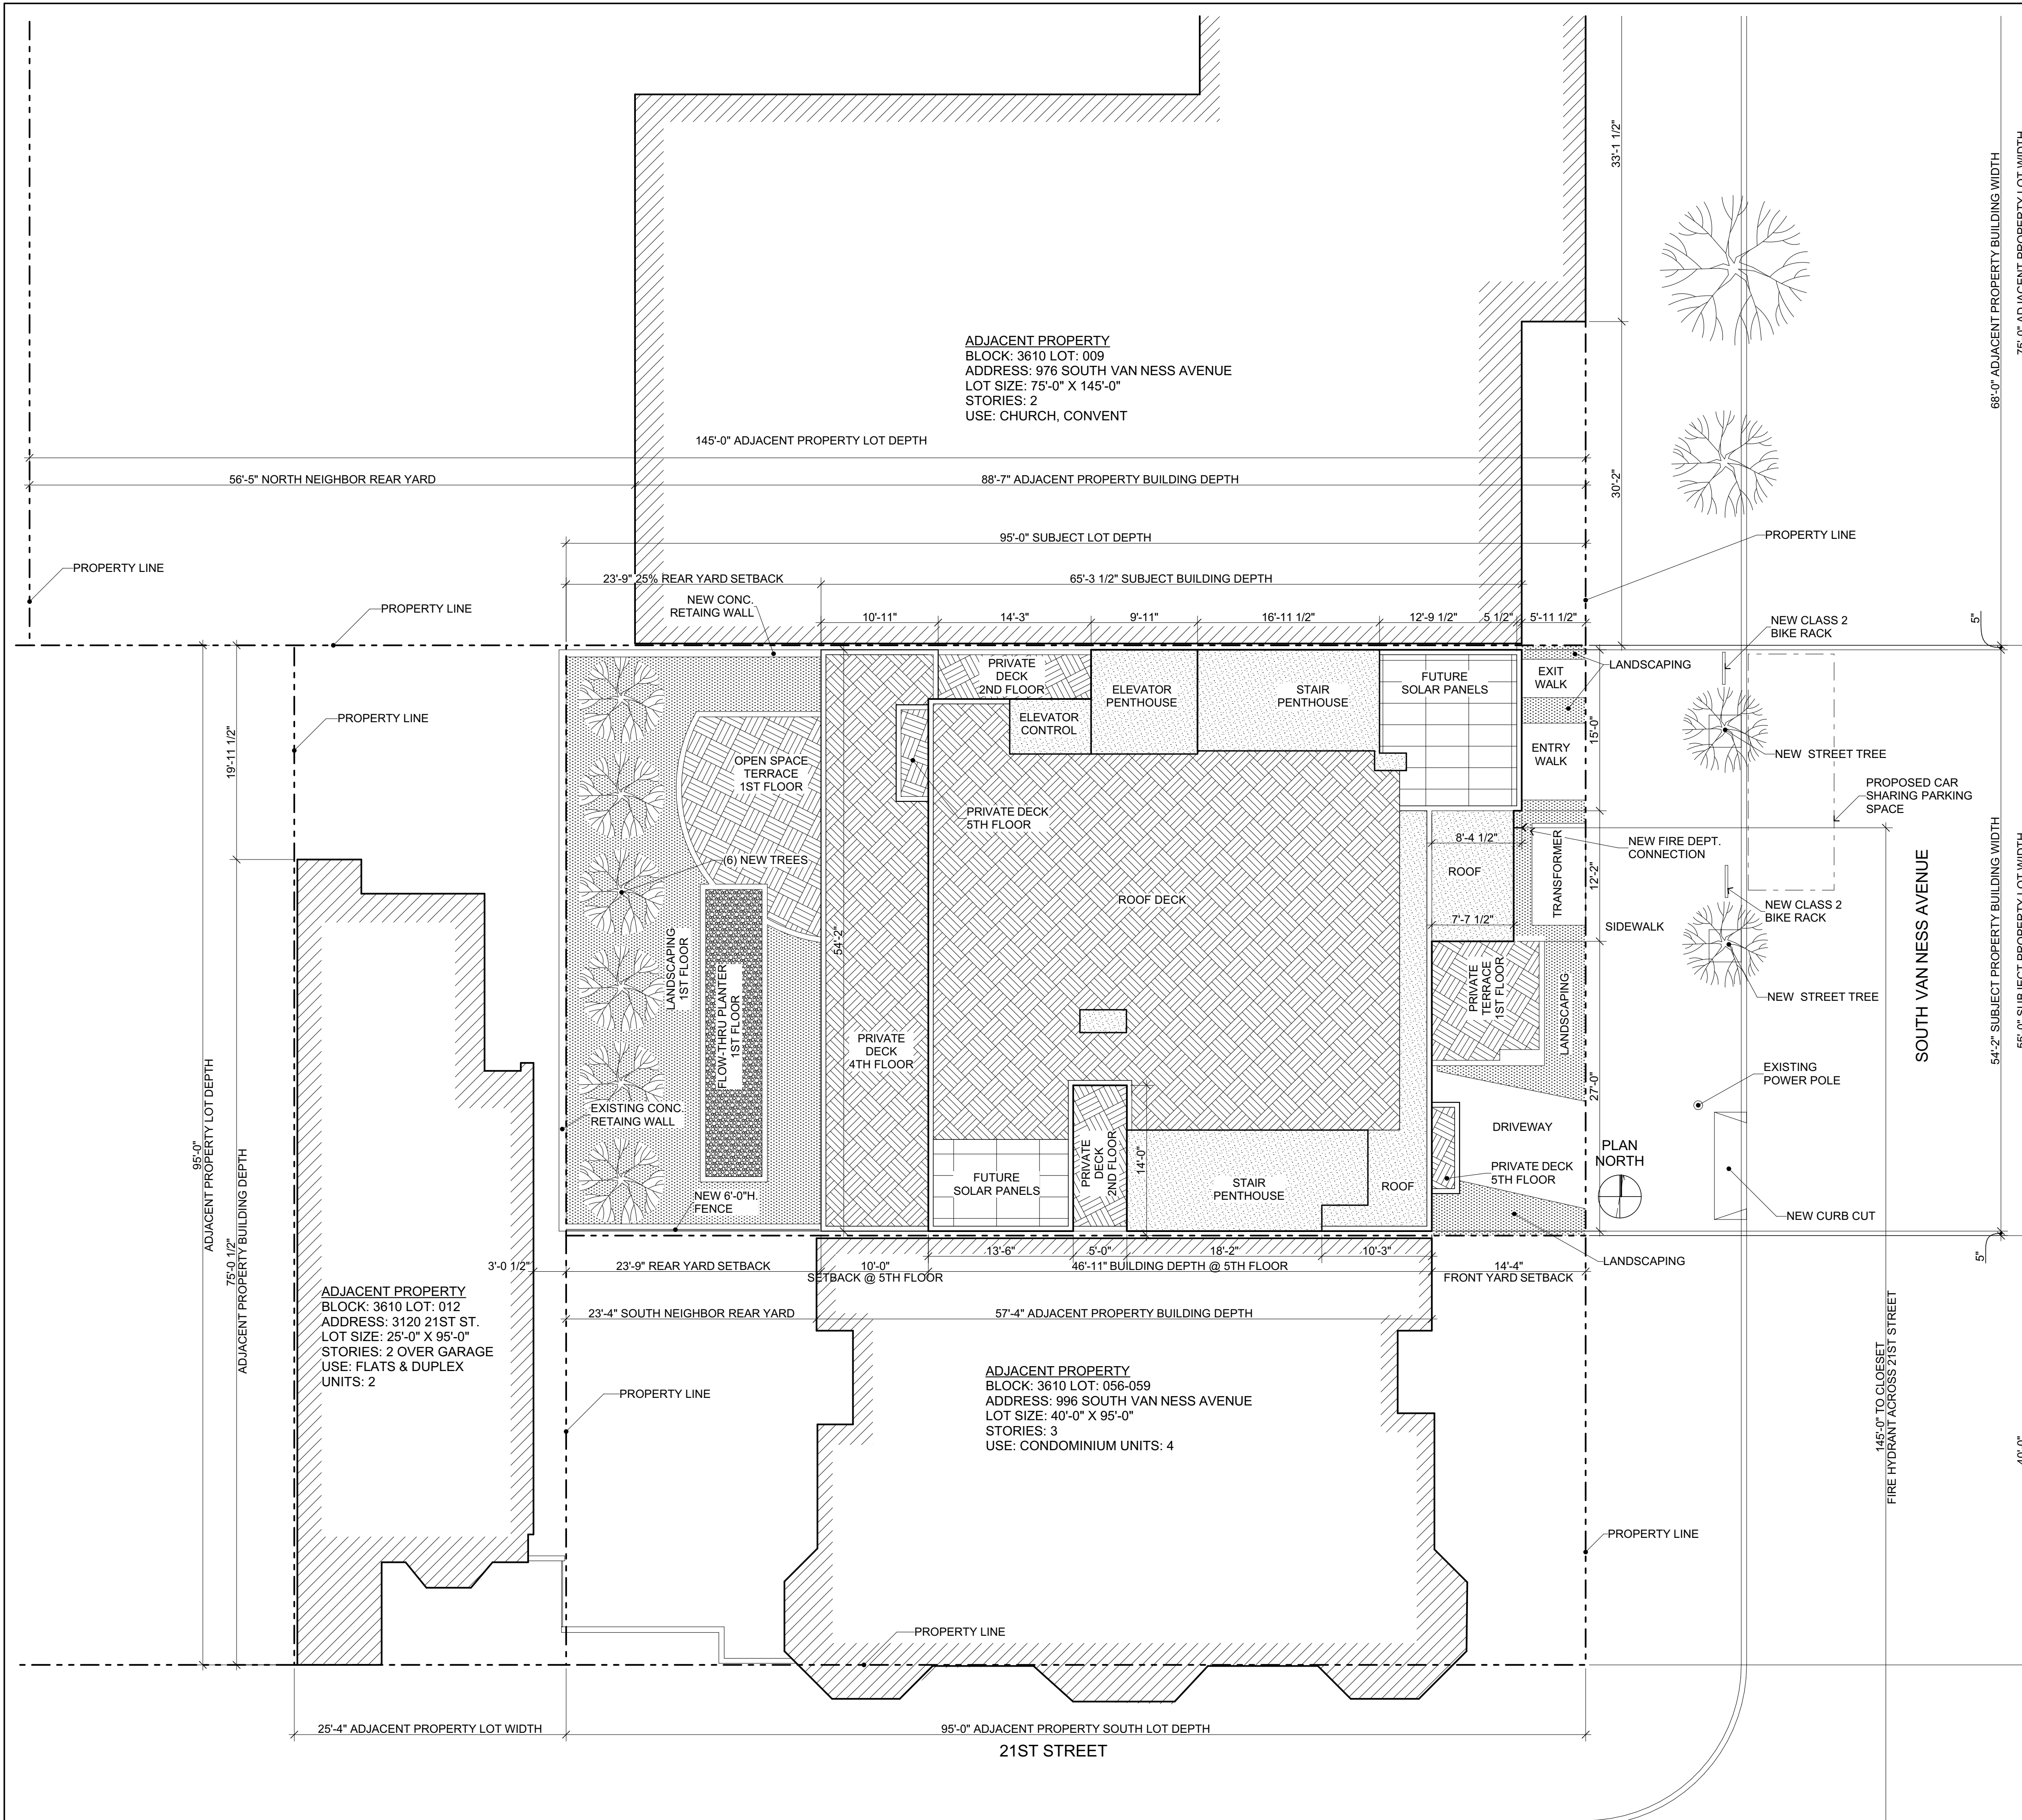

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15 RESIDENTIAL UNITS
986 SOUTH VAN NESS AVENUE
SAN FRANCISCO, CA 94110

Sheet Title:
Project Info:
SITE PLAN

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Drawn By: BM
Job Number: 2-1119

A1.1

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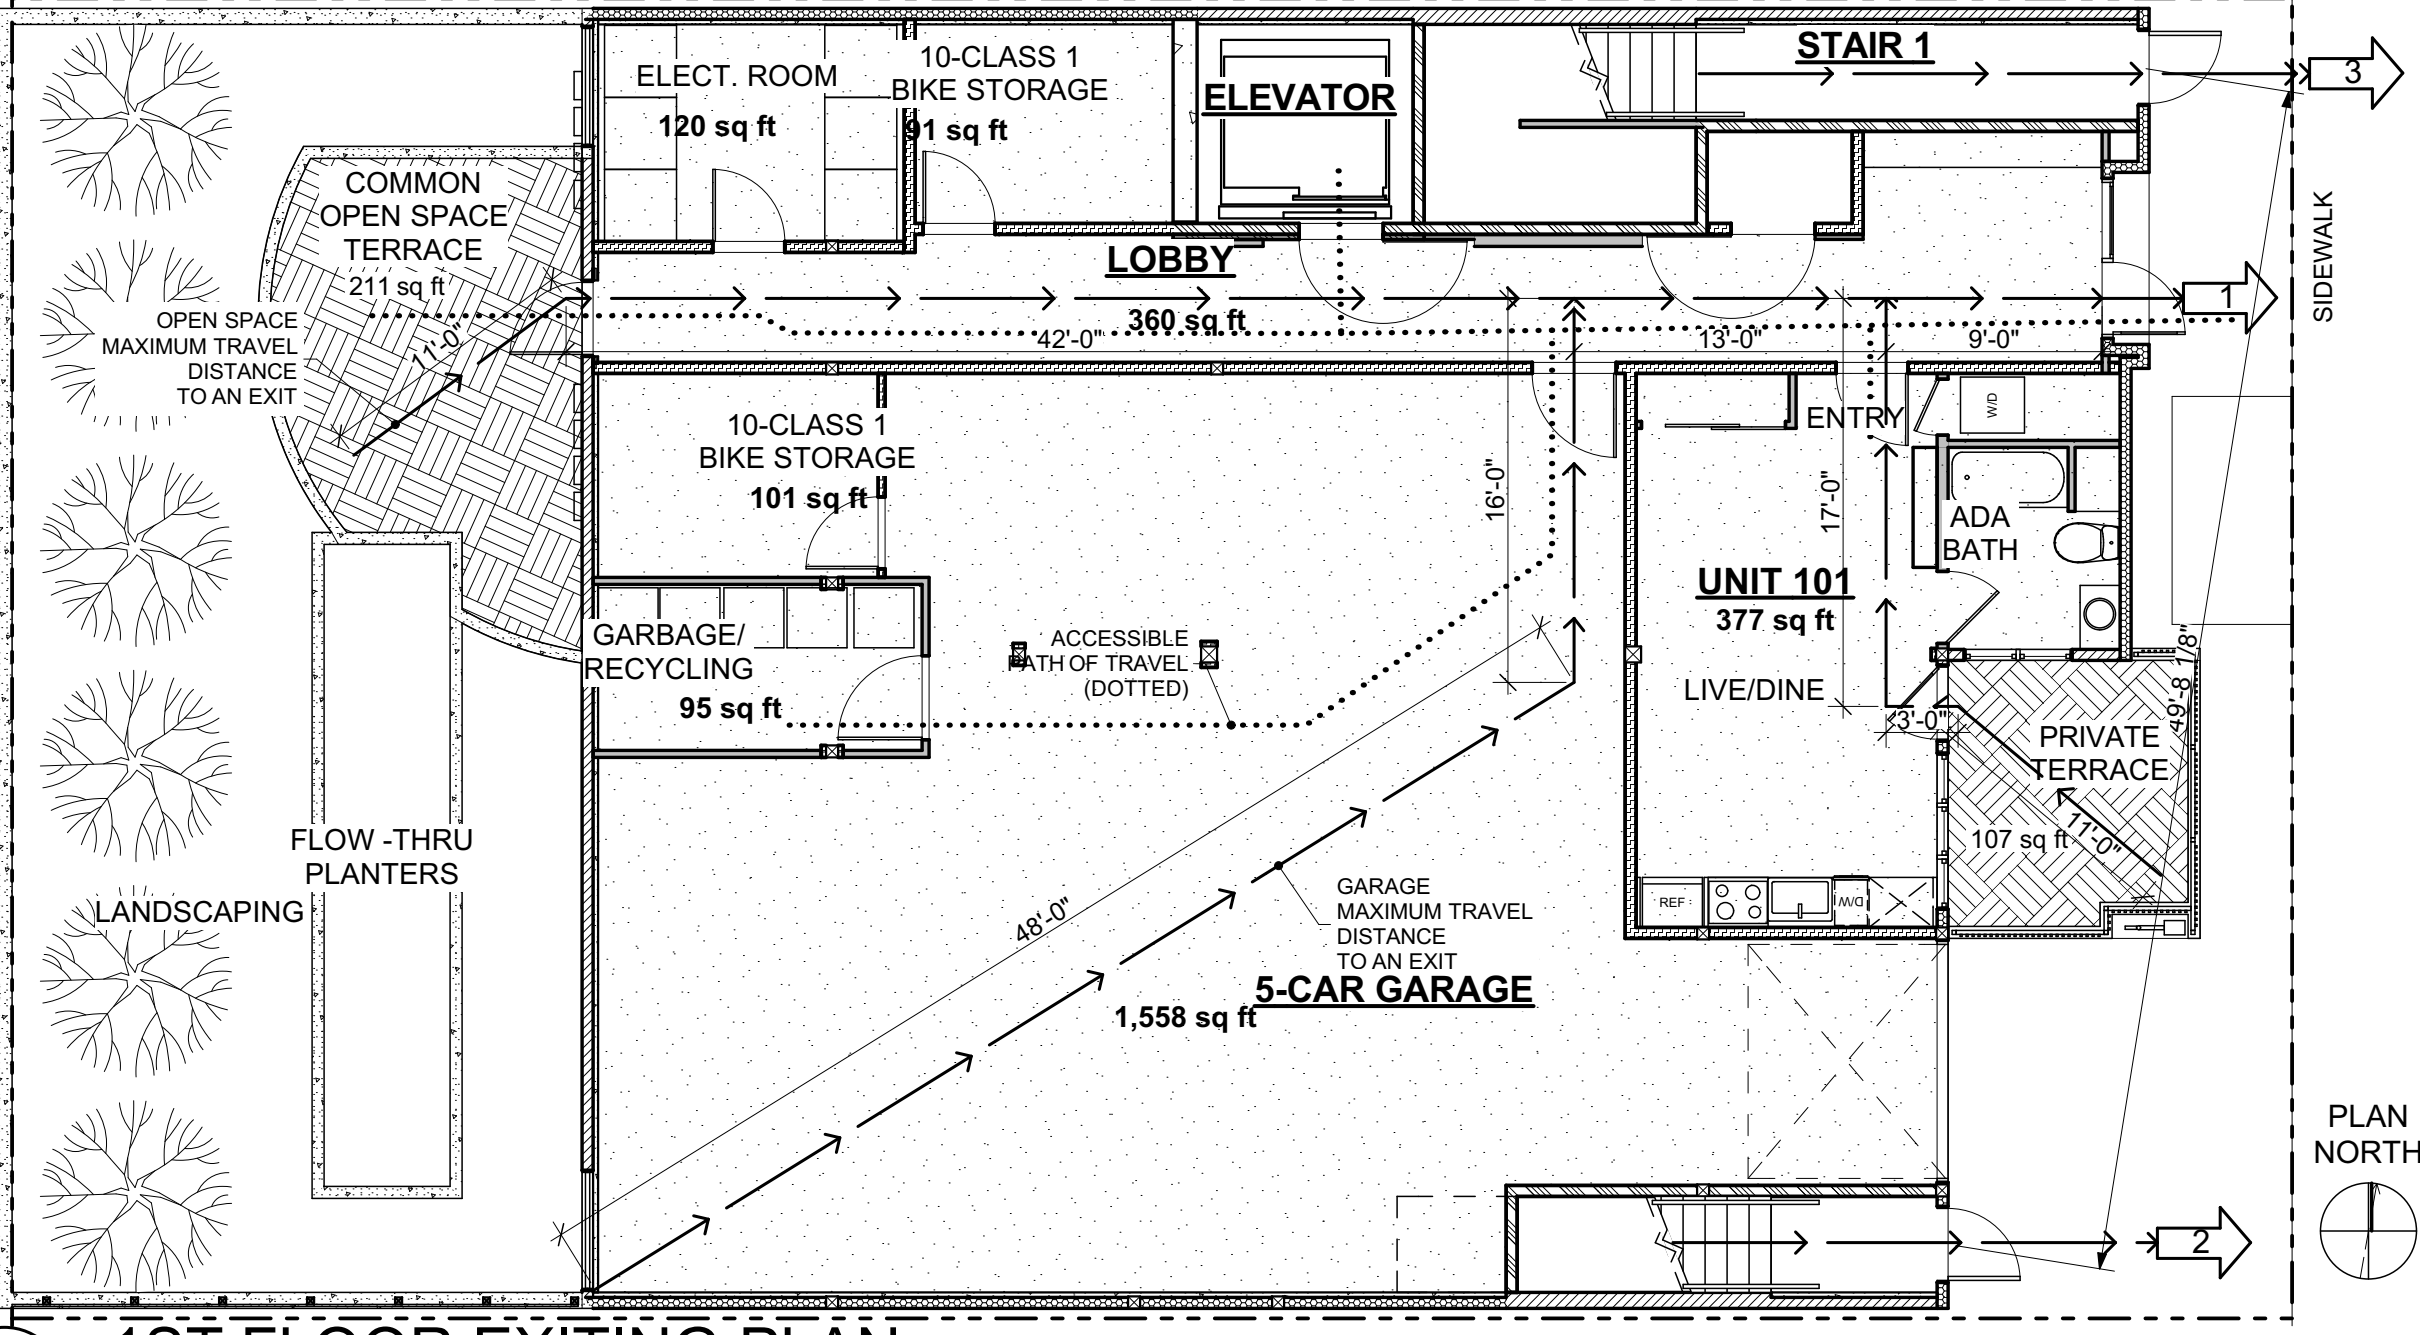
15 RESIDENTIAL UNITS
986 SOUTH VAN NESS AVENUE
SAN FRANCISCO, CA 94110

Sheet Title:
Project Info:
EXITING

Date: 11.19
Drawn By: BM
Job Number: 2-1119


A1.2

FLOOR AREAS	MAXIMUM TRAVEL DISTANCE	EXIT ROUTE 1
GARAGE = 1558 SQ.FT. BIKE STORAGE = 101 SQ.FT. BIKE STORAGE = 91 SQ.FT. GARBAGE = 95 SQ.FT. LOBBY = 360 SQ.FT. ELECT. = 120 SQ.FT. COMMON OPEN SPACE = 211 SQ.FT. RESIDENTIAL = 377 SQ.FT. RESIDENTIAL TERRACE = 107 SQ.FT.	GARAGE: ALLOWED PER TABLE 1017.2 = 250'-0" PROPOSED = 86'-0" OPEN SPACE: ALLOWED PER TABLE 1017.2 = 75'-0" PROPOSED = 75'-0" RESIDENTIAL: ALLOWED PER TABLE 1017.2 = 250'-0" PROPOSED = 40'-0"	(GARAGE) 1558 SQ.FT. TOTAL 1558 SQ.FT./200 = 8 OCCUPANTS (BIKE STORAGE) 101 SQ.FT. TOTAL 101 SQ.FT./300 = 1 OCCUPANTS (BIKE STORAGE) 91 SQ.FT. TOTAL 91 SQ.FT./300 = 1 OCCUPANTS (GARBAGE) 95 SQ.FT. TOTAL 95 SQ.FT./300 = 1 OCCUPANTS (LOBBY) 360 SQ.FT. TOTAL 360 SQ.FT./200 = 2 OCCUPANTS (ELECT.) 120 SQ.FT. TOTAL 120 SQ.FT./300 = 1 OCCUPANTS (OPEN SPACE) 211 SQ.FT. TOTAL 211 SQ.FT./15 = 14 OCCUPANTS (RESIDENTIAL) 377 FT. TOTAL 377 SQ.FT./200 = 2 OCCUPANTS (TERRACE) 107 FT. TOTAL 107 SQ.FT./200 = 1 OCCUPANTS TOTAL OCCUPANTS = 31 31 X .2 = 6.20' REQUIRED DOOR WIDTH 36" PROVIDED




1 1ST FLOOR EXITING PLAN
SCALE: 1/8" = 1'-0"

FLOOR AREAS	MAXIMUM TRAVEL DISTANCE	EXIT ROUTE 2	EXIT ROUTE 3	EXIT SEPARATION COMMON PATH OF TRAVEL
RESIDENTIAL UNIT 201= 549 SQ.FT. RESIDENTIAL UNIT 202= 514 SQ.FT. RESIDENTIAL UNIT 203= 646 SQ.FT. RESIDENTIAL UNIT 204= 588 SQ.FT. CORRIDOR = 266 SQ.FT. PRIVATE DECK = 66 SQ.FT. PRIVATE DECK = 59 SQ.FT.	RESIDENTIAL UNITS ALLOWED PER TABLE 1017.2 = 250'-0" PROPOSED = 88'-0"	(RESIDENTIAL 201) 549 SQ.FT. TOTAL 549 SQ.FT./200 = 3 OCCUPANTS (RESIDENTIAL 202) 514 SQ.FT. TOTAL 514 SQ.FT./200 = 3 OCCUPANTS (RESIDENTIAL 203) 646 Q.FT. TOTAL 646 Q.FT./200 = 4 OCCUPANTS (RESIDENTIAL 204) 588 SQ.FT. TOTAL 588 SQ.FT./200 = 3 OCCUPANTS (PRIVATE DECK) 66 SQ.FT. TOTAL 66 SQ.FT./200 = 1 OCCUPANTS (PRIVATE DECK) 59 SQ.FT. TOTAL 66 SQ.FT./200 = 1 OCCUPANTS (CORRIDOR) 266 SQ.FT. TOTAL 266 SQ.FT./200 = 2 OCCUPANTS 17 TOTAL OCCUPANTS 17/2 = 8 OCCUPANTS PER CBC 1005.5 9 X .2 = 1.80' REQUIRED DOOR WIDTH 36" PROVIDED 9 X .3 = 2.70' REQUIRED STAIR WIDTH 48" PROVIDED	(RESIDENTIAL 201) 549 SQ.FT. TOTAL 549 SQ.FT./200 = 3 OCCUPANTS (RESIDENTIAL 202) 514 SQ.FT. TOTAL 514 SQ.FT./200 = 3 OCCUPANTS (RESIDENTIAL 203) 646 Q.FT. TOTAL 646 Q.FT./200 = 4 OCCUPANTS (RESIDENTIAL 204) 588 SQ.FT. TOTAL 588 SQ.FT./200 = 3 OCCUPANTS (PRIVATE DECK) 66 SQ.FT. TOTAL 66 SQ.FT./200 = 1 OCCUPANTS (PRIVATE DECK) 59 SQ.FT. TOTAL 66 SQ.FT./200 = 1 OCCUPANTS (CORRIDOR) 266 SQ.FT. TOTAL 266 SQ.FT./200 = 2 OCCUPANTS 17 TOTAL OCCUPANTS 17/2 = 8 OCCUPANTS PER CBC 1005.5 9 X .2 = 1.80' REQUIRED DOOR WIDTH 36" PROVIDED 9 X .3 = 2.70' REQUIRED STAIR WIDTH 48" PROVIDED	DIAGONAL DISTANCE = 83'-7" 1/3 OF 83'-7" = 27'-10" DISTANCE PROVIDED = 40'-5"

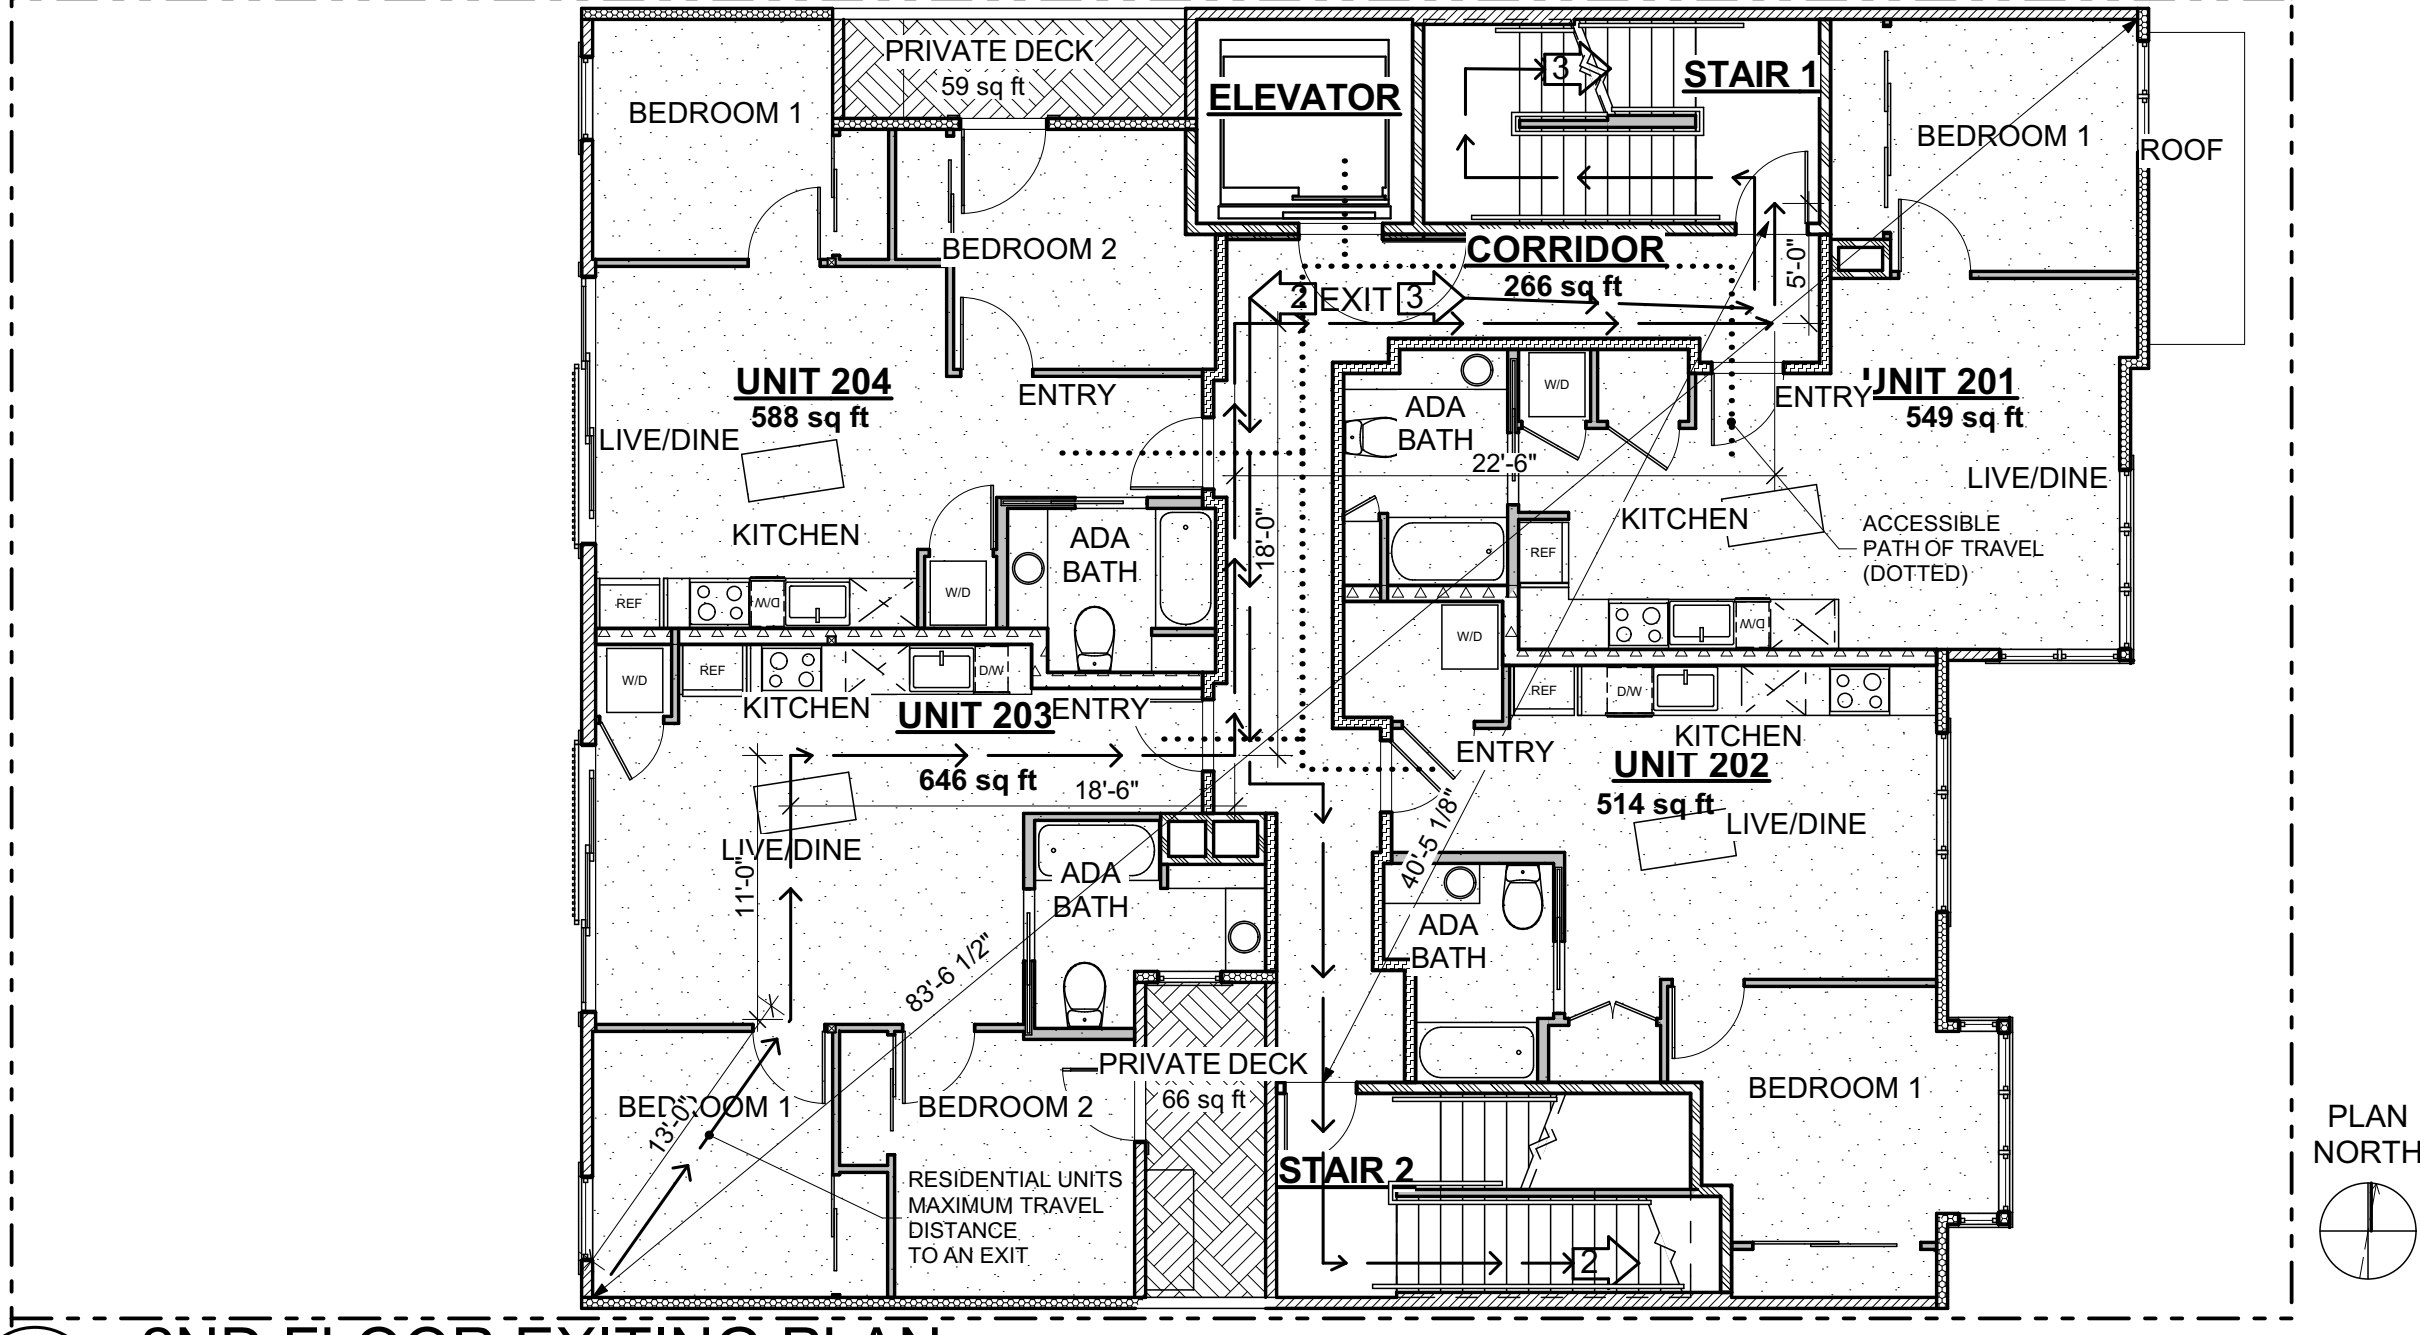


2 2ND FLOOR EXITING PLAN
SCALE: 1/8" = 1'-0"

FLOOR AREAS	MAXIMUM TRAVEL DISTANCE	EXIT ROUTE 2	EXIT ROUTE 3	EXIT SEPARATION COMMON PATH OF TRAVEL
RESIDENTIAL UNIT 301= 549 SQ.FT. RESIDENTIAL UNIT 302= 520 SQ.FT. RESIDENTIAL UNIT 303= 646 SQ.FT. RESIDENTIAL UNIT 204= 588 SQ.FT. CORRIDOR = 263 SQ.FT. PRIVATE DECKS = 0 SQ.FT.	RESIDENTIAL UNITS ALLOWED PER TABLE 1017.2 = 250'-0" PROPOSED = 88'-0"	(RESIDENTIAL 301) 549 SQ.FT. TOTAL 549 SQ.FT./200 = 3 OCCUPANTS (RESIDENTIAL 302) 520 SQ.FT. TOTAL 520 SQ.FT./200 = 3 OCCUPANTS (RESIDENTIAL 303) 646 SQ.FT. TOTAL 646 SQ.FT./200 = 4 OCCUPANTS (RESIDENTIAL 204) 588 SQ.FT. TOTAL 588 SQ.FT./200 = 3 OCCUPANTS (PRIVATE DECKS) 0 SQ.FT. TOTAL 0 SQ.FT./200 = 0 OCCUPANTS (CORRIDOR) 263 SQ.FT. TOTAL 263 SQ.FT./200 = 2 OCCUPANTS 15 TOTAL OCCUPANTS 15/2 = 8 OCCUPANTS PER CBC 1005.5 8 X .2 = 1.60' REQUIRED DOOR WIDTH 36" PROVIDED 8 X .3 = 2.40' REQUIRED STAIR WIDTH 48" PROVIDED	(RESIDENTIAL 301) 549 SQ.FT. TOTAL 549 SQ.FT./200 = 3 OCCUPANTS (RESIDENTIAL 302) 520 SQ.FT. TOTAL 520 SQ.FT./200 = 3 OCCUPANTS (RESIDENTIAL 303) 646 SQ.FT. TOTAL 646 SQ.FT./200 = 4 OCCUPANTS (RESIDENTIAL 204) 588 SQ.FT. TOTAL 588 SQ.FT./200 = 3 OCCUPANTS (PRIVATE DECKS) 0 SQ.FT. TOTAL 0 SQ.FT./200 = 0 OCCUPANTS (CORRIDOR) 263 SQ.FT. TOTAL 263 SQ.FT./200 = 2 OCCUPANTS 15 TOTAL OCCUPANTS 15/2 = 8 OCCUPANTS PER CBC 1005.5 8 X .2 = 1.60' REQUIRED DOOR WIDTH 36" PROVIDED 8 X .3 = 2.40' REQUIRED STAIR WIDTH 48" PROVIDED	DIAGONAL DISTANCE = 83'-7" 1/3 OF 83'-7" = 27'-10" DISTANCE PROVIDED = 40'-5"

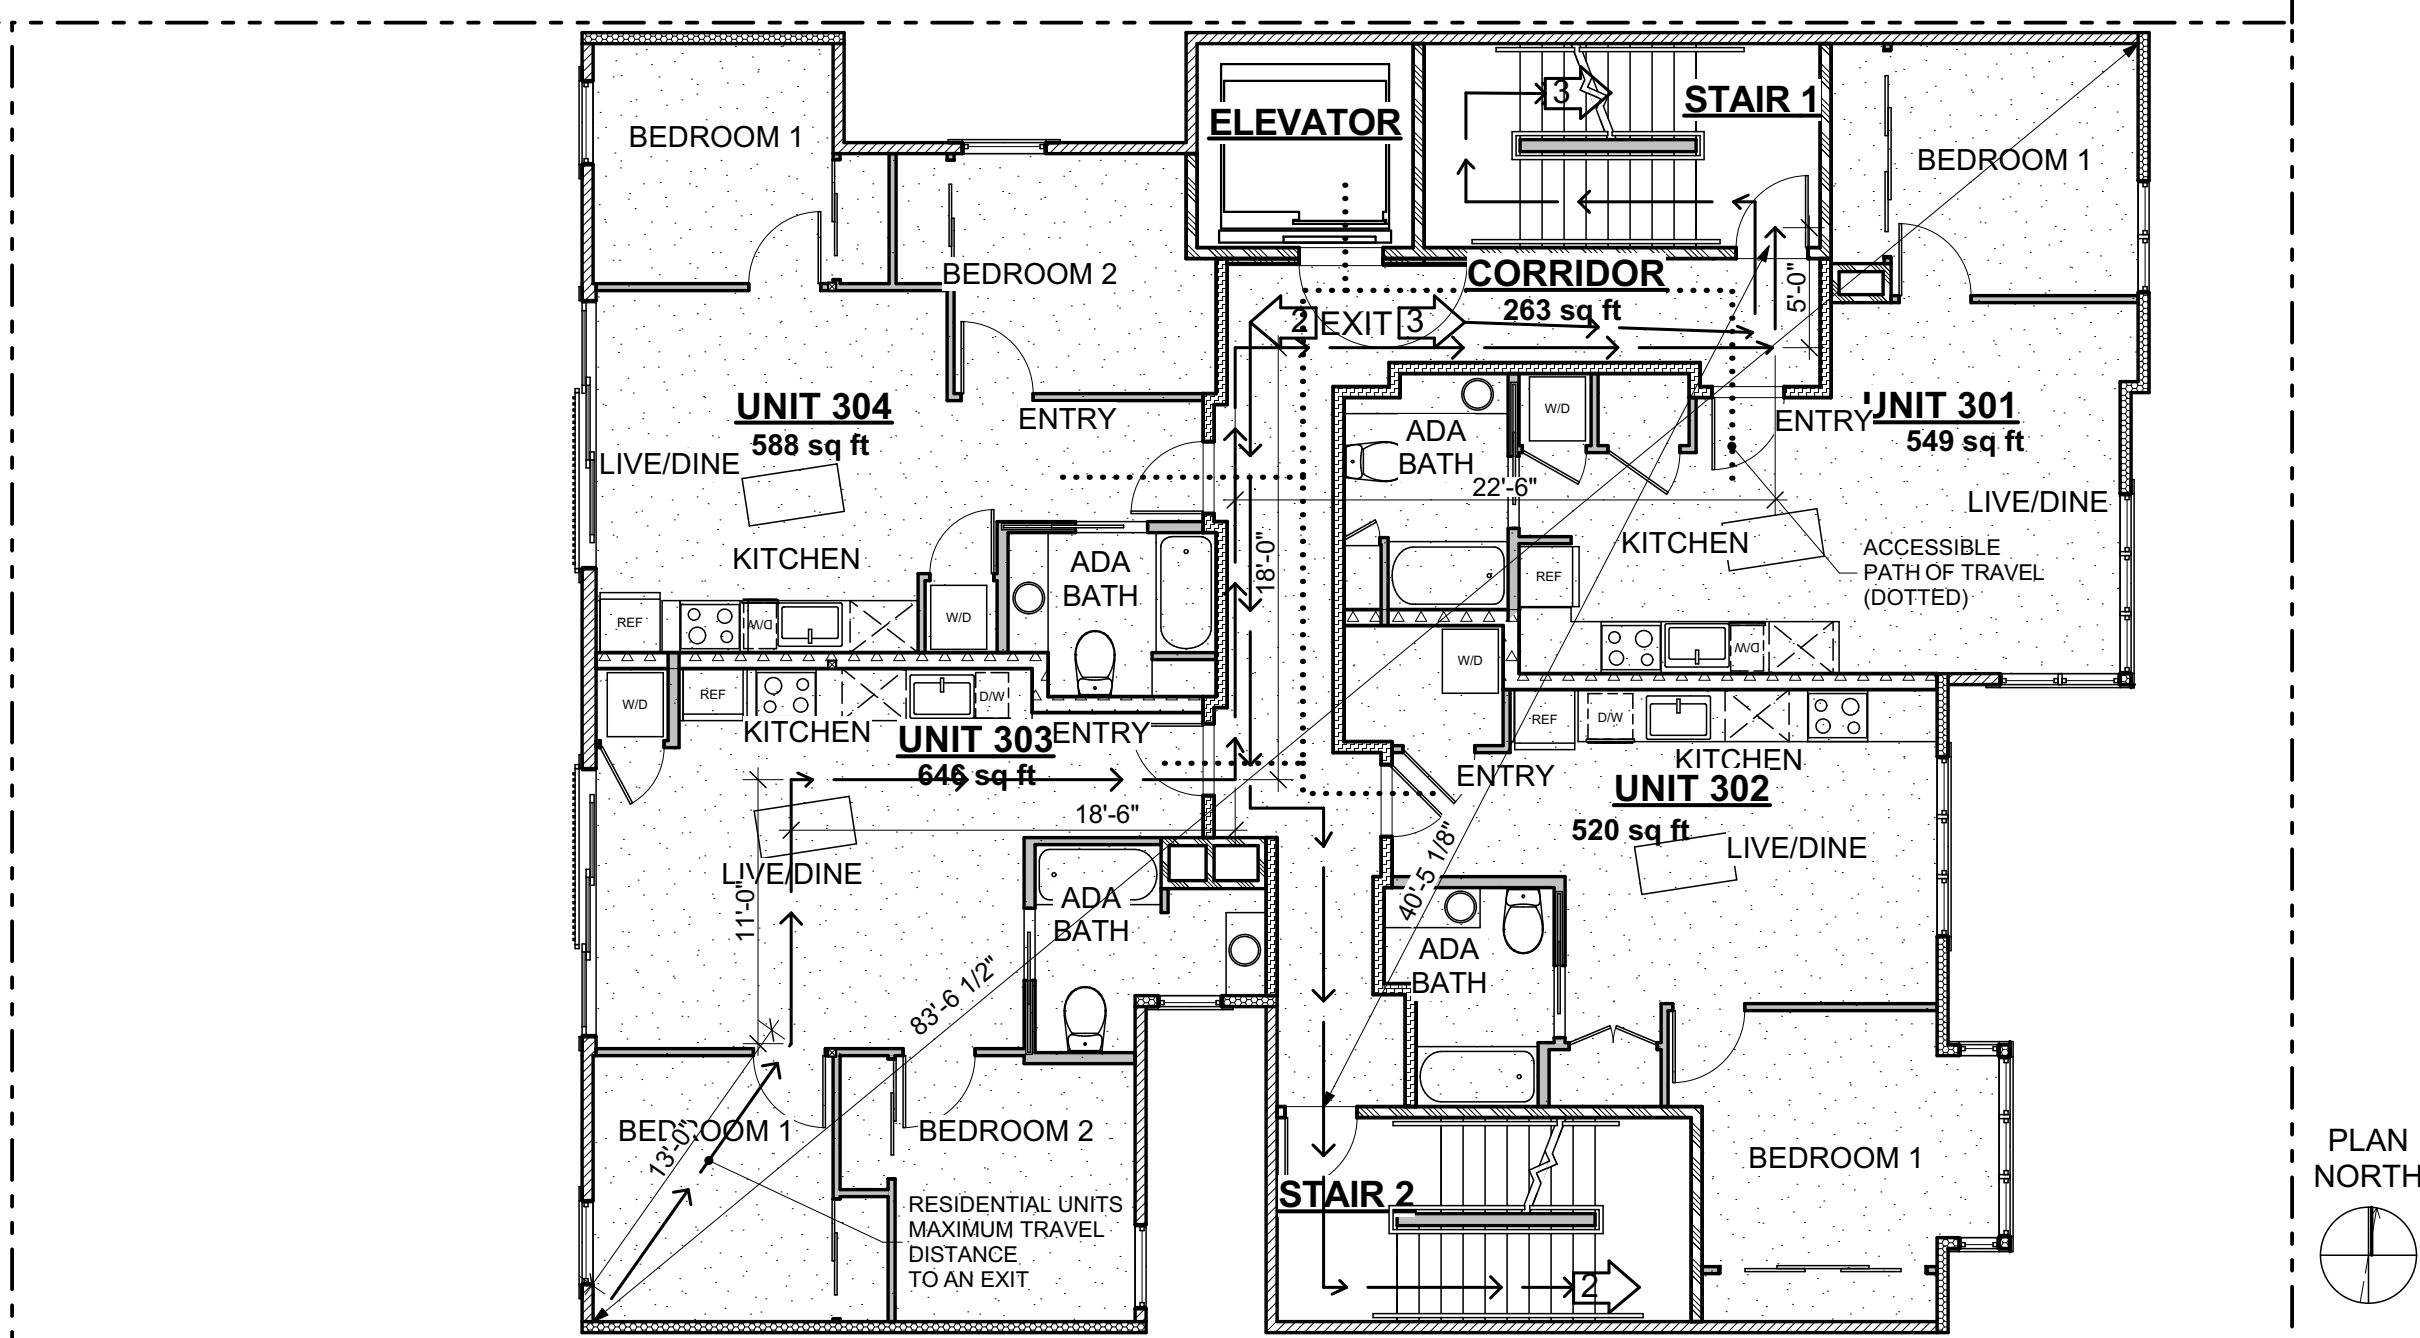

3 3RD FLOOR EXITING PLAN
SCALE: 1/8" = 1'-0"

FLOOR AREAS	MAXIMUM TRAVEL DISTANCE	EXIT ROUTE 2	EXIT ROUTE 3	EXIT SEPARATION COMMON PATH OF TRAVEL
RESIDENTIAL UNIT 401= 549 SQ.FT. RESIDENTIAL UNIT 402= 520 SQ.FT. RESIDENTIAL UNIT 403= 722 SQ.FT. CORRIDOR = 260 SQ.FT. PRIVATE DECKS = 510 SQ.FT.	RESIDENTIAL UNITS ALLOWED PER TABLE 1017.2 = 250'-0" PROPOSED = 85'-0"	(RESIDENTIAL 401) 549 SQ.FT. TOTAL 549 SQ.FT./200 = 3 OCCUPANTS (RESIDENTIAL 402) 520 SQ.FT. TOTAL 520 SQ.FT./200 = 3 OCCUPANTS (RESIDENTIAL 403) 722 SQ.FT. TOTAL 722 SQ.FT./200 = 4 OCCUPANTS (PRIVATE DECKS) 510 SQ.FT. TOTAL 510 SQ.FT./200 = 3 OCCUPANTS (CORRIDOR) 260 SQ.FT. TOTAL 260 SQ.FT./200 = 2 OCCUPANTS 15 TOTAL OCCUPANTS 15/2 = 8 OCCUPANTS PER CBC 1005.5 8 X .2 = 1.60' REQUIRED DOOR WIDTH 36" PROVIDED 8 X .3 = 2.40' REQUIRED STAIR WIDTH 48" PROVIDED	(RESIDENTIAL 401) 549 SQ.FT. TOTAL 549 SQ.FT./200 = 3 OCCUPANTS (RESIDENTIAL 402) 520 SQ.FT. TOTAL 520 SQ.FT./200 = 3 OCCUPANTS (RESIDENTIAL 403) 722 SQ.FT. TOTAL 722 SQ.FT./200 = 4 OCCUPANTS (PRIVATE DECKS) 510 SQ.FT. TOTAL 510 SQ.FT./200 = 3 OCCUPANTS (CORRIDOR) 260 SQ.FT. TOTAL 260 SQ.FT./200 = 2 OCCUPANTS 15 TOTAL OCCUPANTS 15/2 = 8 OCCUPANTS PER CBC 1005.5 8 X .2 = 1.60' REQUIRED DOOR WIDTH 36" PROVIDED 8 X .3 = 2.40' REQUIRED STAIR WIDTH 48" PROVIDED	DIAGONAL DISTANCE = 83'-7" 1/3 OF 83'-7" = 27'-10" DISTANCE PROVIDED = 40'-5"

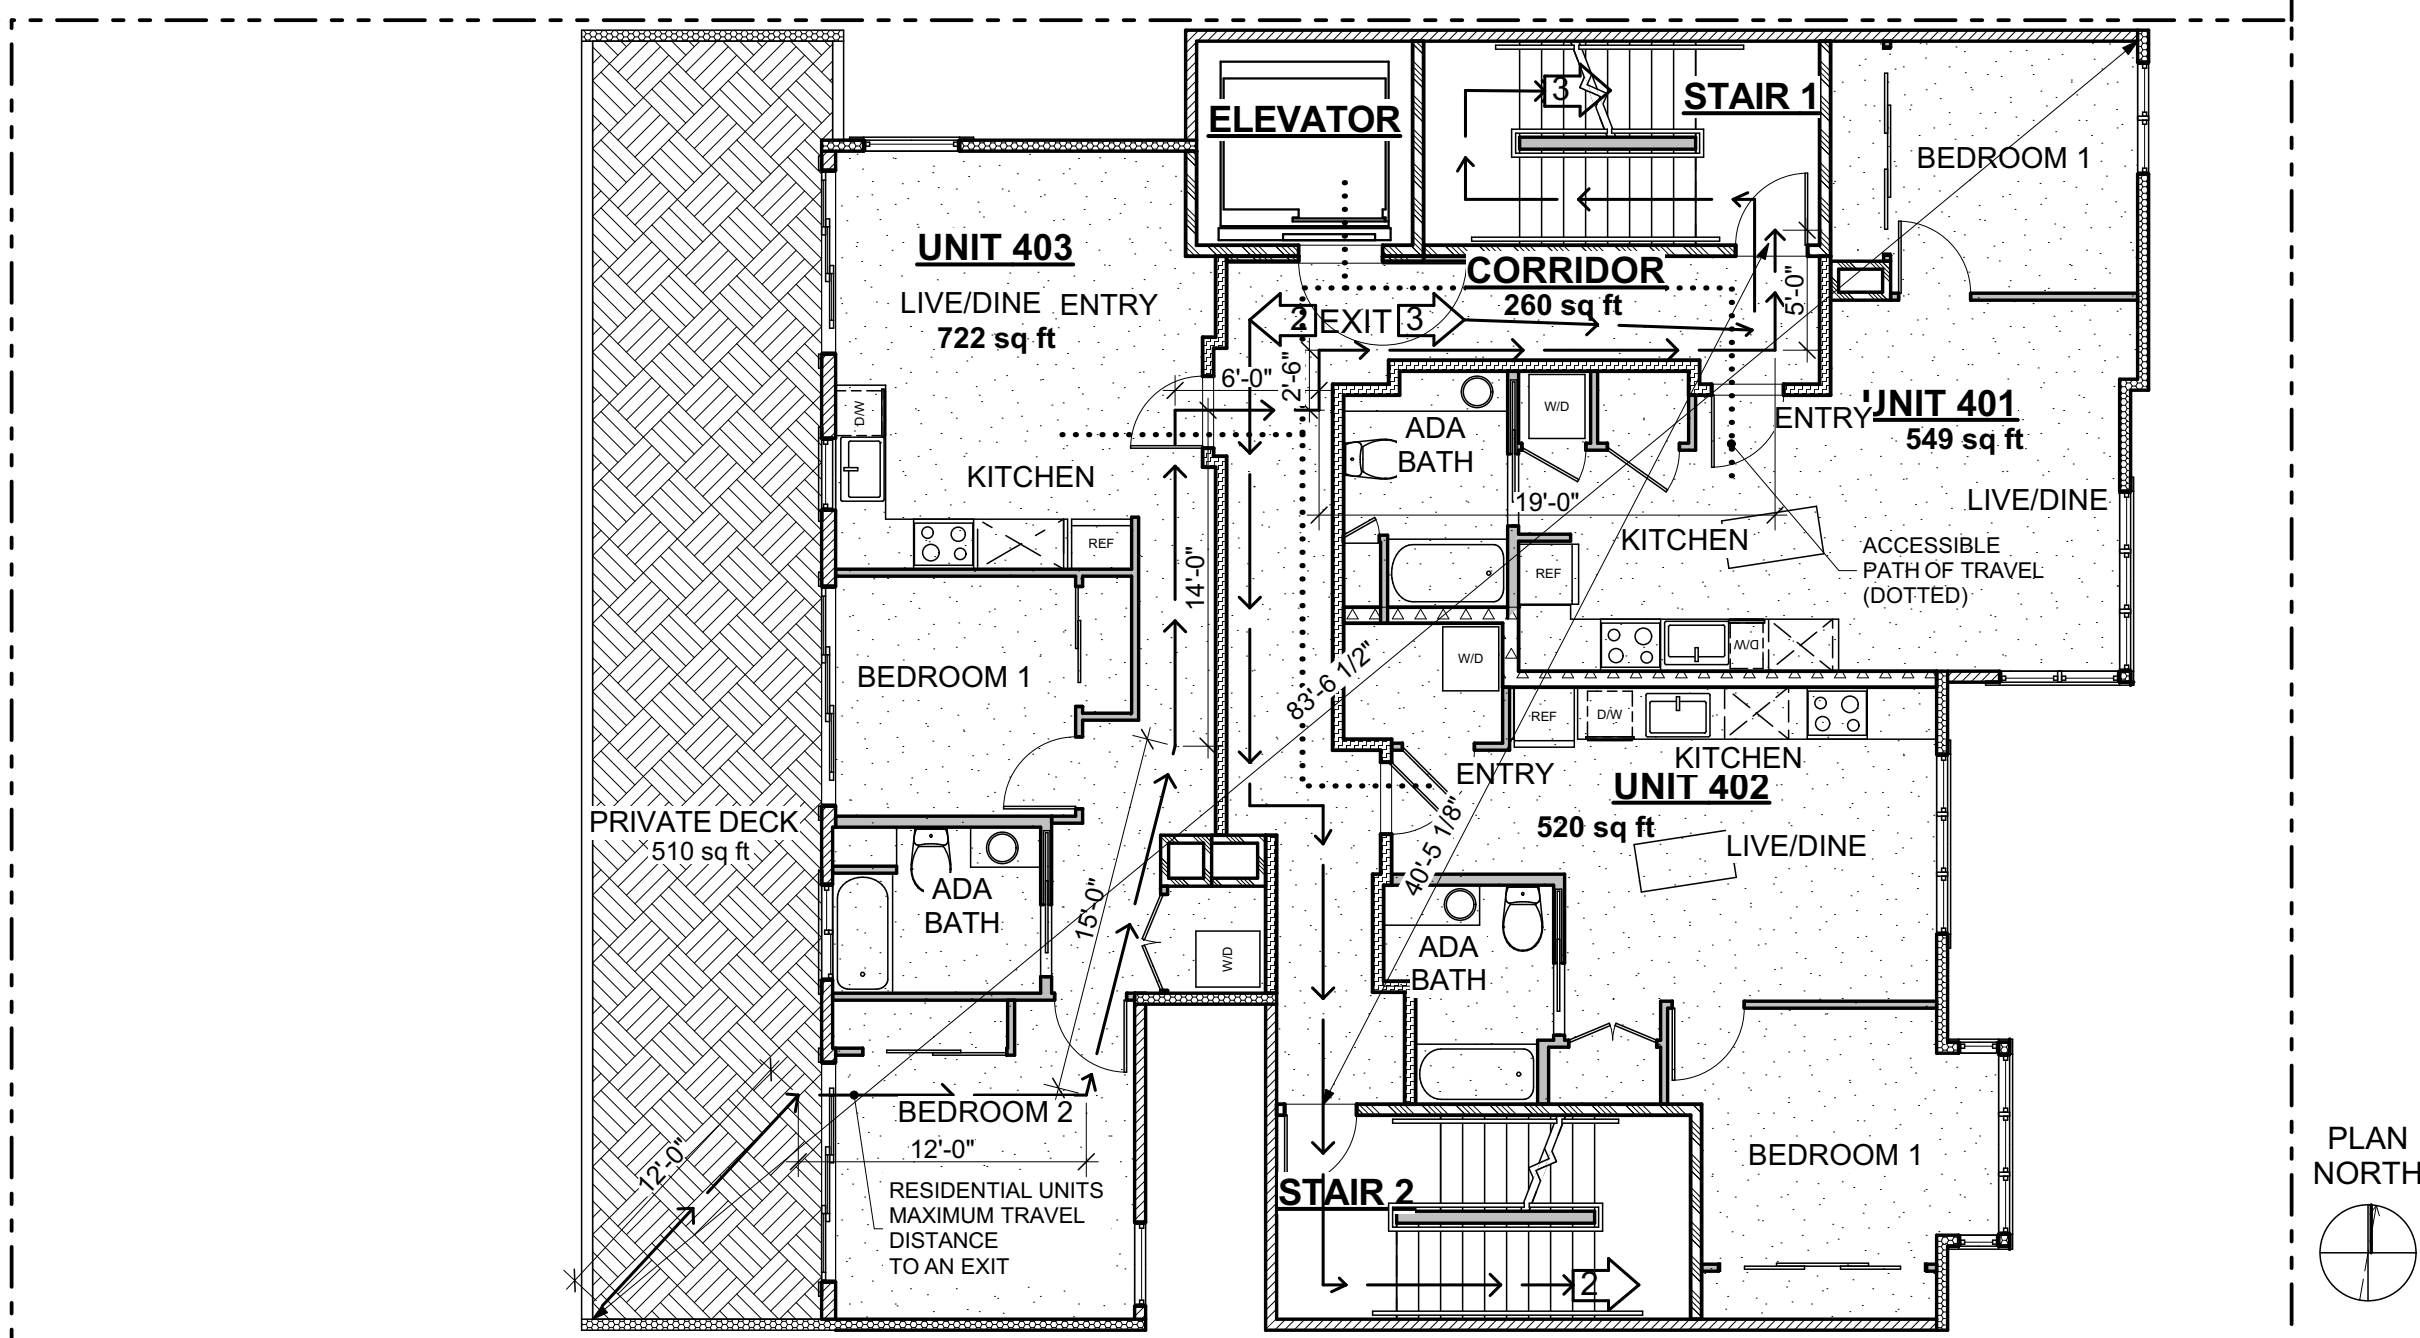

4 4TH FLOOR EXITING PLAN
SCALE: 1/8" = 1'-0"

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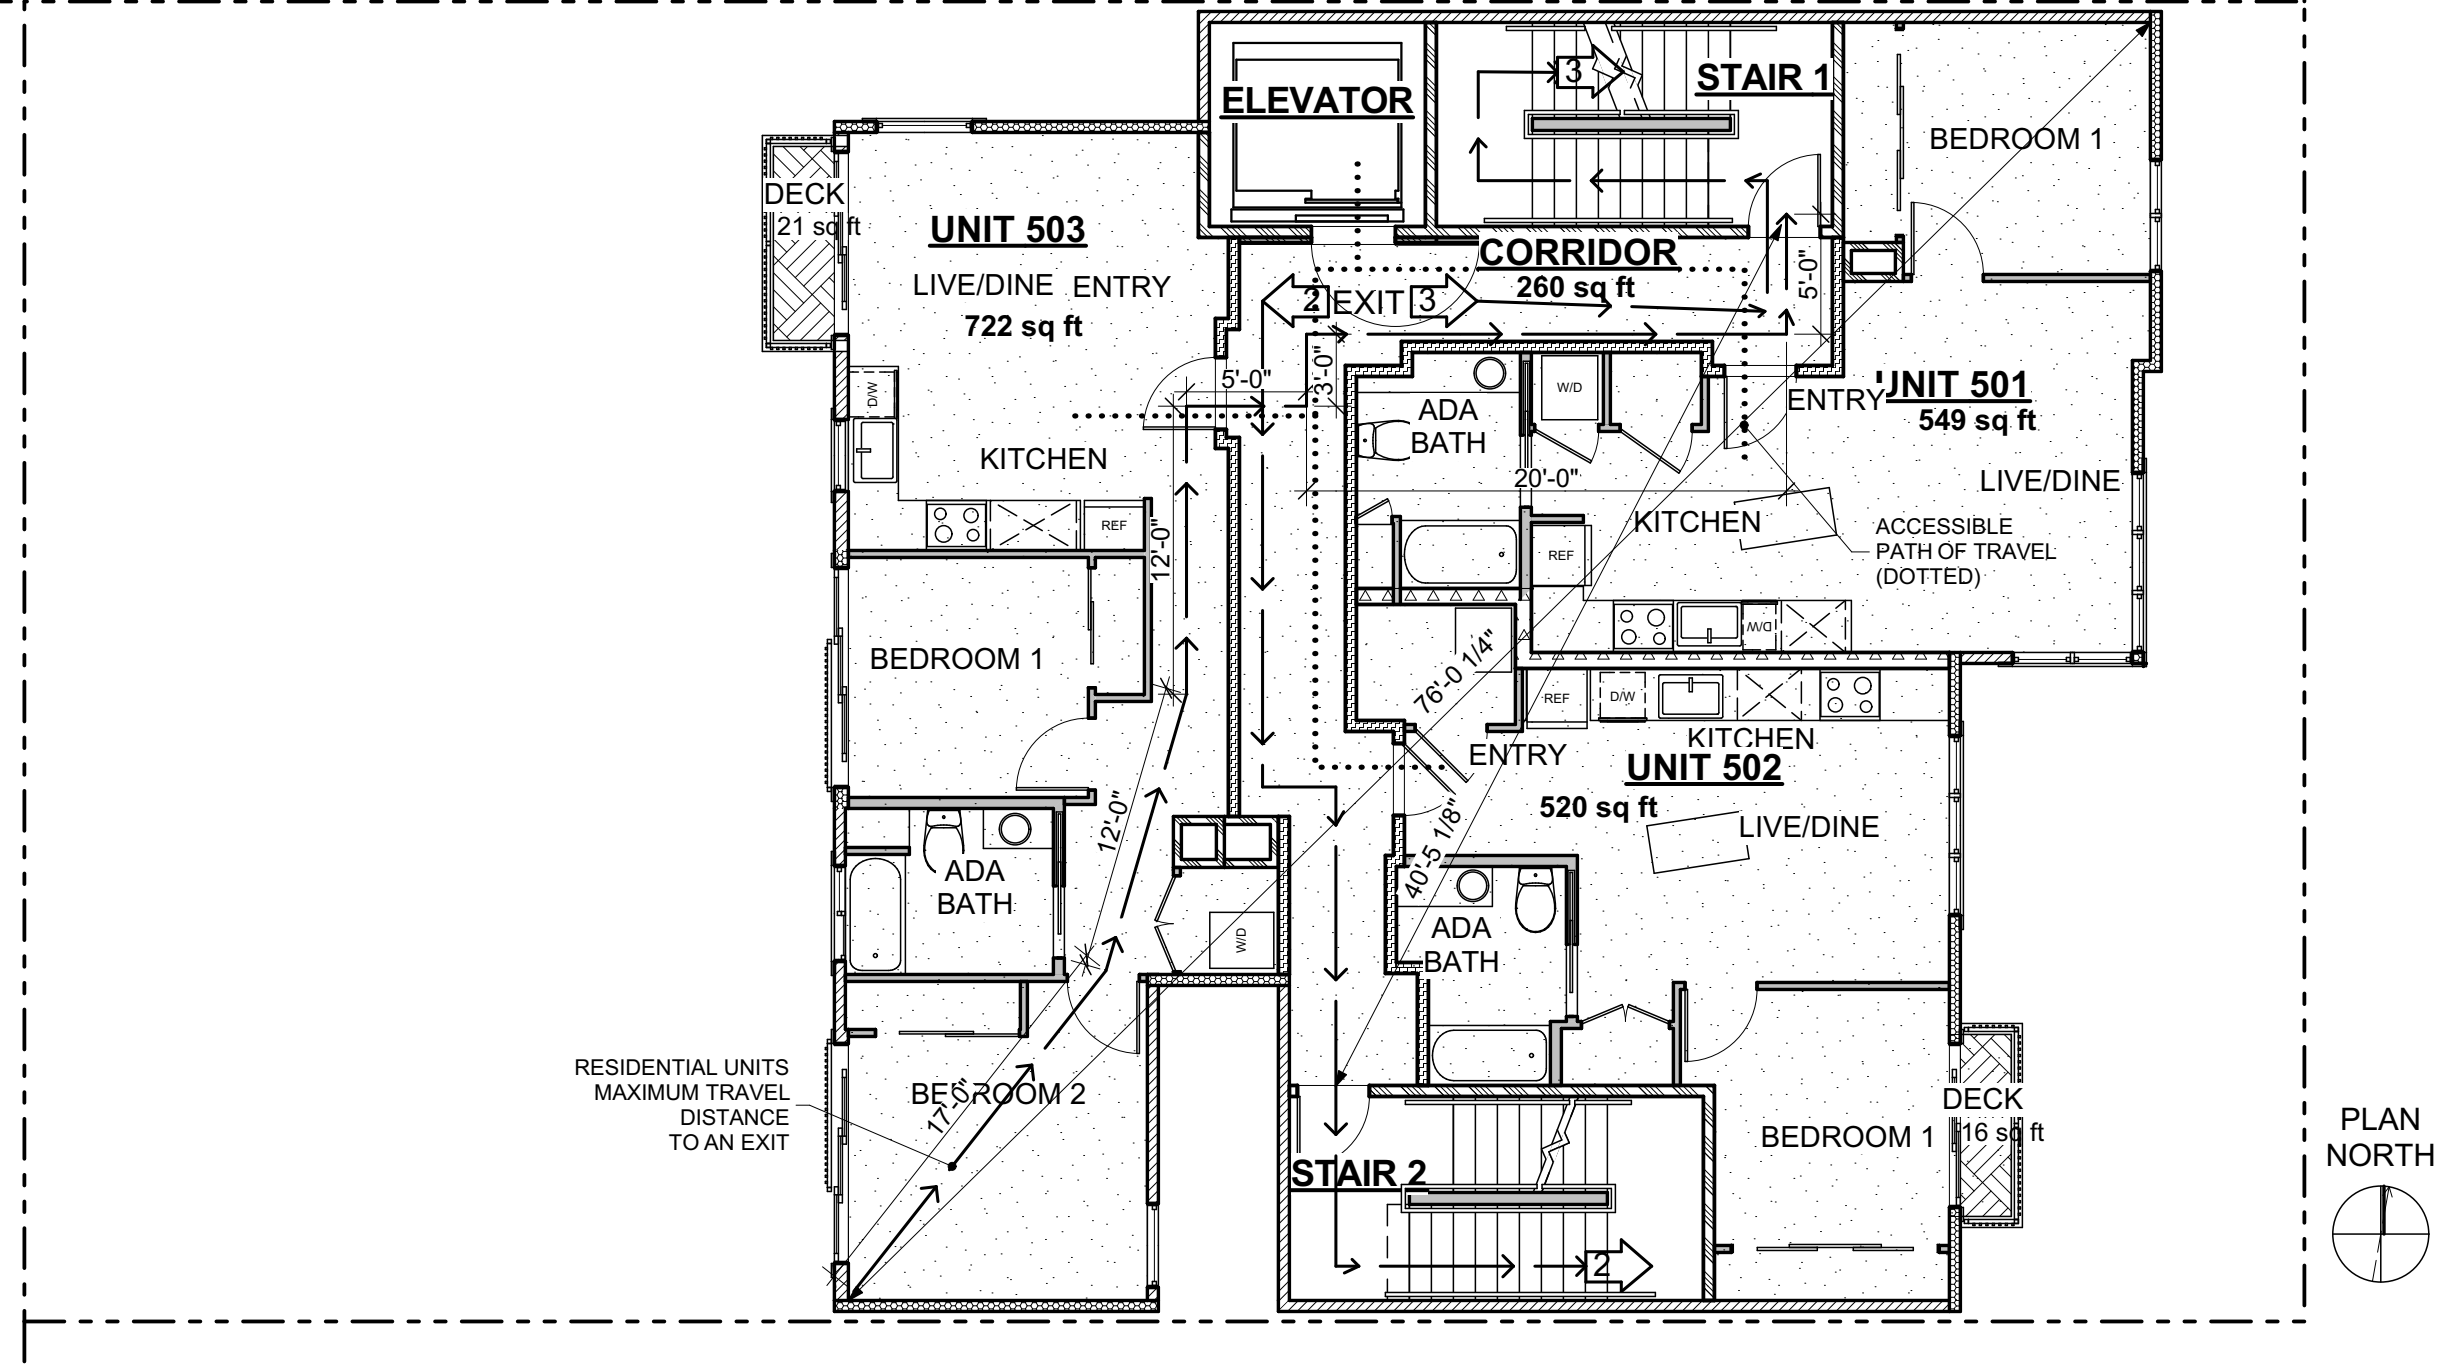
FLOOR AREAS
RESIDENTIAL UNIT 501= 549 SQ.FT. RESIDENTIAL UNIT 502= 520 SQ.FT. RESIDENTIAL UNIT 503= 722 SQ.FT. CORRIDOR = 260 SQ.FT. PRIVATE DECK = 21 SQ.FT. PRIVATE DECK = 16 SQ.FT.

MAXIMUM TRAVEL DISTANCE
RESIDENTIAL UNITS ALLOWED PER TABLE 1017.2 = 250'-0" PROPOSED = 74'-0"

EXIT ROUTE 2
(RESIDENTIAL 501) 549 SQ.FT. TOTAL 549 SQ.FT./200 = 3 OCCUPANTS (RESIDENTIAL 502) 520 SQ.FT. TOTAL 520 SQ.FT./200 = 3 OCCUPANTS (RESIDENTIAL 503) 722 SQ.FT. TOTAL 722 SQ.FT./200 = 4 OCCUPANTS (PRIVATE DECK) 21 SQ.FT. TOTAL 21 SQ.FT./200 = 1 OCCUPANTS (PRIVATE DECK) 16 SQ.FT. TOTAL 16 SQ.FT./200 = 1 OCCUPANTS (CORRIDOR) 260 SQ.FT. TOTAL 260 SQ.FT./200 = 2 OCCUPANTS 14 TOTAL OCCUPANTS
14/2= 7 OCCUPANTS PER CBC 1005.5 7 X .2 = 1.40" REQUIRED DOOR WIDTH 36" PROVIDED 7 X .3 = 2.10" REQUIRED STAIR WIDTH 48" PROVIDED

EXIT ROUTE 3
(RESIDENTIAL 501) 549 SQ.FT. TOTAL 549 SQ.FT./200 = 3 OCCUPANTS (RESIDENTIAL 502) 520 SQ.FT. TOTAL 520 SQ.FT./200 = 3 OCCUPANTS (RESIDENTIAL 503) 722 SQ.FT. TOTAL 722 SQ.FT./200 = 4 OCCUPANTS (PRIVATE DECK) 21 SQ.FT. TOTAL 21 SQ.FT./200 = 1 OCCUPANTS (PRIVATE DECK) 16 SQ.FT. TOTAL 16 SQ.FT./200 = 1 OCCUPANTS (CORRIDOR) 260 SQ.FT. TOTAL 260 SQ.FT./200 = 2 OCCUPANTS 14 TOTAL OCCUPANTS
14/2= 7 OCCUPANTS PER CBC 1005.5 7 X .2 = 1.40" REQUIRED DOOR WIDTH 36" PROVIDED 7 X .3 = 2.10" REQUIRED STAIR WIDTH 48" PROVIDED

EXIT SEPARATION COMMON PATH OF TRAVEL
DIAGONAL DISTANCE = 76'-0" 1/3 OF 76'-0" = 25'-4" DISTANCE PROVIDED = 40'-5"



1 5TH FLOOR EXITING PLAN
SCALE: 1/8" = 1'-0"


FLOOR AREAS
ROOF DECK = 1532 SQ.FT. ELEVATOR CONTROL = 33 SQ.FT.

MAXIMUM TRAVEL DISTANCE
ROOF DECK ALLOWED PER TABLE 1017.2 = 75'-0" PROPOSED = 45'-0"

EXIT ROUTE 2
(ROOF DECK) 1532 SQ.FT. TOTAL 1532 SQ.FT./15 = 102 OCCUPANTS (ELEV. CONTROL) 33 SQ.FT. TOTAL 33 SQ.FT./300 = 1 OCCUPANTS 103 TOTAL OCCUPANTS
103/2= 52 OCCUPANTS PER CBC 1005.5 52 X .2 = 10.40" REQUIRED DOOR WIDTH 36" PROVIDED 52 X .3 = 15.60" REQUIRED STAIR WIDTH 48" PROVIDED

EXIT ROUTE 3
(ROOF DECK) 1532 SQ.FT. TOTAL 1532 SQ.FT./15 = 102 OCCUPANTS (ELEV. CONTROL) 33 SQ.FT. TOTAL 33 SQ.FT./300 = 1 OCCUPANTS 103 TOTAL OCCUPANTS
103/2= 52 OCCUPANTS PER CBC 1005.5 52 X .2 = 10.40" REQUIRED DOOR WIDTH 36" PROVIDED 52 X .3 = 15.60" REQUIRED STAIR WIDTH 48" PROVIDED

EXIT SEPARATION COMMON PATH OF TRAVEL
DIAGONAL DISTANCE = 58'-11" 1/3 OF 58'-11" = 19'-8" DISTANCE PROVIDED = 40'-10"

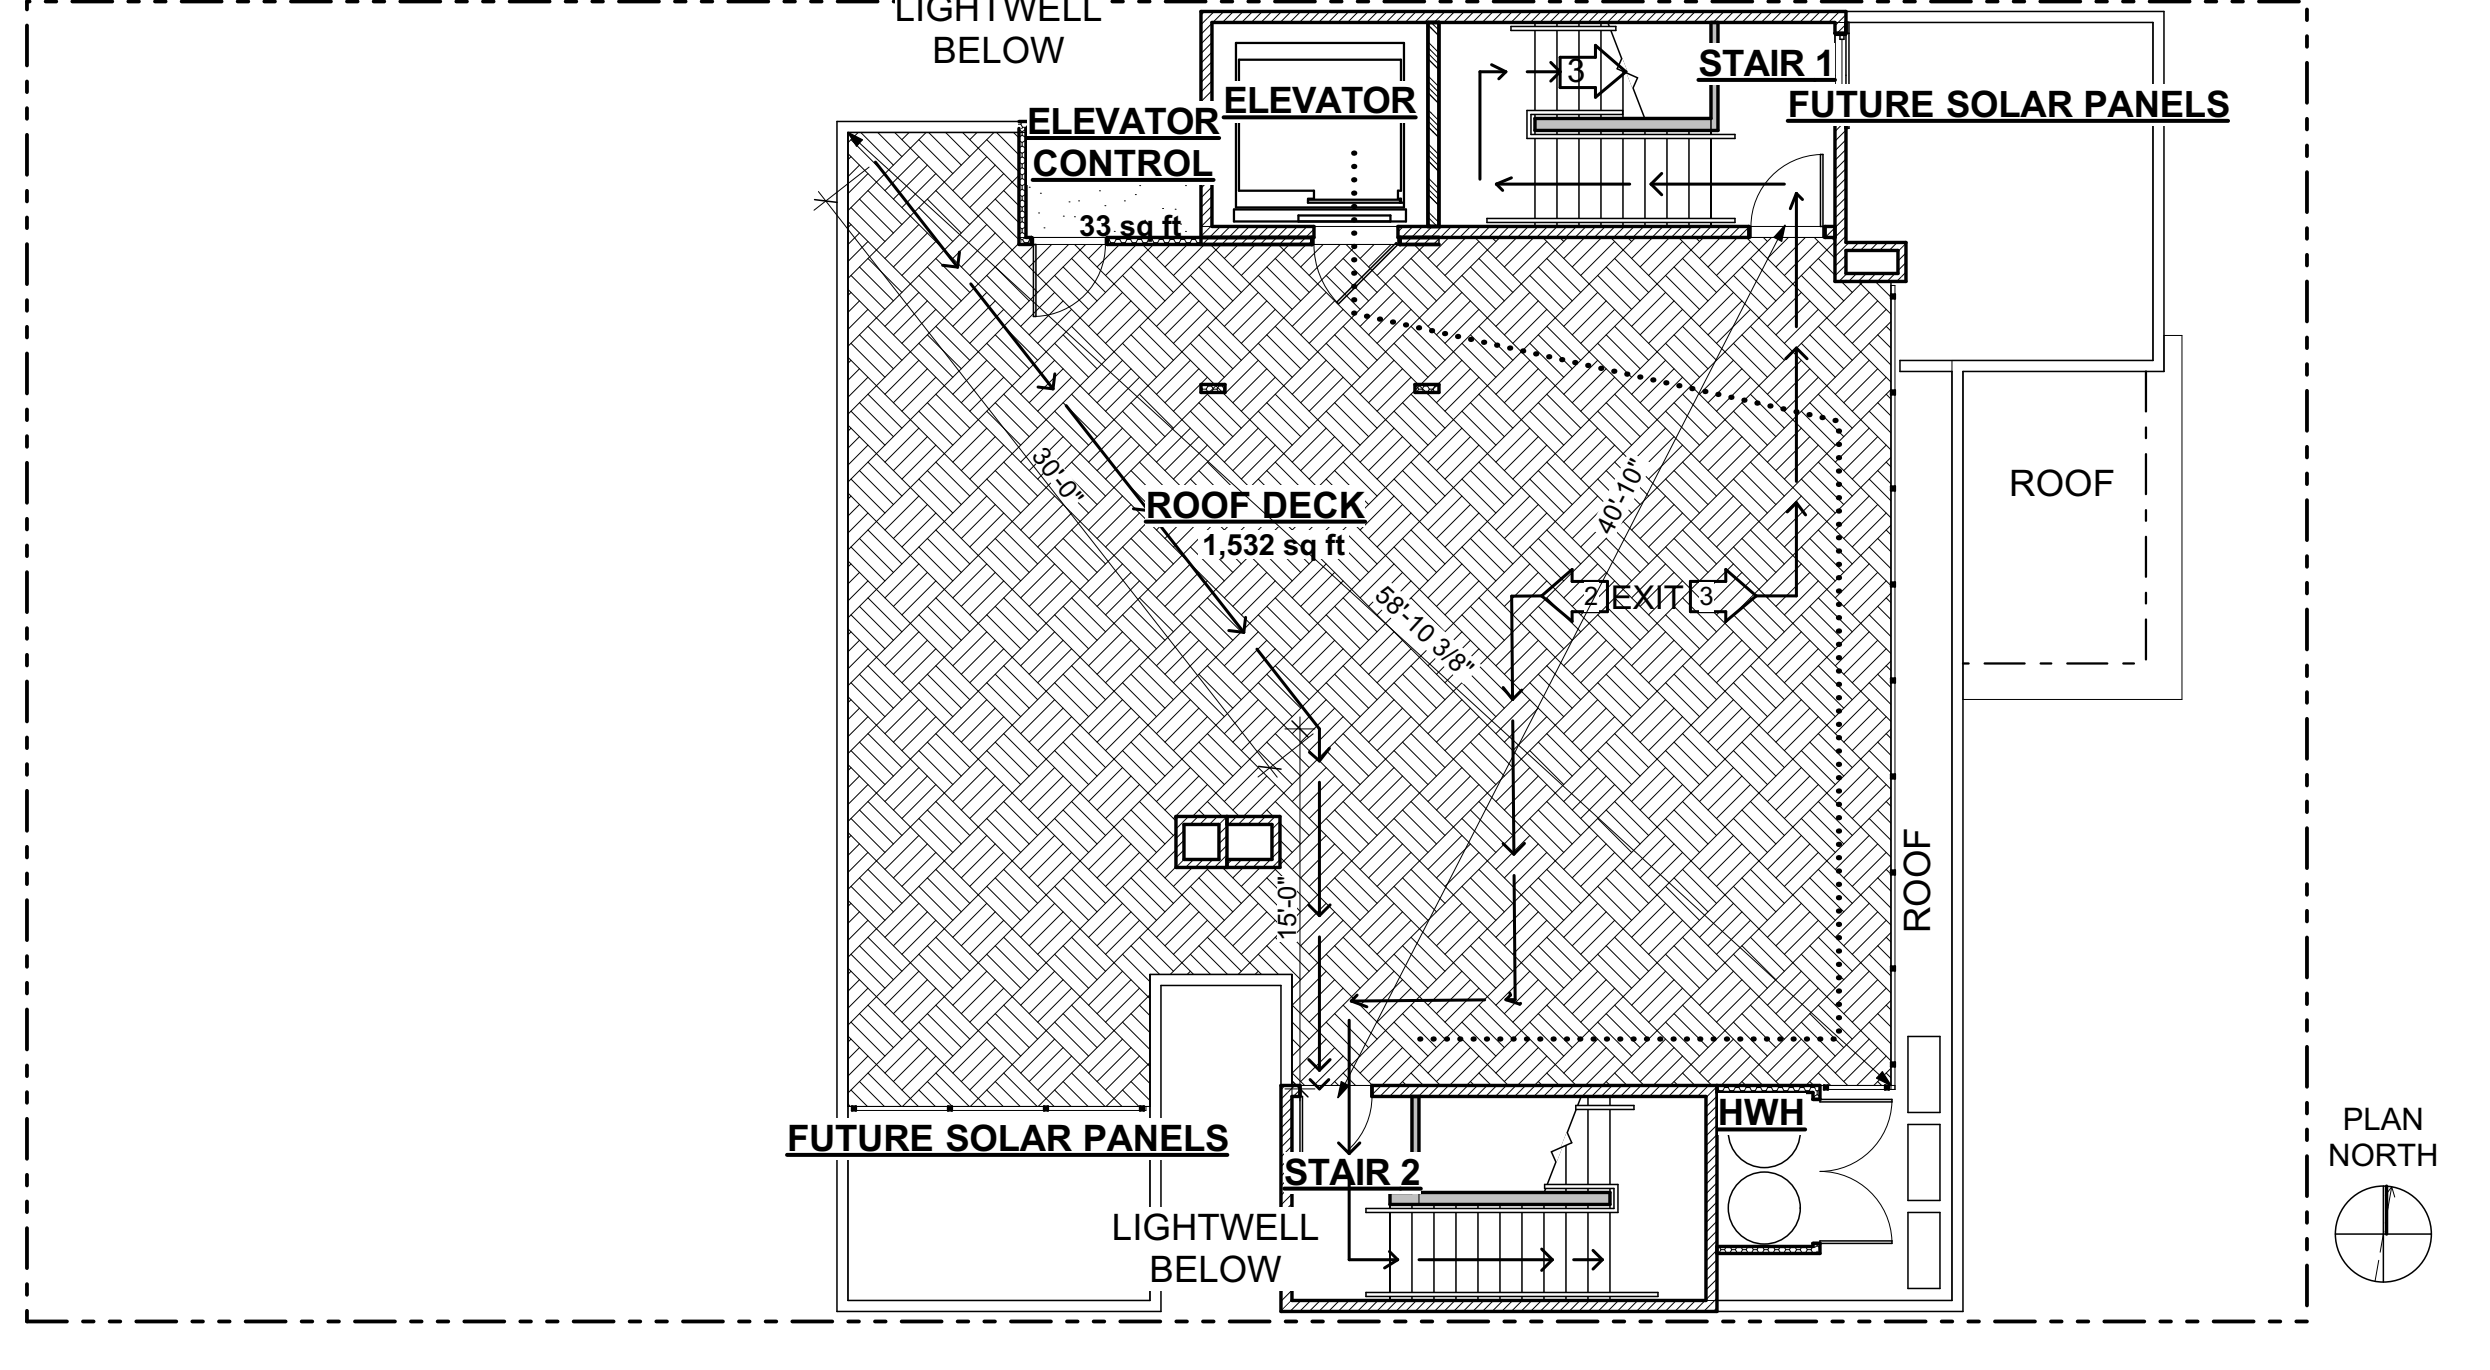

2 ROOF EXITING PLAN
SCALE: 1/8" = 1'-0"

Kotas/
Pantaleoni
Architects

Anthony A. Pantaleoni
LEED AP
70 Zee Street, Suite 200
San Francisco, California 94107
t 415 496 4051
design@kp-architects.com



Revisions	By
PROGRESS SET 01.15.20	BM
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FIRE RESPONSE 04.07.20	BM
PLANNING REVISIONS 05.06.20	BM
DBI-PLNG RESPONSE 06.30.20	BM

15 RESIDENTIAL UNITS
986 SOUTH VAN NESS AVENUE
SAN FRANCISCO, CA 94110

Sheet Title:
Project Info:
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Date: 11.19
Drawn By: BM
Job Number: 2-1119

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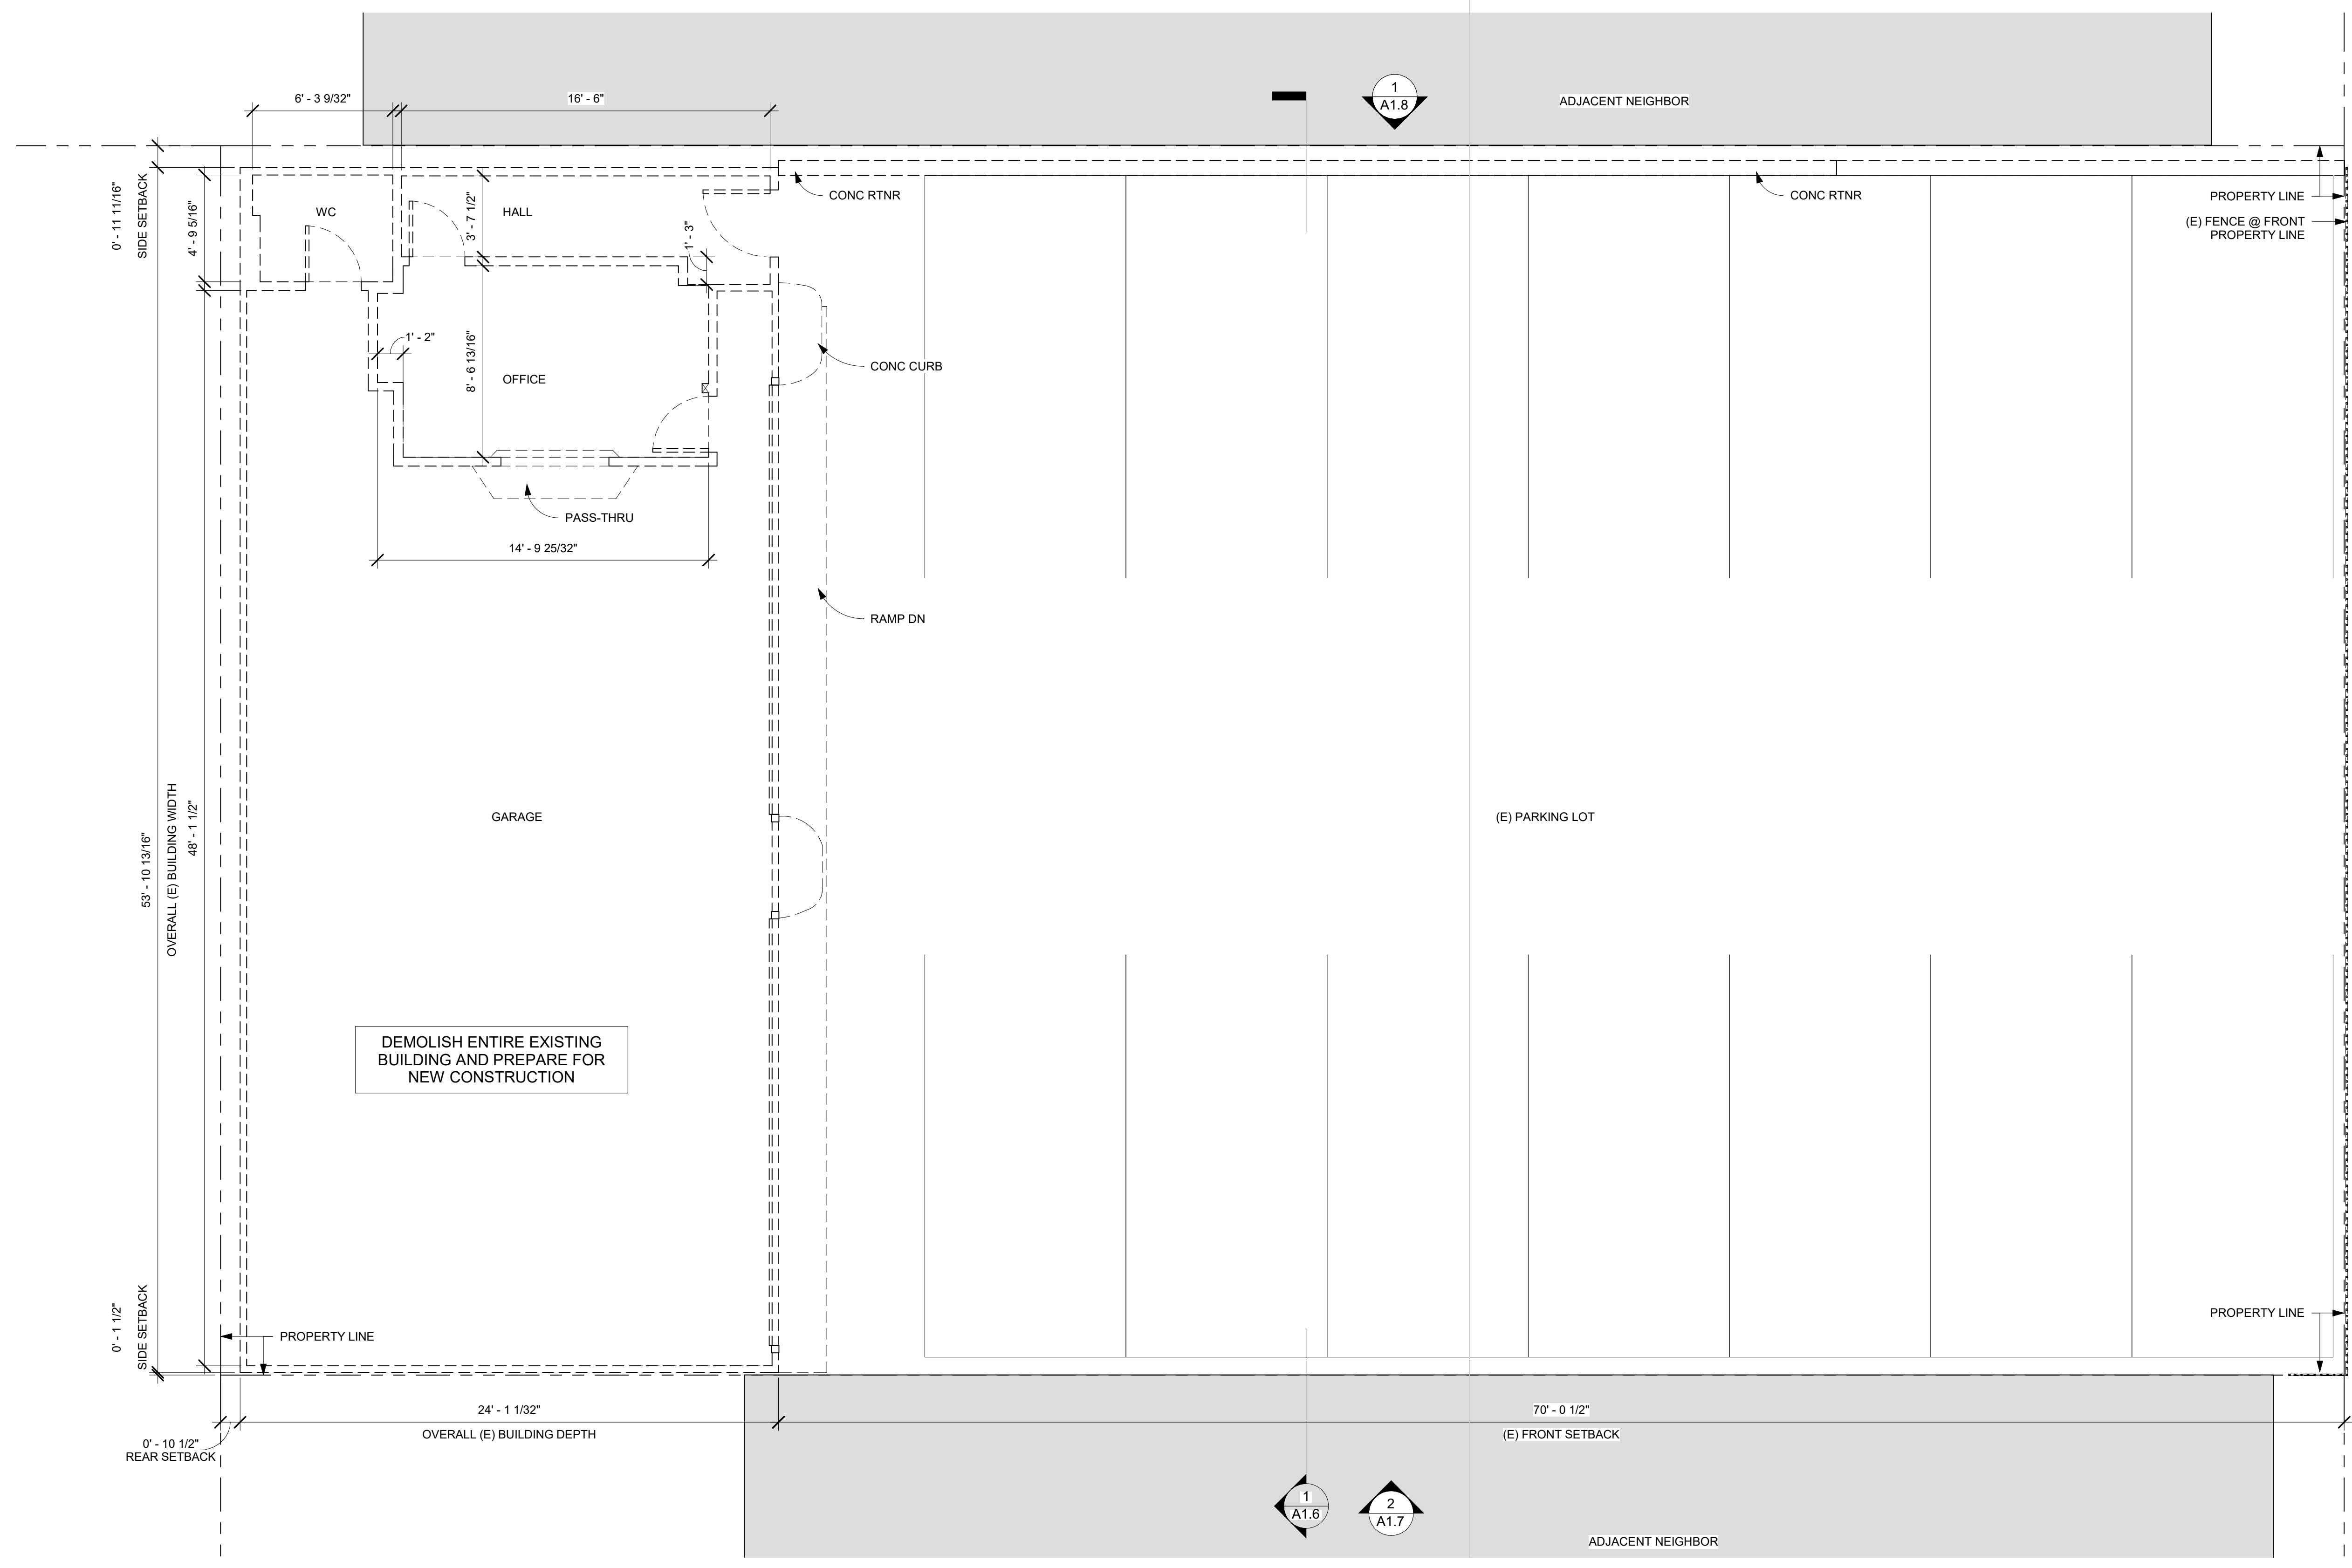
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PROPOSED
DEMO PLAN

Date: 11.19

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A1.5



1 PROPOSED DEMO PLAN

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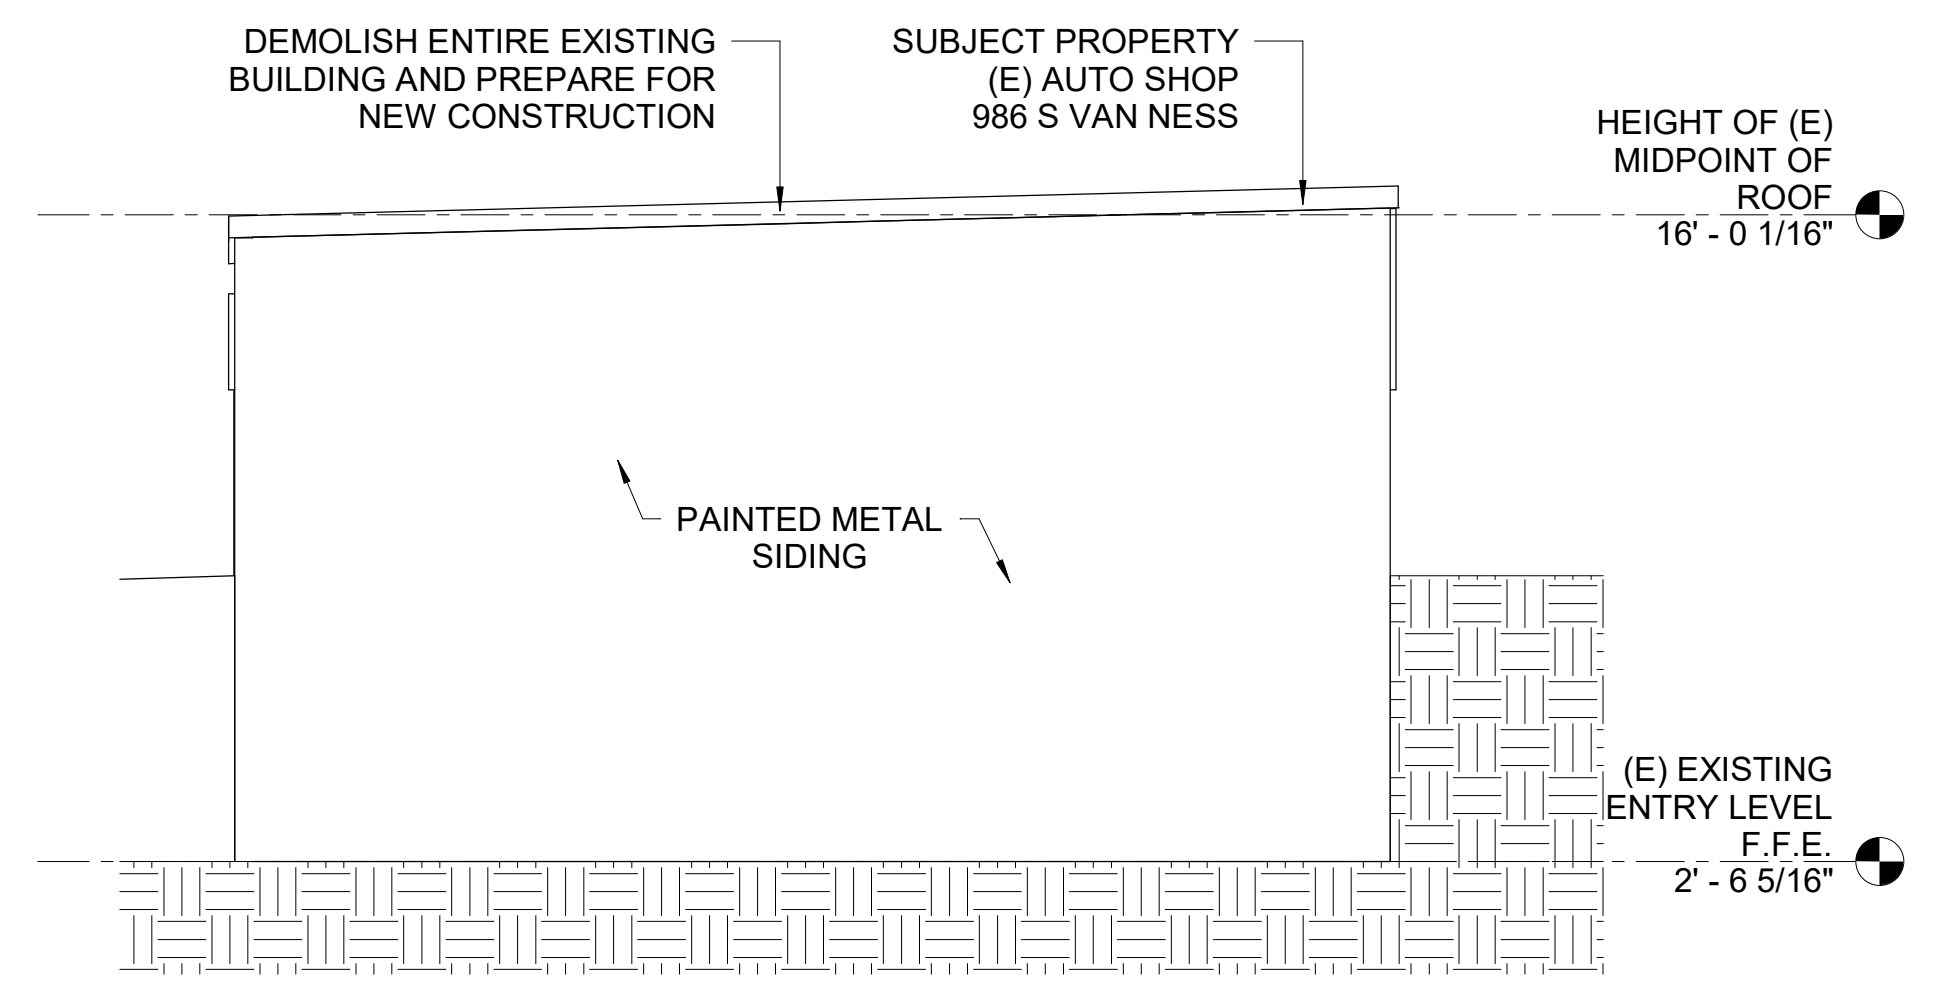
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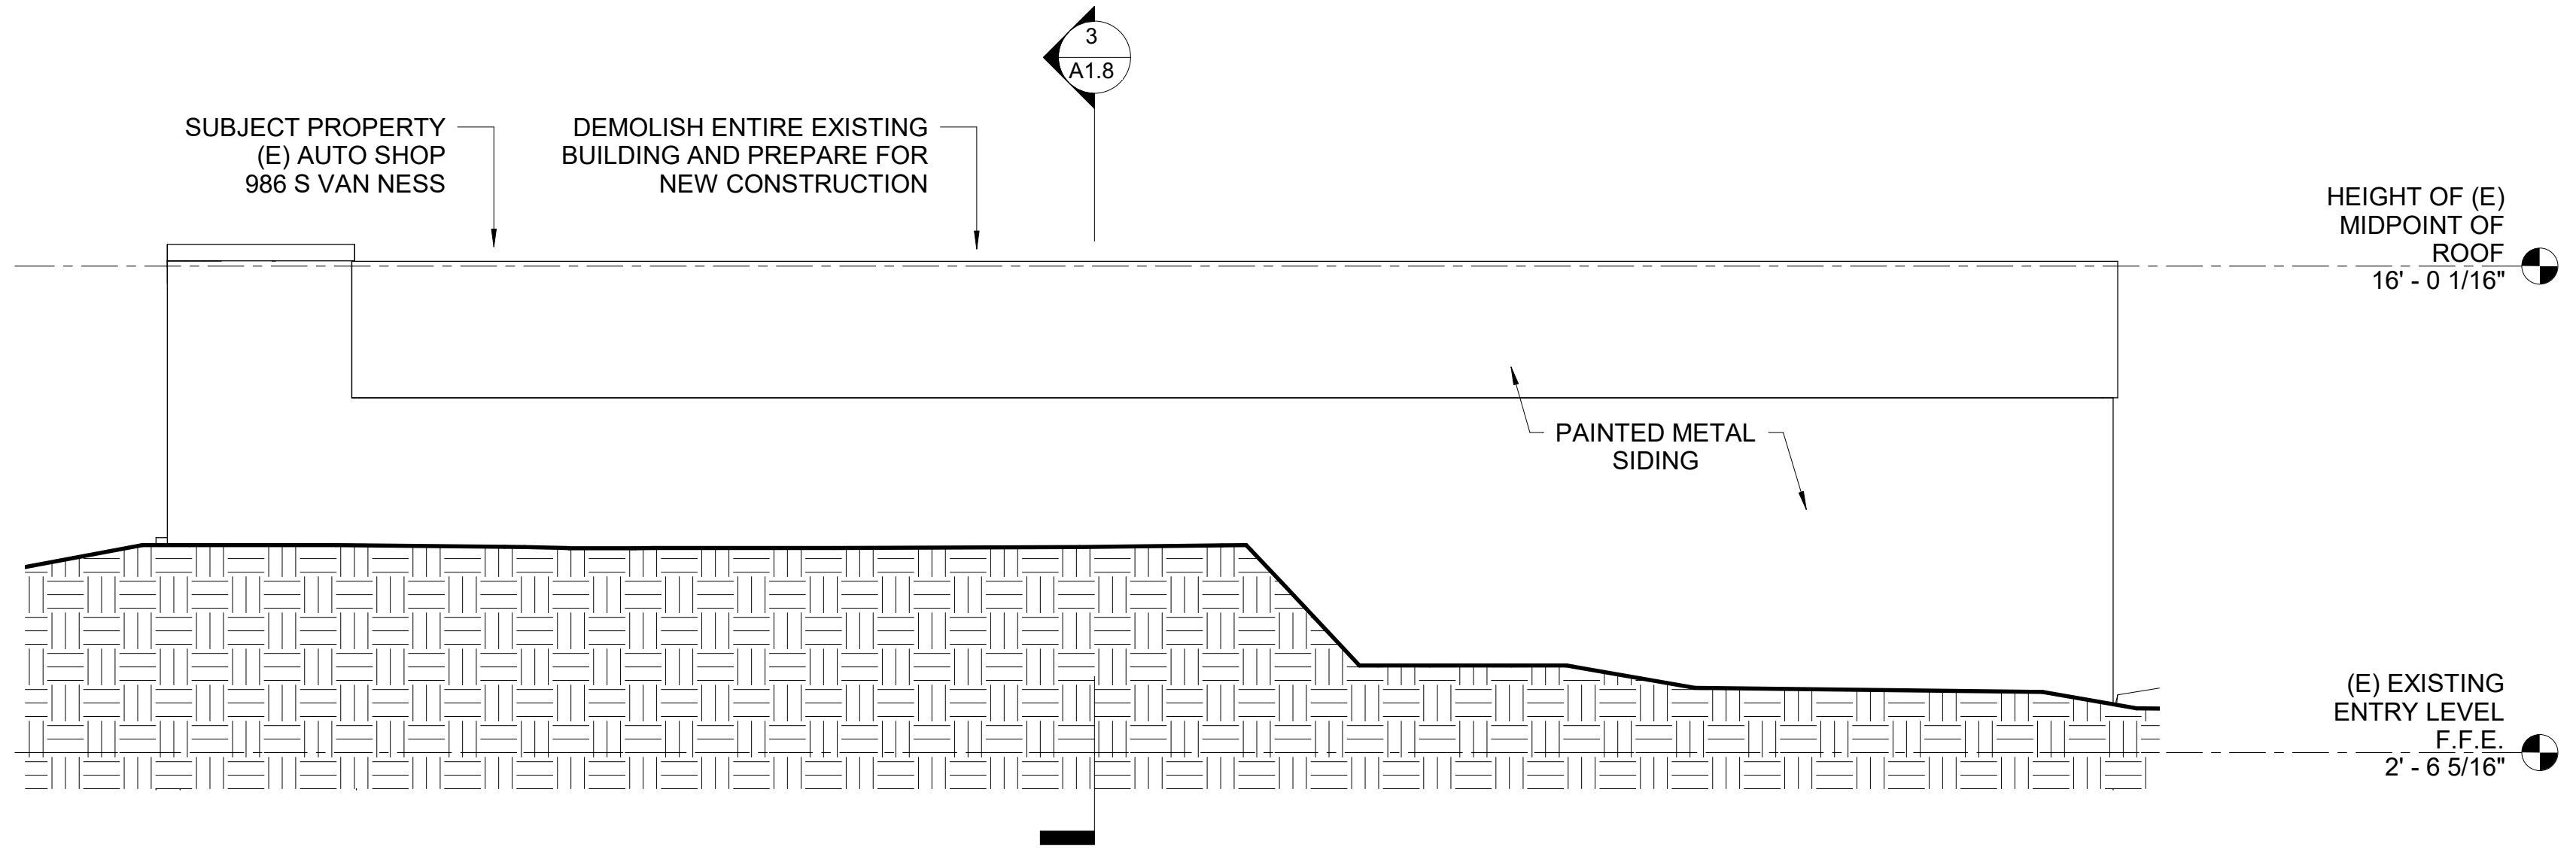
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Project Info:
EXISTING
EXTERIOR
ELEVATIONS

Date: 11.19
Drawn By: BM
Job Number: 2-1119


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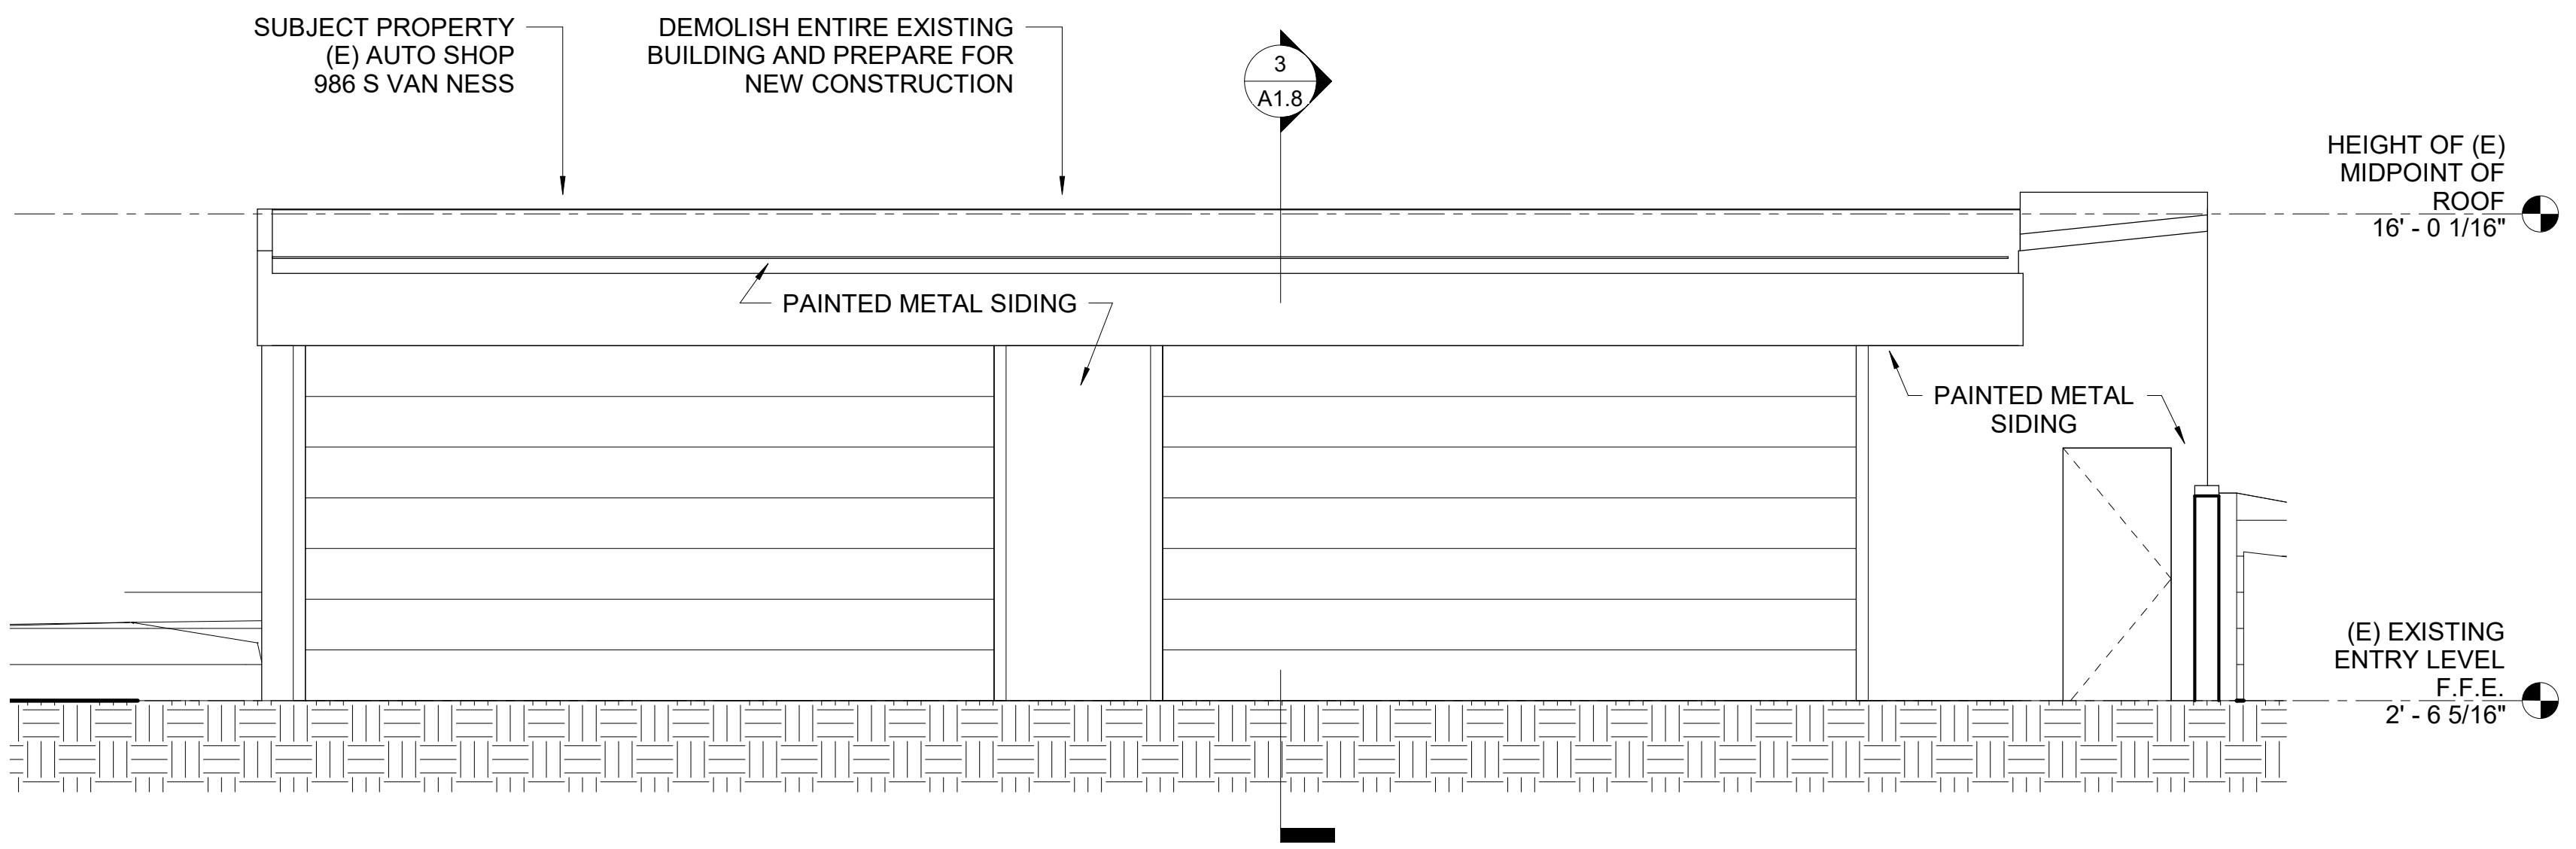
4 EXISTING NORTH ELEVATION
1/4" = 1'-0"



3 EXISTING WEST ELEVATION
1/4" = 1'-0"




2 EXISTING SOUTH ELEVATION
1/4" = 1'-0"

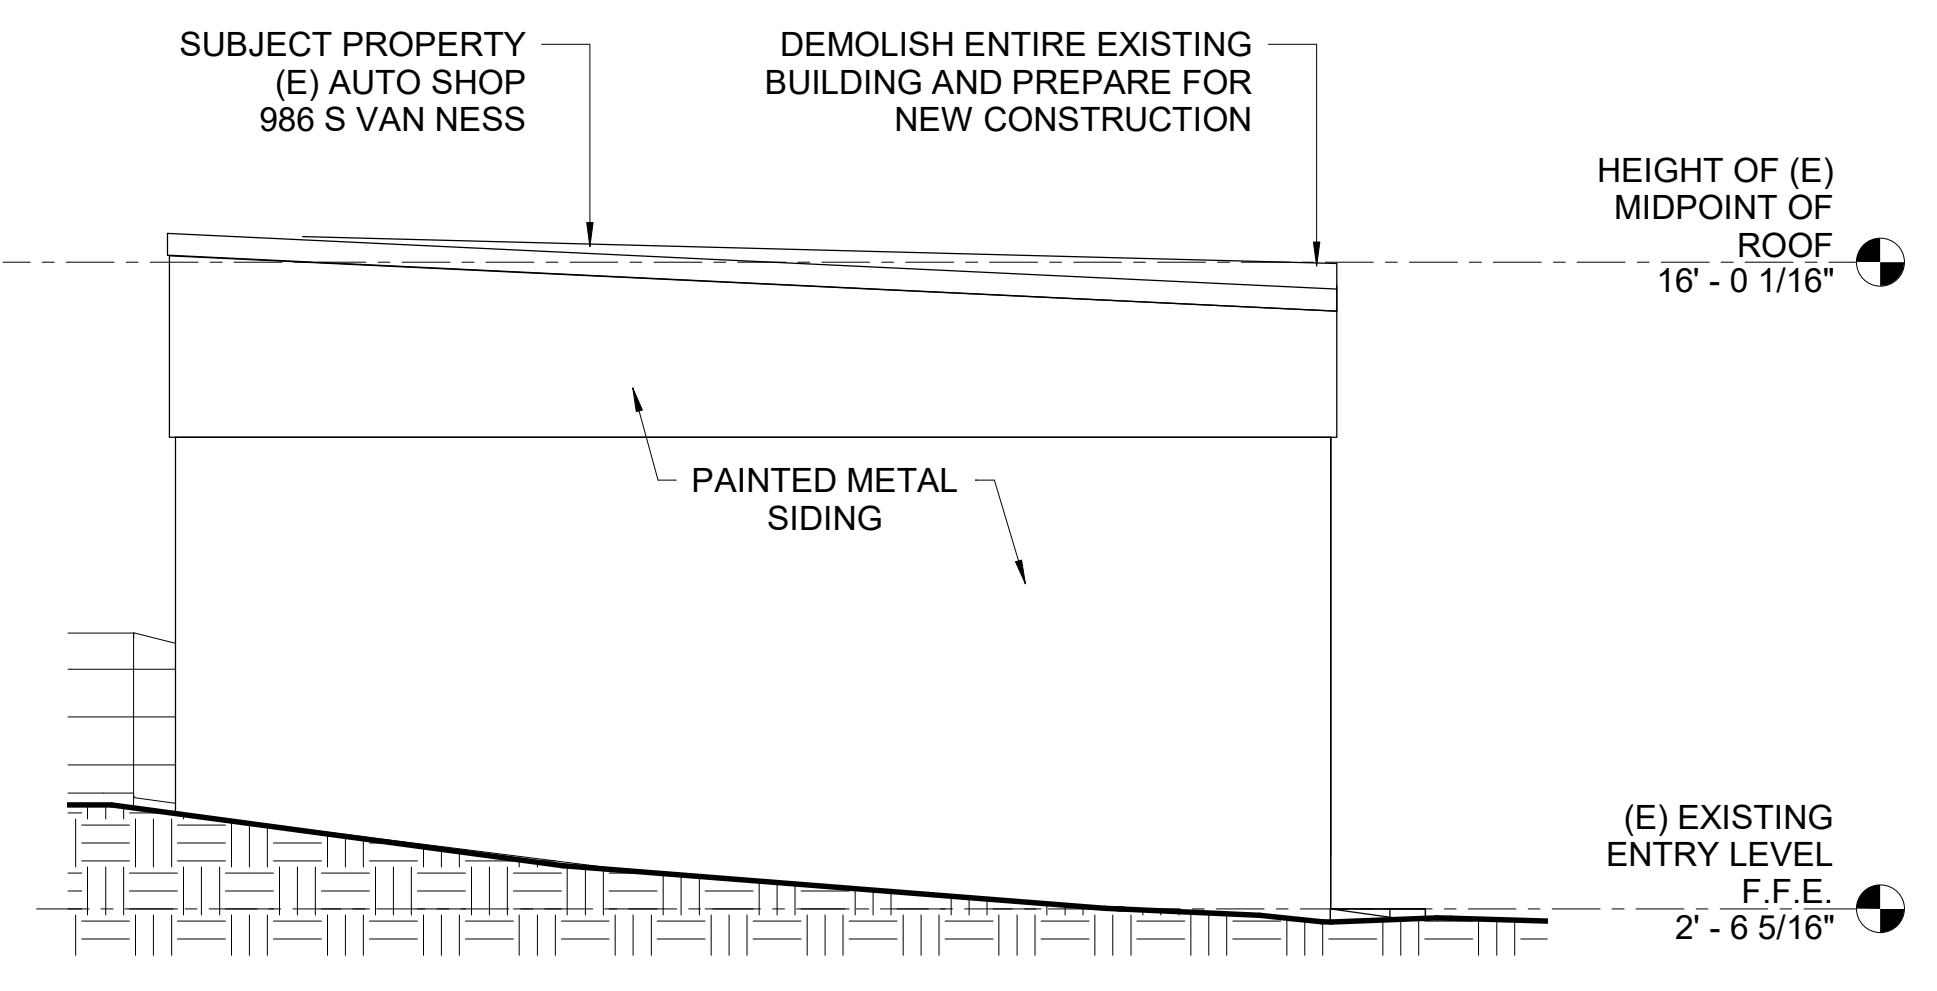


1 EXISTING EAST ELEVATION
1/4" = 1'-0"

FOR DBI USE

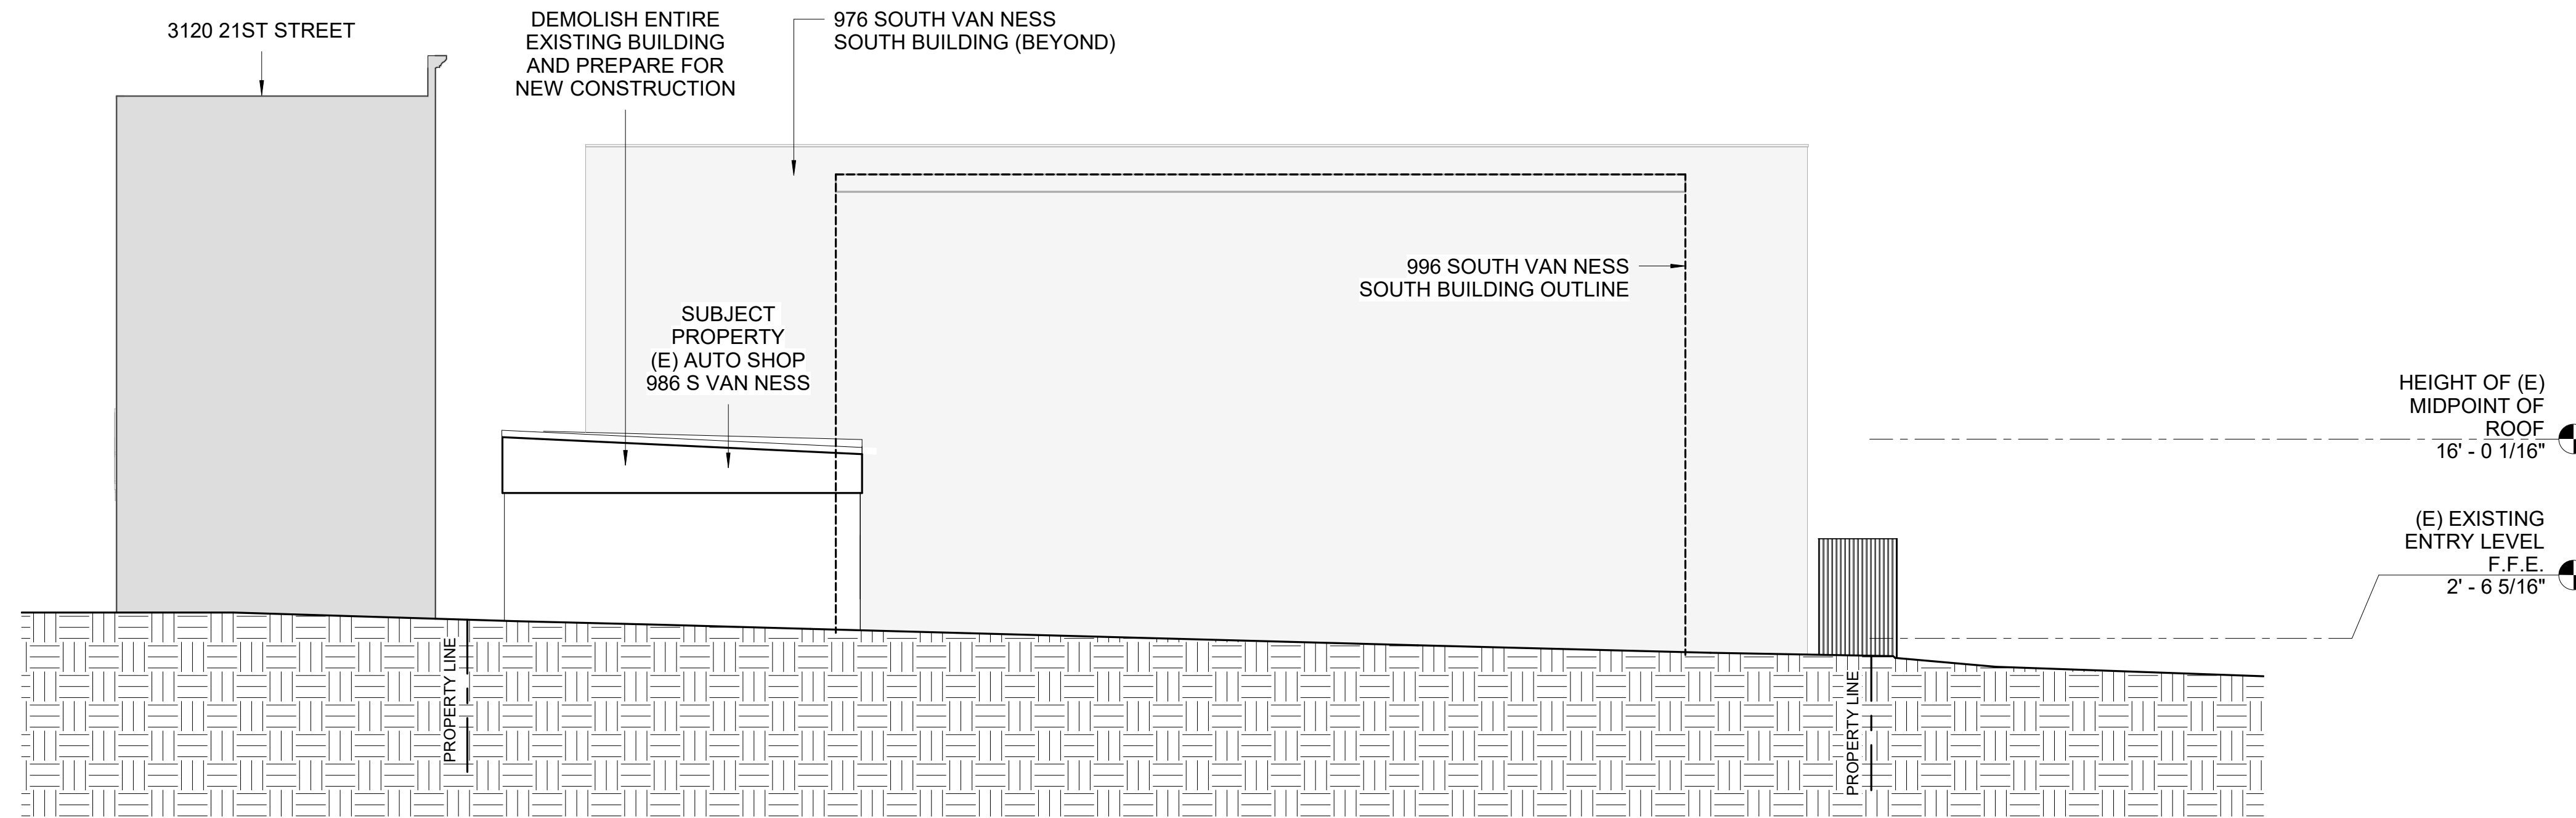

② EXISTING SIDE (SOUTH) ELEVATION
1/8" = 1'-0"

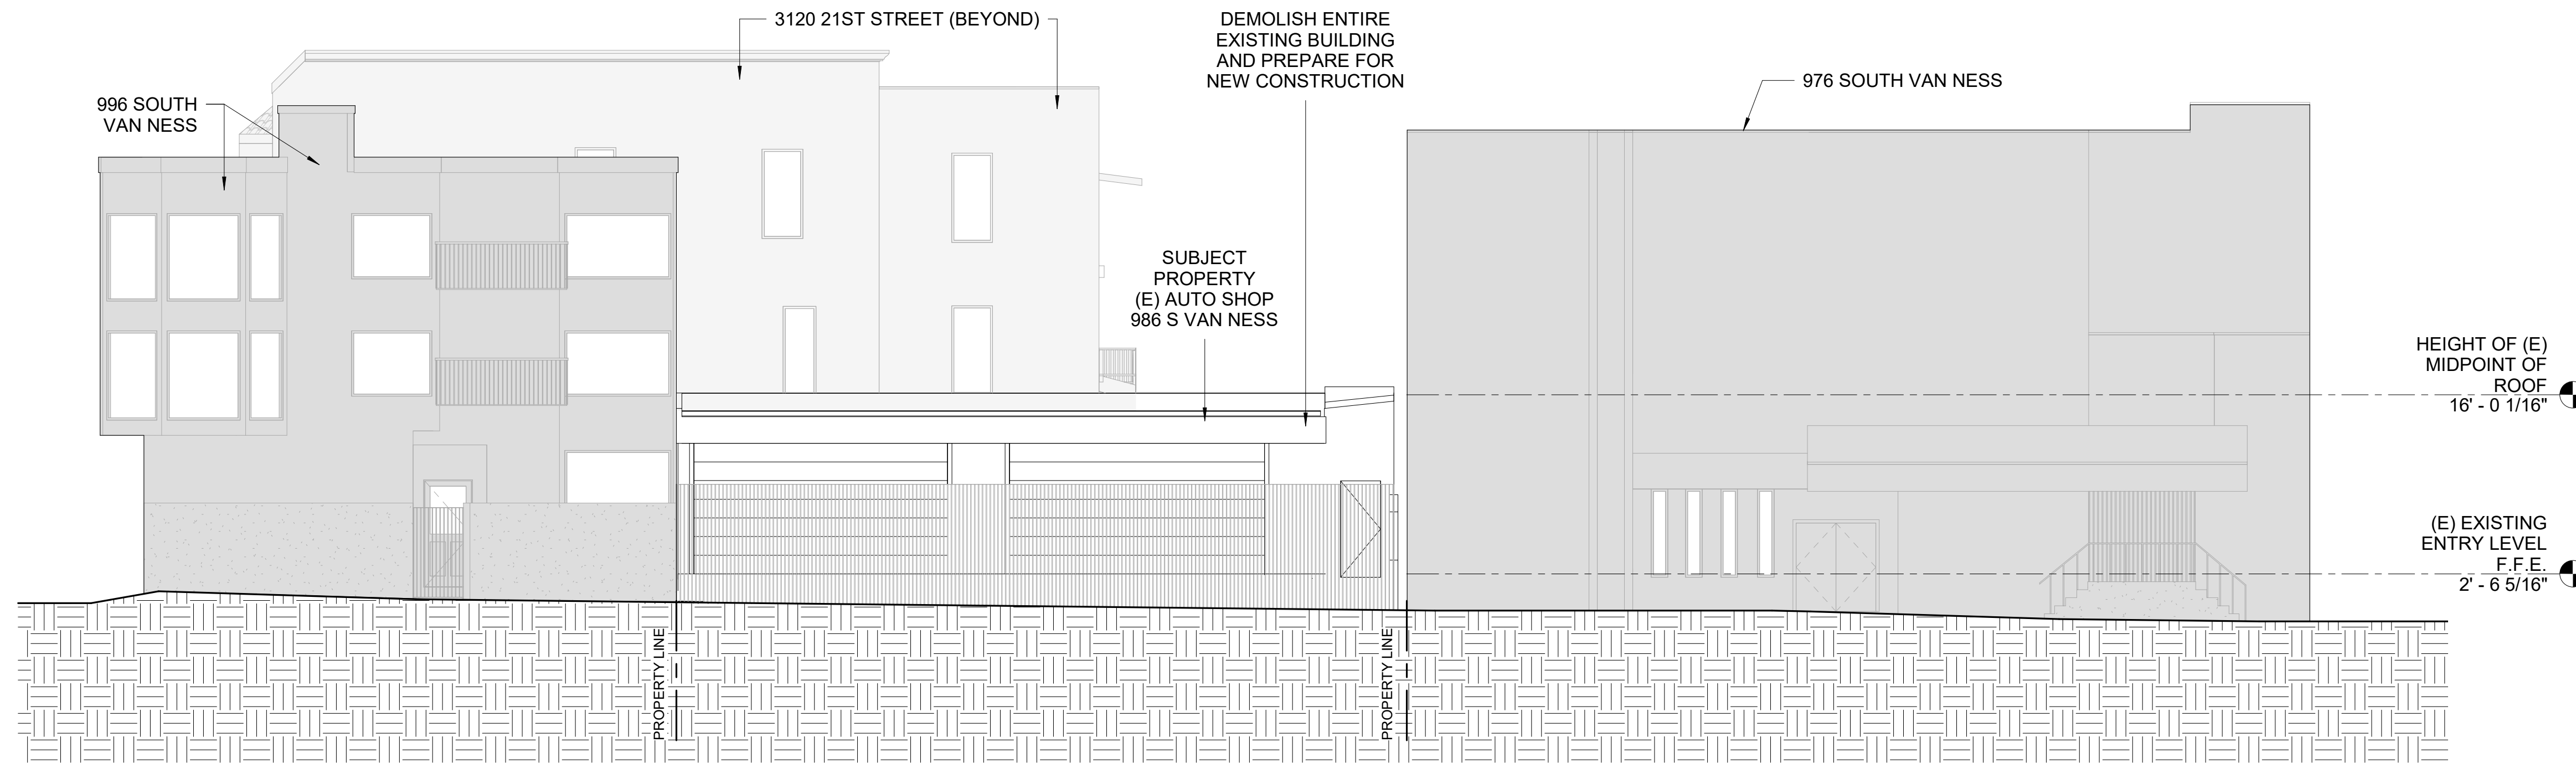

① EXISTING FRONT (EAST) ELEVATION
1/8" = 1'-0"

Kotas/
Pantaleoni
Architects

Anthony A. Pantaleoni
LEED AP
712 Zee Street Suite 200
San Francisco, California 94107
t. 415 496 4051
design@kp-architects.com



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15 RESIDENTIAL UNITS
986 SOUTH VAN NESS AVENUE
SAN FRANCISCO, CA 94110

Sheet Title:
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EXISTING
EXTERIOR
ELEVATIONS

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15 RESIDENTIAL UNITS
986 SOUTH VAN NESS AVENUE
SAN FRANCISCO, CA 94110


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EXTERIOR
ELEVATIONS

Date: 11.19


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Job Number: 2-1119


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1 EXISTING SIDE (NORTH) ELEVATION

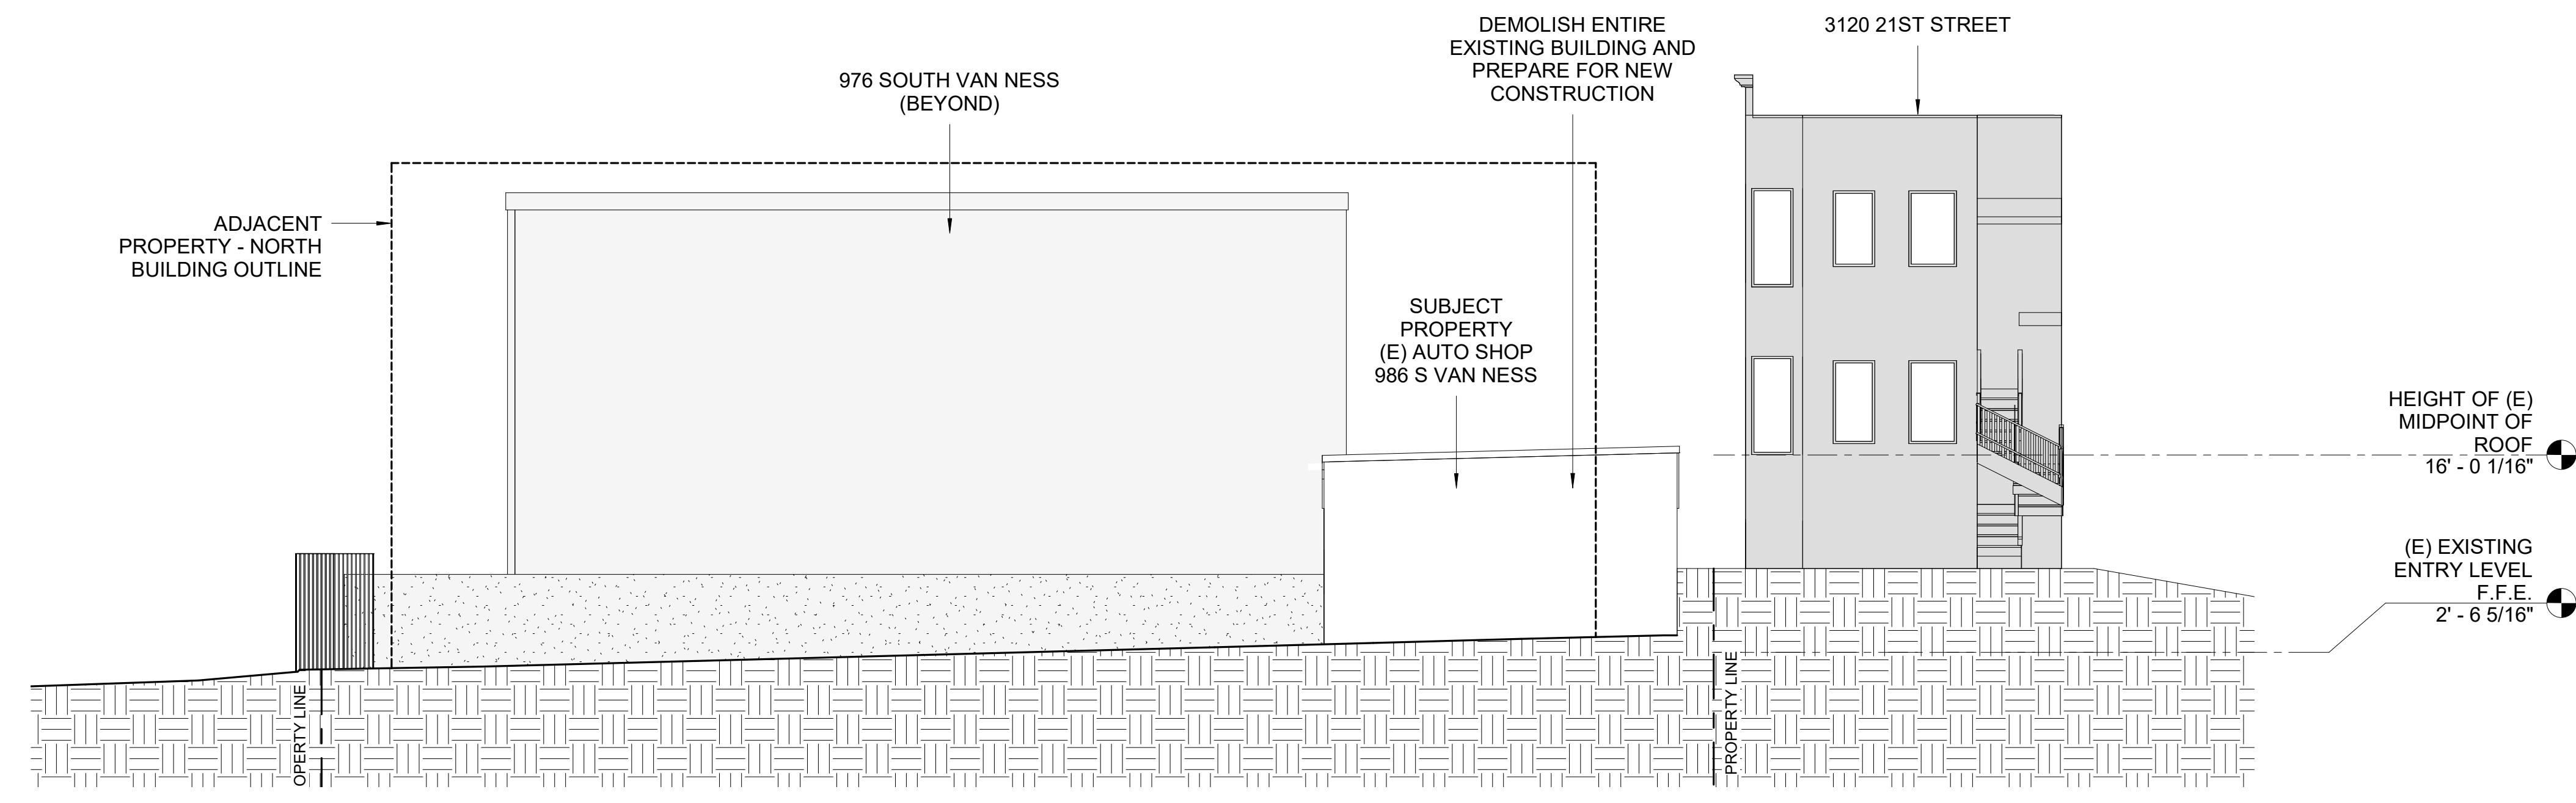


2 EXISTING REAR (WEST) ELEVATION

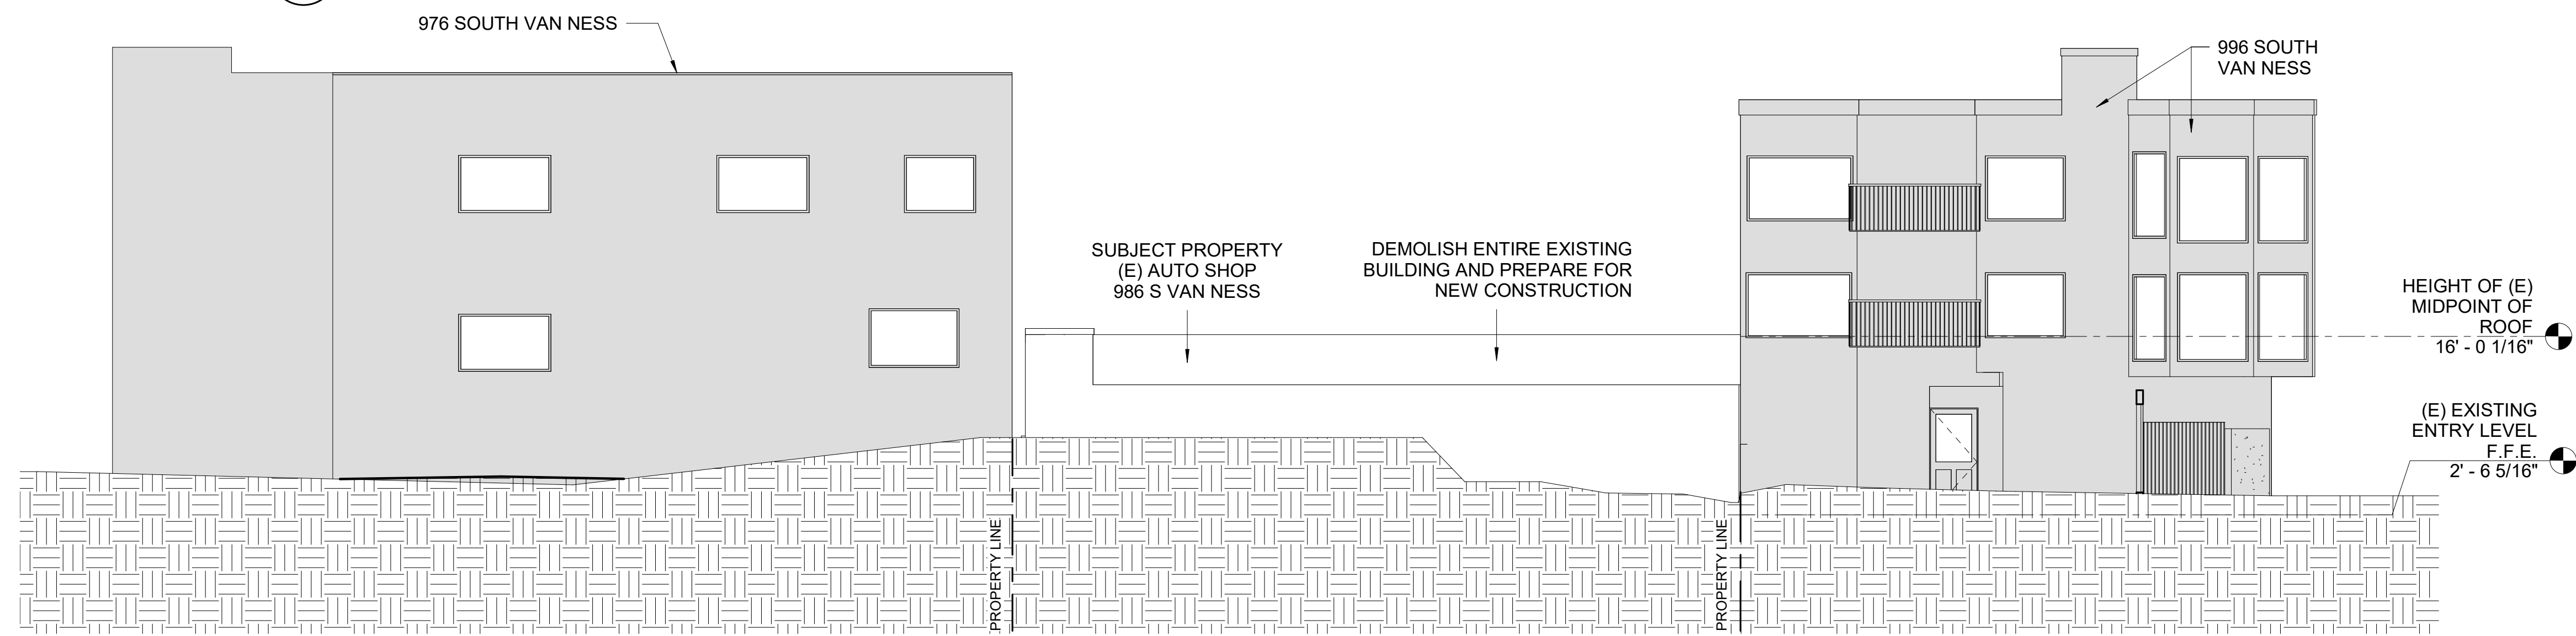


3 EXISTING SITE SECTION
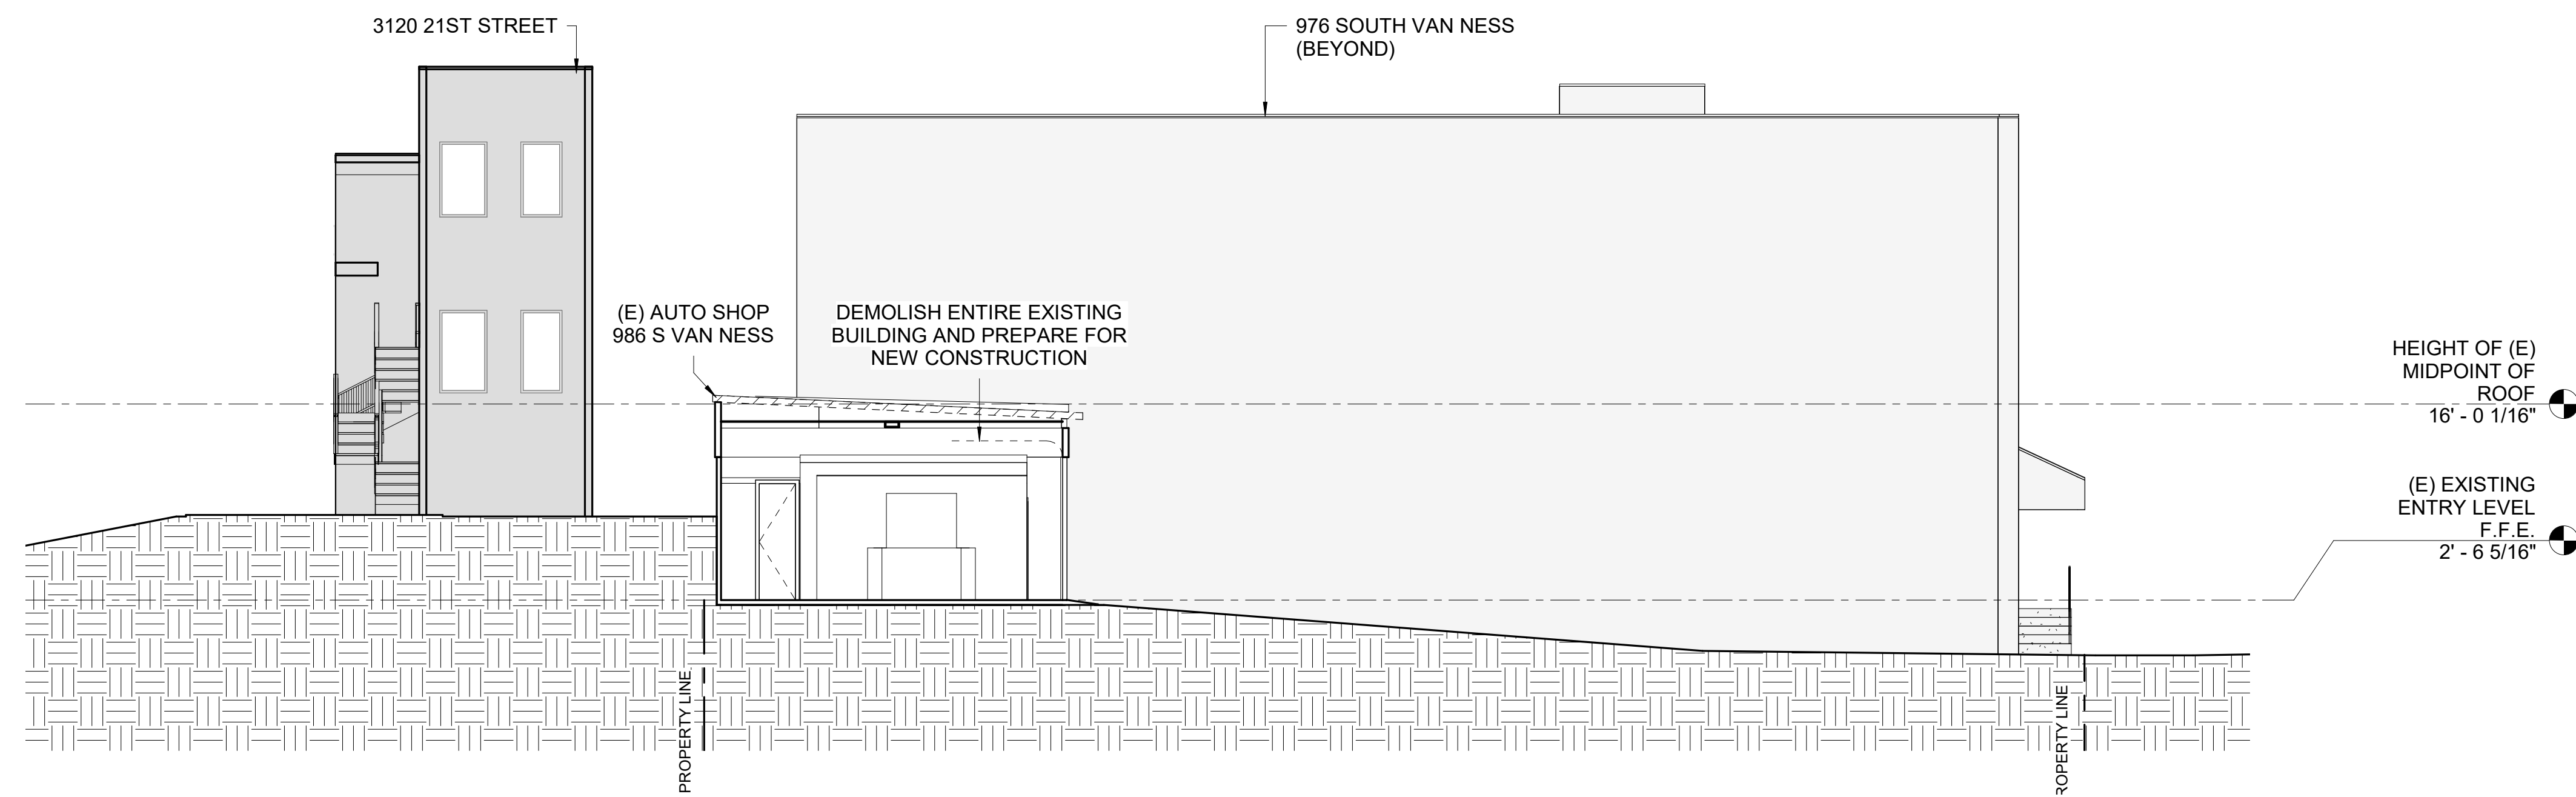
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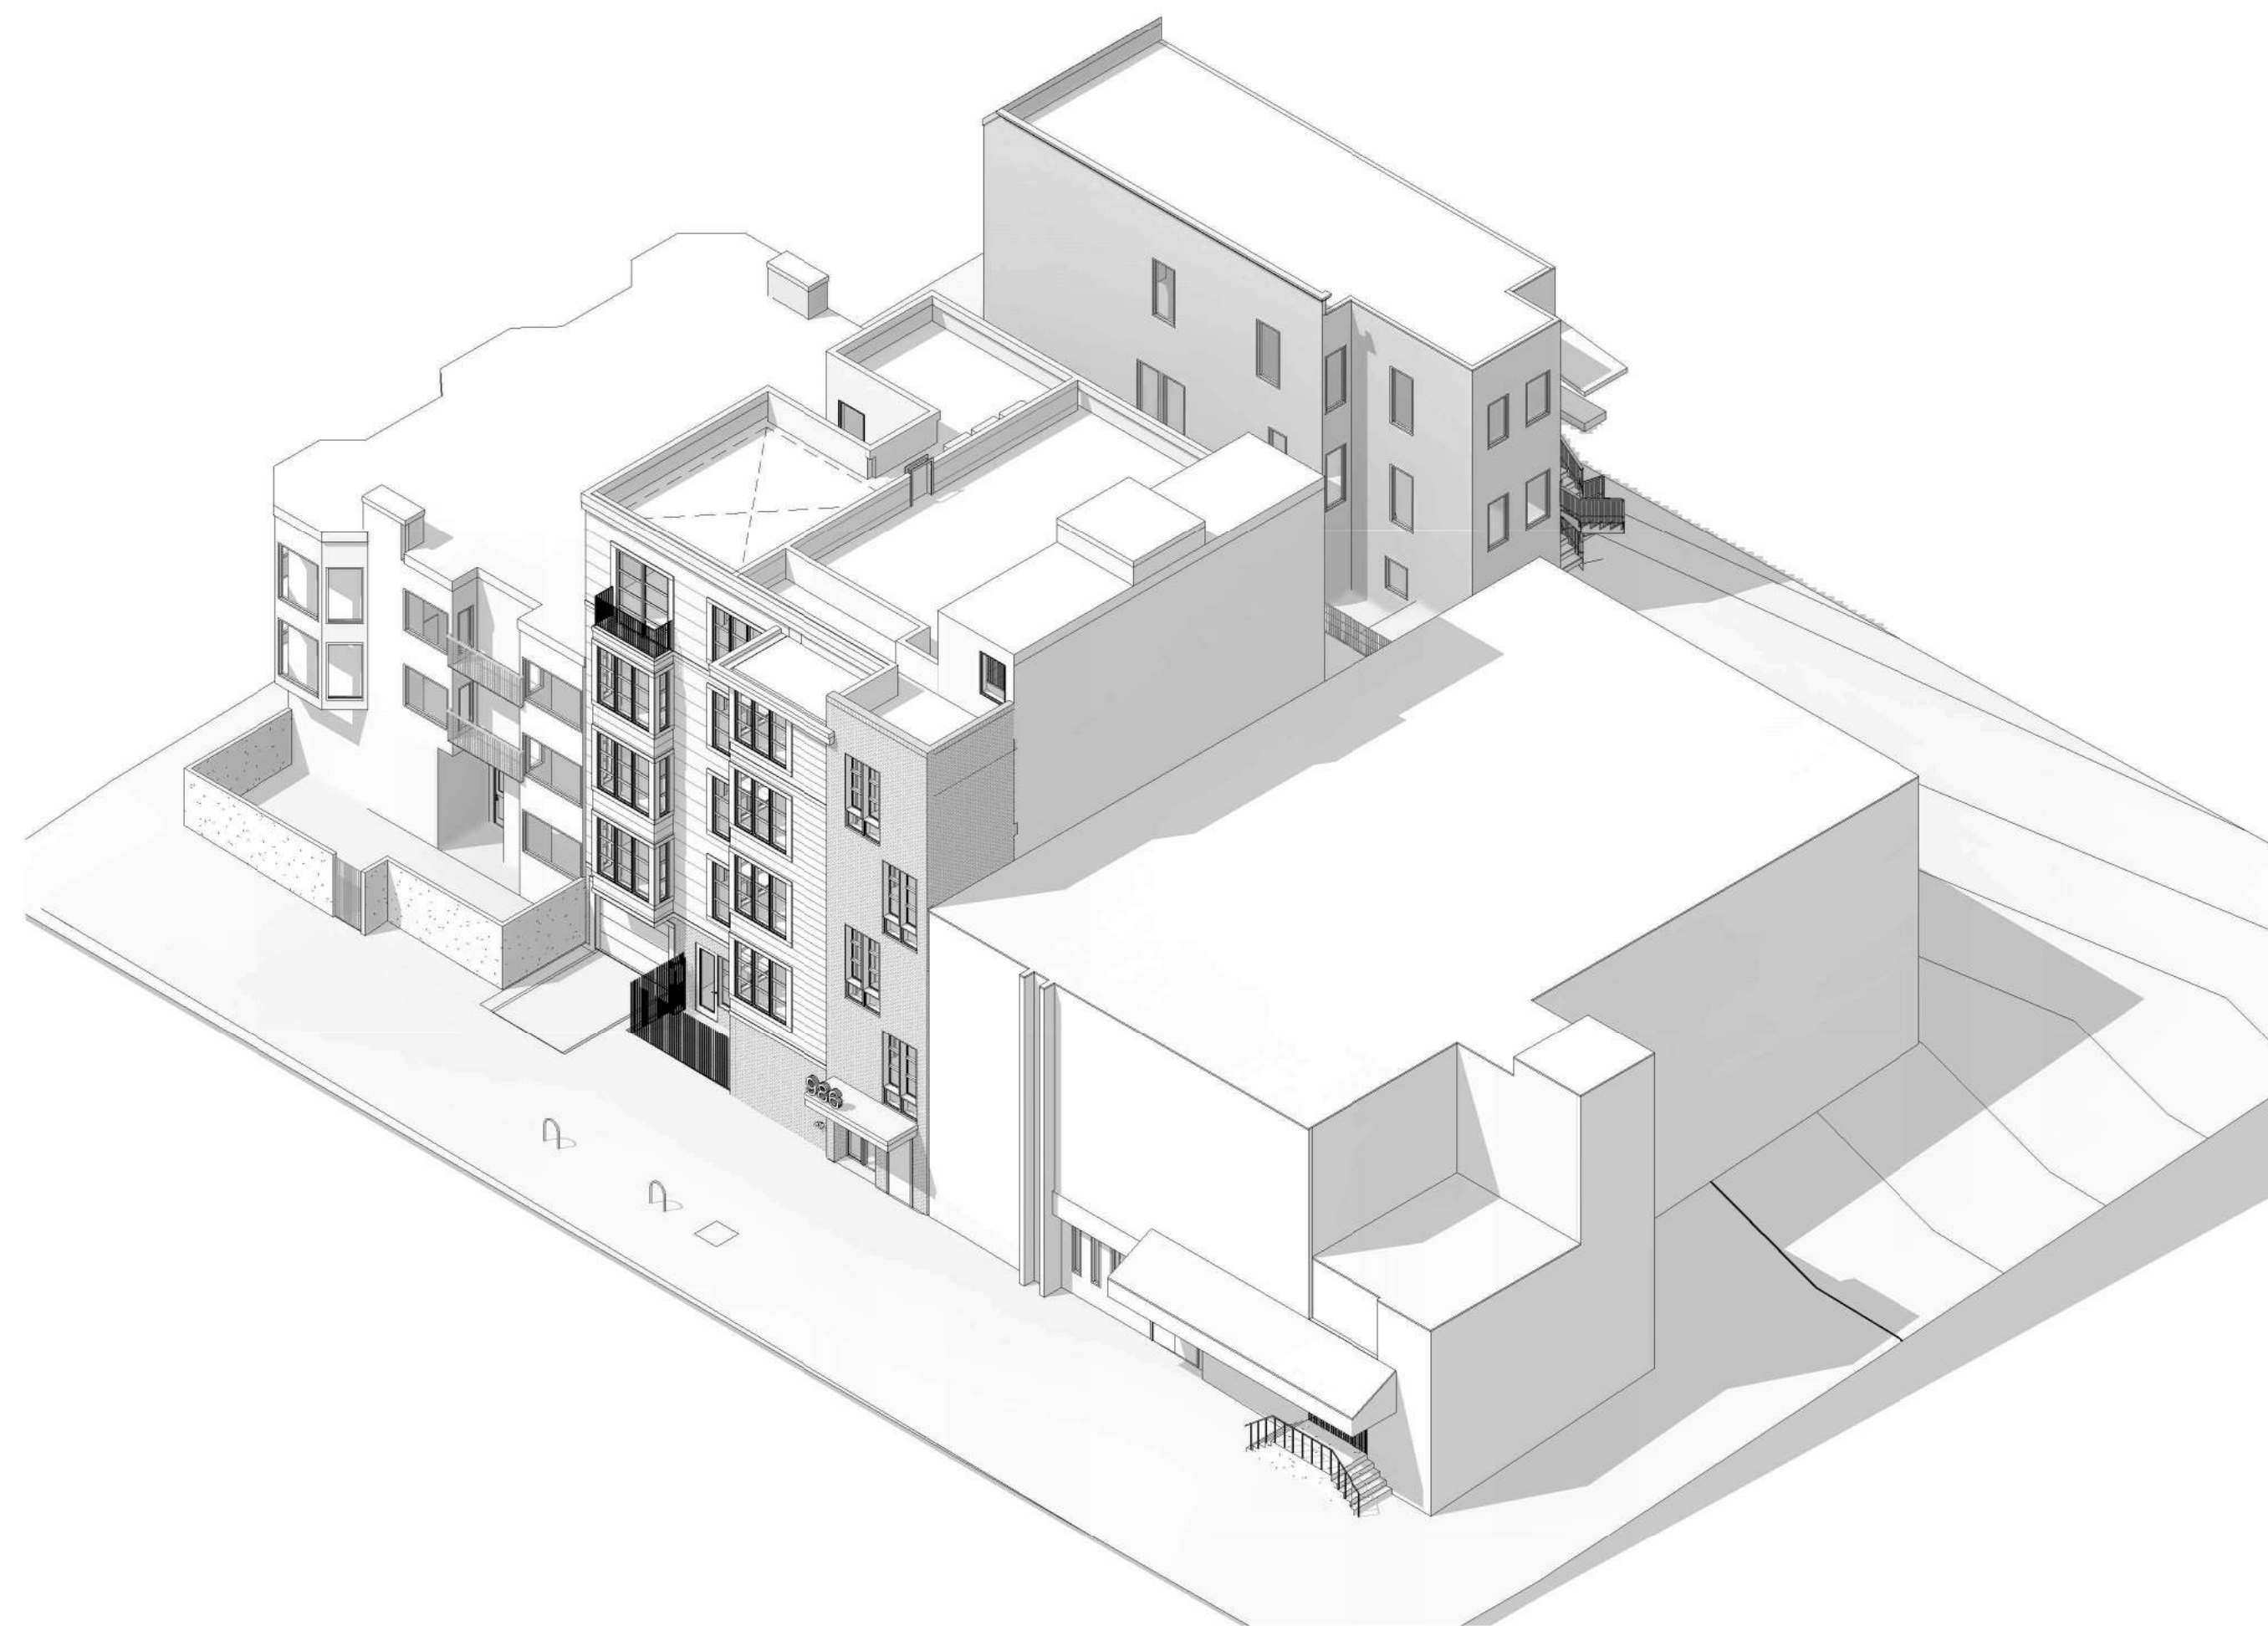
④ PROPOSED AXON - NORTH WEST VIEW

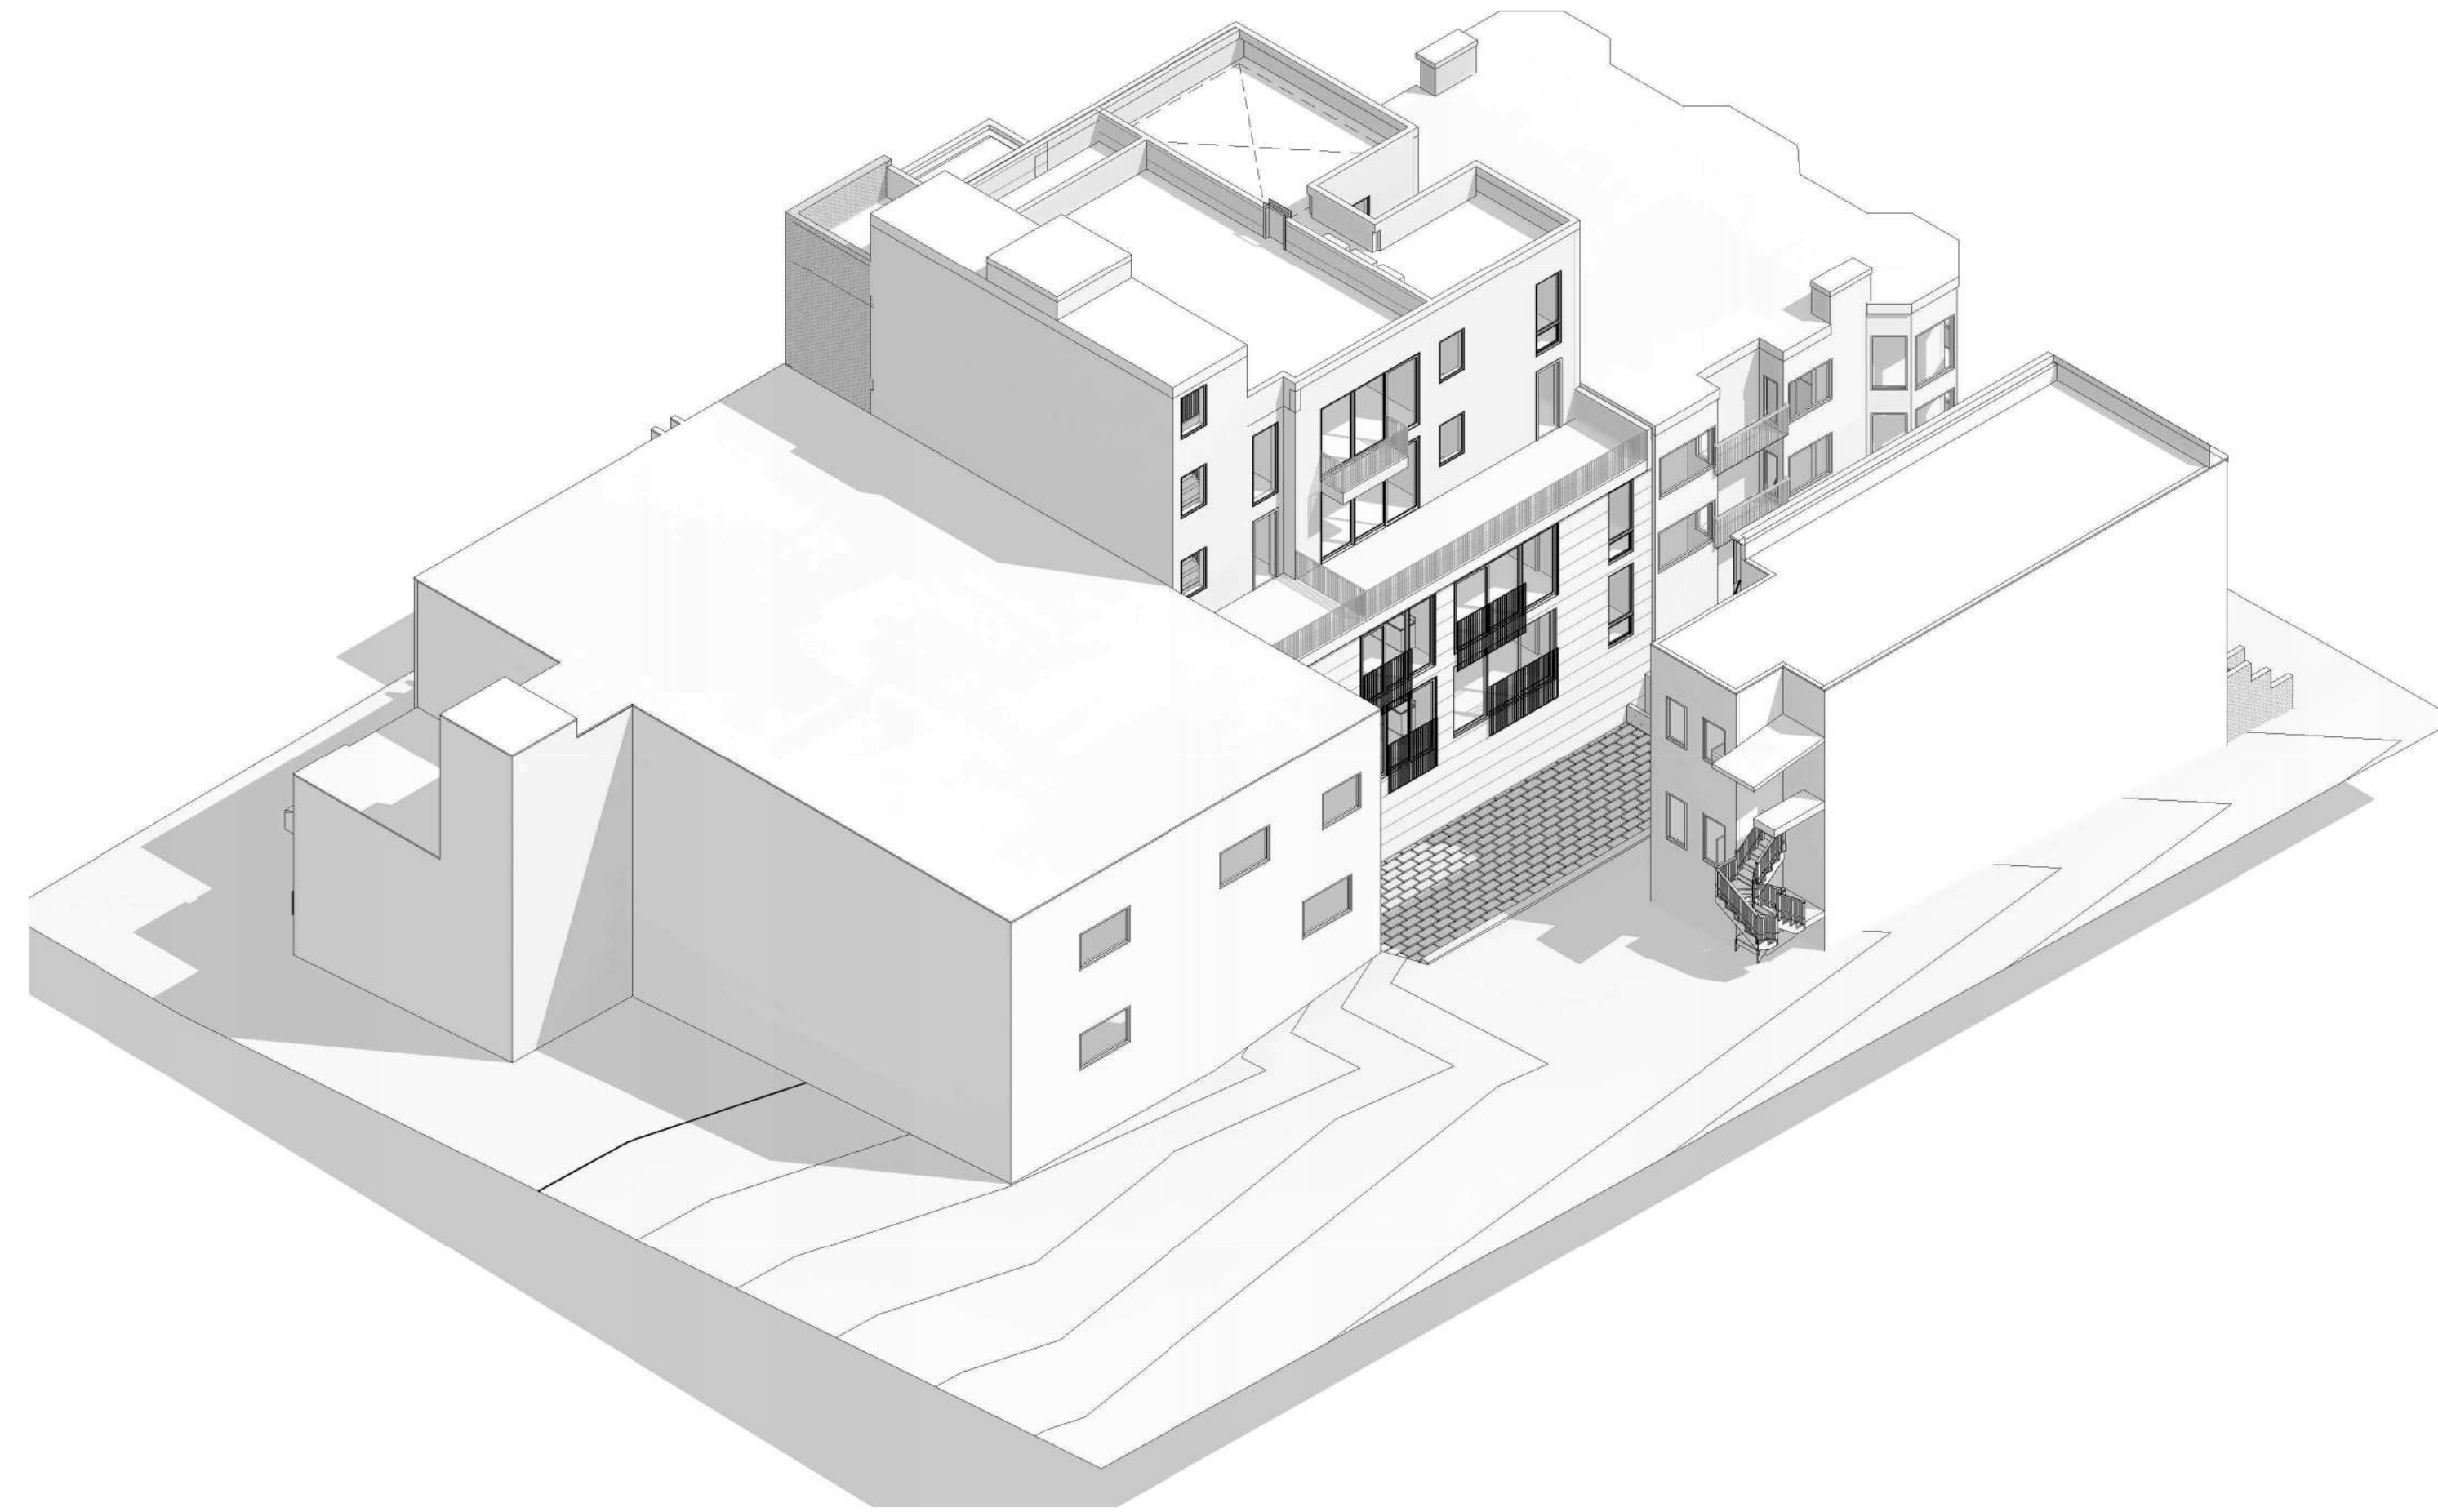

② PROPOSED AXON - SOUTH WEST VIEW

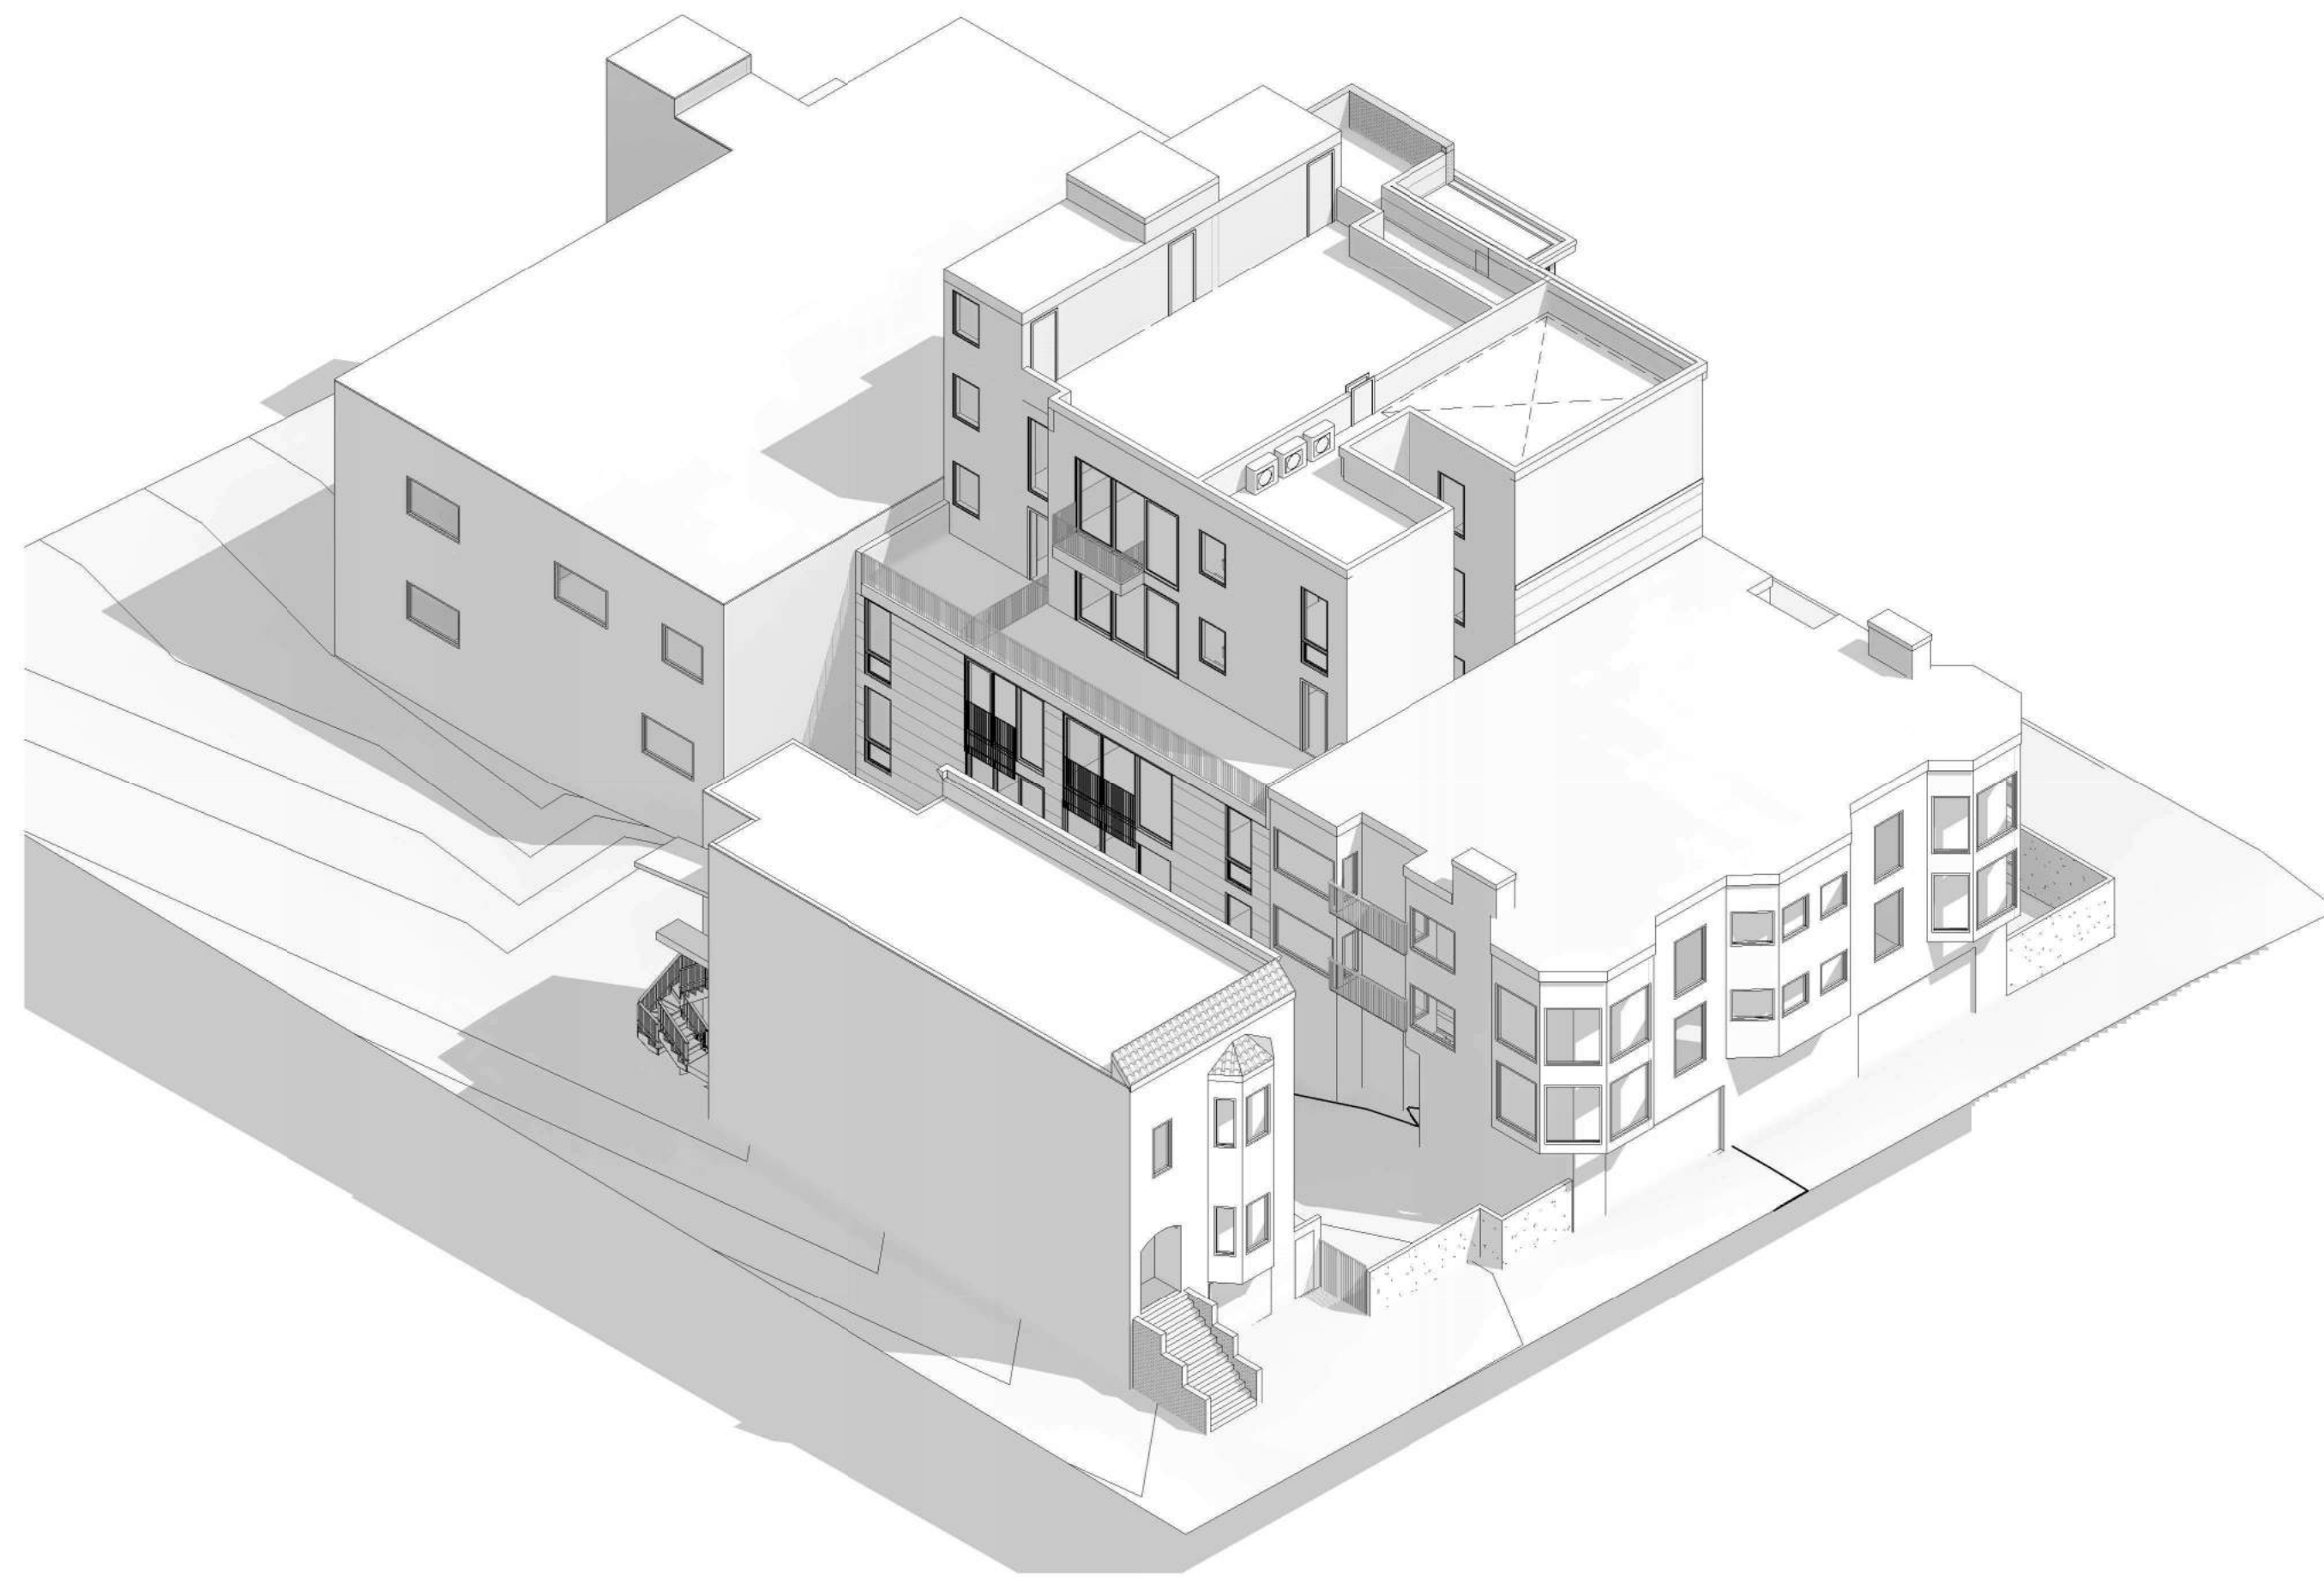

③ PROPOSED AXON - SOUTH EAST VIEW



① PROPOSED AXON - NORTH EAST VIEW

Kotas/
Pantaleoni
Architects

Anthony A. Pantaleoni
LEED AP
712 Zoe Street Suite 200
San Francisco, California 94107
t. 415 496 4051
design@kp-architects.com



Revisions	By
PROGRESS SET 01.15.20	BM
⚠ DBI RESPONSE 03.25.20	BM
⚠ FIRE RESPONSE 04.07.20	BM
PLANNING REVISIONS 05.06.20	BM
⚠ DBI-PLNG RESPONSE 06.30.20	BM

15 RESIDENTIAL UNITS
986 SOUTH VAN NESS AVENUE
SAN FRANCISCO, CA 94110

Sheet Title:
Project Info:
EXTERIOR
AXONS

Date: 11.19

Drawn By: BM

Job Number: 2-1119

DBI USE

A1.9

Kotas/
Pantaleoni
Architects

Anthony A. Pantaleoni
LEED AP
712 Zee Street Suite 200
San Francisco, California 94107
t. 415 496 4051
design@kp-architects.com



Revisions	By
PROGRESS SET 01.15.20	BM
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15 RESIDENTIAL UNITS
986 SOUTH VAN NESS AVENUE
SAN FRANCISCO, CA 94110

Sheet Title:
Project Info:
EXTERIOR
PERSPECTIVES

Date: 11.19
Drawn By: BM
Job Number: 2-1119

A1.10



2 STREET LEVEL PERSPECTIVE - LOOKING NW



3 STREET LEVEL PERSPECTIVE - LOOKING SW




1 STREET LEVEL PERSPECTIVE - FRONT - LOOKING WEST

Printed on: 6/20/2020

DOOR SCHEDULE										
MARK	ROOM NAME	DOOR		TYPE	MATERIAL	FACING/ FINISH	GLASS	FIRE RATING	HDWR. GROUP	NOTES
		WIDTH	HEIGHT							
101	STAIR 1	3'-0"	6'-8"	A	METAL	PAINT		90 MIN.		S.C. W/ CLOSER
102	STAIR 2	3'-0"	6'-8"	A	METAL	PAINT		90 MIN.		S.C. W/ CLOSER
103	ELEVATOR	3'-6"	8'-0"	A	WOOD	PAINT		90 MIN.		S.C. W/ CLOSER ON FUSIBLE LINK
104	ENTRY	3'-0"	8'-0"	J	ALUM	ANODIZED	SINGLE			W/ CLOSER
104A	TERRACE	3'-0"	8'-0"	A	METAL	PAINT		20 MIN.		S.C. W/ CLOSER
104B	MAIL	3'-6"	6'-8"	A	WOOD	PAINT		20 MIN.		S.C. W/ CLOSER
105	BIKES	3'-0"	6'-8"	A	WOOD	PAINT		20 MIN.		S.C. W/ CLOSER
106	GARAGE	9'-9"	8'-4"	G	ALUM	ANODIZED				
106A	GARAGE	3'-6"	6'-8"	A	WOOD	PAINT		80 MIN.		S.C. W/ CLOSER
107	BIKES	3'-0"	6'-8"	A	WOOD	PAINT				
108	GARBAGE	3'-6"	6'-8"	A	WOOD	PAINT				
109	ELECTRICAL	3'-0"	6'-8"	A	WOOD	PAINT		20 MIN.		S.C. W/ CLOSER
110	ENTRY	3'-0"	7'-0"	A	WOOD	PAINT		20 MIN.		S.C. W/ CLOSER
110A	W/D	2'-4"	8'-0"	D	WOOD	PAINT				
110B	CLOSET	6'-0"	7'-0"	F	WOOD	PAINT				
111	TERRACE	3'-0"	7'-8"	C	ALUM CLAD WOOD	PAINT	DOUBLE			MIN. 31 OITC
112	ADA BATH	3'-0"	7'-0"	A	WOOD	PAINT				
201	STAIR 1	3'-0"	6'-8"	A	WOOD	PAINT		90 MIN.		S.C. W/ CLOSER
202	STAIR 2	3'-0"	6'-8"	A	WOOD	PAINT		90 MIN.		S.C. W/ CLOSER
203	ELEVATOR	3'-6"	8'-0"	A	WOOD	PAINT		90 MIN.		S.C. W/ CLOSER ON FUSIBLE LINK
210	ENTRY	3'-0"	8'-0"	A	WOOD	PAINT		20 MIN.		S.C. W/ CLOSER
211	CLOSET	3'-0"	8'-0"	A	WOOD	PAINT				
211A	W/D	2'-8"	8'-0"	D	WOOD	PAINT				
212	ADA BATH	3'-0"	8'-0"	E	WOOD	PAINT				S.C.
212A	LINEN	1'-6"	8'-0"	A	WOOD	PAINT				
214	BEDROOM 1	3'-0"	8'-0"	A	WOOD	PAINT				S.C.
214A	CLOSET	8'-6"	7'-0"	F	WOOD	PAINT				
220	ENTRY	3'-0"	8'-0"	A	WOOD	PAINT		20 MIN.		S.C. W/ CLOSER
220A	W/D	3'-0"	8'-0"	D	WOOD	PAINT				
222	LINEN	3'-8"	6'-8"	B	WOOD	PAINT				
223	ADA BATH	3'-0"	8'-0"	E	WOOD	PAINT				
224	BEDROOM 1	3'-0"	8'-0"	A	WOOD	PAINT				S.C.
224A	CLOSET	7'-0"	7'-0"	F	WOOD	PAINT				
230	ENTRY	3'-0"	8'-0"	A	WOOD	PAINT		20 MIN.		S.C. W/ CLOSER
231	W/D	2'-8"	8'-0"	D	WOOD	PAINT				
232	ADA BATH	3'-0"	8'-0"	E	WOOD	PAINT				S.C.
233	BALCONY	11'-0"	8'-6"	K	ALUM CLAD WOOD	PAINT	DOUBLE			
234	BEDROOM 1	3'-0"	8'-0"	A	WOOD	PAINT				S.C.
234A	CLOSET	5'-0"	7'-0"	F	WOOD	PAINT				
235	BEDROOM 2	3'-0"	8'-0"	A	WOOD	PAINT				S.C.
235A	CLOSET	5'-0"	7'-0"	F	WOOD	PAINT				
235B	DECK	3'-0"	8'-6"	C	ALUM CLAD WOOD	PAINT	DOUBLE			
240	ENTRY	3'-0"	8'-0"	A	WOOD	PAINT		20 MIN.		S.C. W/ CLOSER
241	W/D	2'-8"	8'-0"	D	WOOD	PAINT				
242	ADA BATH	3'-0"	8'-0"	E	WOOD	PAINT				S.C.
243	BALCONY	11'-0"	8'-6"	K1	ALUM CLAD WOOD	PAINT	DOUBLE			
244	BEDROOM 1	3'-0"	8'-0"	A	WOOD	PAINT				S.C.
244A	CLOSET	5'-0"	7'-0"	F	WOOD	PAINT				
245	BEDROOM 2	3'-0"	8'-0"	A	WOOD	PAINT				S.C.
245A	CLOSET	5'-0"	7'-0"	F	WOOD	PAINT				
245B	DECK	3'-6"	8'-0"	C	ALUM CLAD WOOD	PAINT	DOUBLE			
301	STAIR 1	3'-0"	6'-8"	A	WOOD	PAINT		90 MIN.		S.C. W/ CLOSER
302	STAIR 2	3'-0"	6'-8"	A	WOOD	PAINT		90 MIN.		S.C. W/ CLOSER
303	ELEVATOR	3'-6"	8'-0"	A	WOOD	PAINT		90 MIN.		S.C. W/ CLOSER ON FUSIBLE LINK
310	ENTRY	3'-0"	8'-0"	A	WOOD	PAINT		20 MIN.		S.C. W/ CLOSER
311	CLOSET	3'-0"	8'-0"	A	WOOD	PAINT				
311A	W/D	2'-8"	8'-0"	D	WOOD	PAINT				
312	ADA BATH	3'-0"	8'-0"	E	WOOD	PAINT				S.C.
312A	LINEN	1'-6"	8'-0"	A	WOOD	PAINT				
314	BEDROOM 1	3'-0"	8'-0"	A	WOOD	PAINT				S.C.
314A	CLOSET	8'-6"	7'-0"	F	WOOD	PAINT				
320	ENTRY	3'-0"	8'-0"	A	WOOD	PAINT		20 MIN.		S.C. W/ CLOSER
320A	W/D	3'-0"	8'-0"	D	WOOD	PAINT				
322	LINEN	3'-8"	6'-8"	B	WOOD	PAINT				
323	ADA BATH	3'-0"	8'-0"	E	WOOD	PAINT				S.C.
324	BEDROOM 1	3'-0"	8'-0"	A	WOOD	PAINT				S.C.
324A	CLOSET	8'-6"	7'-0"	F	WOOD	PAINT				
330	ENTRY	3'-0"	8'-0"	A	WOOD	PAINT		20 MIN.		S.C. W/ CLOSER
331	W/D	2'-8"	8'-0"	D	WOOD	PAINT				
332	ADA BATH	3'-0"	8'-0"	E	WOOD	PAINT				S.C.
333	BALCONY	11'-0"	8'-6"	K	ALUM CLAD WOOD	PAINT	DOUBLE			
334	BEDROOM 1	3'-0"	8'-0"	A	WOOD	PAINT				S.C.
334A	CLOSET	5'-0"	7'-0"	E	WOOD	PAINT				
335	BEDROOM 2	3'-0"	8'-0"	A	WOOD	PAINT				S.C.
335A	CLOSET	5'-0"	7'-0"	F	WOOD	PAINT				
340	ENTRY	3'-0"	8'-0"	A	WOOD	PAINT		20 MIN.		S.C. W/ CLOSER
341	W/D	2'-8"	8'-0"	D	WOOD	PAINT				
342	ADA BATH	3'-0"	8'-0"	E	WOOD	PAINT				S.C.
343	BALCONY	11'-0"	8'-6"	K1	ALUM CLAD WOOD	PAINT	DOUBLE			
344	BEDROOM 1	3'-0"	8'-0"	A	WOOD	PAINT				S.C.
344A	CLOSET	5'-0"	7'-0"	F	WOOD	PAINT				
345	BEDROOM 2	3'-0"	8'-0"	A	WOOD	PAINT				S.C.
345A	CLOSET	5'-0"	7'-0"	F	WOOD	PAINT				
401	STAIR 1	3'-0"	6'-8"	A	WOOD	PAINT		90 MIN.		S.C. W/ CLOSER
402	STAIR 2	3'-0"	6'-8"	A	WOOD	PAINT		90 MIN.		S.C. W/ CLOSER
403	ELEVATOR	3'-6"	8'-0"	A	WOOD	PAINT		90 MIN.		S.C. W/ CLOSER ON FUSIBLE LINK

DOOR SCHEDULE										
MARK	ROOM NAME	DOOR		TYPE	MATERIAL	FACING/ FINISH	GLASS	FIRE RATING	HDWR. GROUP	NOTES
		WIDTH	HEIGHT							
410	ENTRY	3'-0"	8'-0"	A	WOOD	PAINT		20 MIN.		S.C. W/ CLOSER
411	CLOSET	3'-0"	8'-0"	A	WOOD	PAINT				
411A	W/D	2'-8"	8'-0"	D	WOOD	PAINT				
412	ADA BATH	3'-0"	8'-0"	E	WOOD	PAINT				S.C.
412A	LINEN	1'-6"	8'-0"	A	WOOD	PAINT				
414	BEDROOM 1	3'-0"	8'-0"	A	WOOD	PAINT				S.C.
414A	CLOSET	8'-6"	7'-0"	F	WOOD	PAINT				
420	ENTRY	3'-0"	8'-0"	A	WOOD	PAINT		20 MIN.		S.C. W/ CLOSER
420A	W/D	3'-0"	8'-0"	D	WOOD	PAINT				
422	LINEN	3'-8"	6'-8"	B	WOOD	PAINT				
423	ADA BATH	3'-0"	8'-0"	E	WOOD	PAINT				S.C.
424	BEDROOM 1	3'-0"	8'-0"	A	WOOD	PAINT				S.C.
424A	CLOSET	8'-6"	7'-0"	F	WOOD	PAINT				
430	ENTRY	3'-0"	8'-0"	A	WOOD	PAINT		20 MIN.		S.C. W/ CLOSER
432	DECK	7'-6"	8'-6"	K1	ALUM CLAD WOOD	PAINT	DOUBLE			MIN. 23 OITC
433	BEDROOM 1	3'-0"	8'-0"	A	WOOD	PAINT				S.C.
433A	CLOSET	5'-0"	7'-0"	F	WOOD	PAINT				
433B	DECK	9'-0"	8'-6"	K	ALUM CLAD WOOD	PAINT	DOUBLE			MIN. 23 OITC
434	ADA BATH	3'-0"	8'-0"	E	WOOD	PAINT				S.C.
434A	W/D	4'-0"	6'-8"	B1	WOOD	PAINT				
435	BEDROOM 2	3'-0"	8'-0"	A	WOOD	PAINT				S.C.
435A	CLOSET	6'-0"	7'-0"	F	WOOD	PAINT				
435B	DECK	9'-0"	8'-6"	K	ALUM CLAD WOOD	PAINT	DOUBLE			MIN. 23 OITC
501	STAIR 1	3'-0"	6'-8"	A	WOOD	PAINT		90 MIN.		S.C. W/ CLOSER
502	STAIR 2	3'-0"	6'-8"	A	WOOD	PAINT		90 MIN.		S.C. W/ CLOSER
503	ELEVATOR	3'-6"	8'-0"	A	WOOD	PAINT		90 MIN.		S.C. W/ CLOSER ON FUSIBLE LINK
510	ENTRY	3'-0"	8'-0"	A	WOOD	PAINT		20 MIN.		S.C. W/ CLOSER
511	CLOSET	3'-0"	8'-0"	A	WOOD	PAINT				
511A	W/D	2'-8"	8'-0"	D	WOOD	PAINT				
512	ADA BATH	3'-0"	8'-0"	E	WOOD	PAINT				S.C.
512A	LINEN	1'-6"	8'-0"	A	WOOD	PAINT				
514	BEDROOM 1	3'-0"	8'-0"	A	WOOD	PAINT				S.C.
514A	CLOSET	8'-6"	7'-0"	F	WOOD	PAINT				
520	ENTRY	3'-0"	8'-0"	A	WOOD	PAINT		20 MIN.		S.C. W/ CLOSER
520A	W/D	3'-0"	8'-0"	D	WOOD	PAINT				
522	LINEN	3'-8"	6'-8"	B	WOOD	PAINT				
523	ADA BATH	3'-0"	8'-0"	E	WOOD	PAINT				S.C.
524	BEDROOM 1	3'-0"	8'-0"	A	WOOD	PAINT				S.C.
524A	CLOSET	8'-6"	7'-0"	F	WOOD	PAINT				
524B	DECK	6'-8"	8'-6"	H1	ALUM CLAD WOOD	PAINT	DOUBLE			MIN. 27 OITC
530	ENTRY	3'-0"	8'-0"	A	WOOD	PAINT		20 MIN.		S.C. W/ CLOSER
532	DECK	7'-6"	8'-6"	K1	ALUM CLAD WOOD	PAINT	DOUBLE			MIN. 23 OITC
533	BEDROOM 1	3'-0"	8'-0"	A	WOOD	PAINT				S.C.
533A	CLOSET	5'-0"	7'-0"	F	WOOD	PAINT				
533B	BALCONY	9'-0"	8'-6"	K1	ALUM CLAD WOOD	PAINT	DOUBLE			MIN. 23 OITC
534	ADA BATH	3'-0"	8'-0"	E	WOOD	PAINT				S.C.
534A	W/D	4'-0"	6'-8"	B1	WOOD	PAINT				
535	BEDROOM 2	3'-0"	8'-0"	A	WOOD	PAINT				S.C.
535A	CLOSET	6'-0"	7'-0"	F	WOOD	PAINT				
535B	BALCONY	9'-0"	8'-6"	K	ALUM CLAD WOOD	PAINT	DOUBLE			MIN. 23 OITC
601	STAIR 1	3'-0"	6'-8"	A	METAL	PAINT		90 MIN.		S.C. W/ CLOSER
602	STAIR 2	3'-0"	6'-8"	A	METAL	PAINT		90 MIN.		S.C. W/ CLOSER
603	ELEVATOR	3'-6"	8'-0"	A	METAL	PAINT		90 MIN.		S.C. W/ CLOSER
604	ELEVATOR CONTROL	3'-0"	6'-8"	A	METAL	PAINT		90 MIN.		S.C. W/ CLOSER
605	ELEVATOR CONTROL	6'-0"	6'-8"	A	METAL	PAINT				S.C. W/ CLOSER

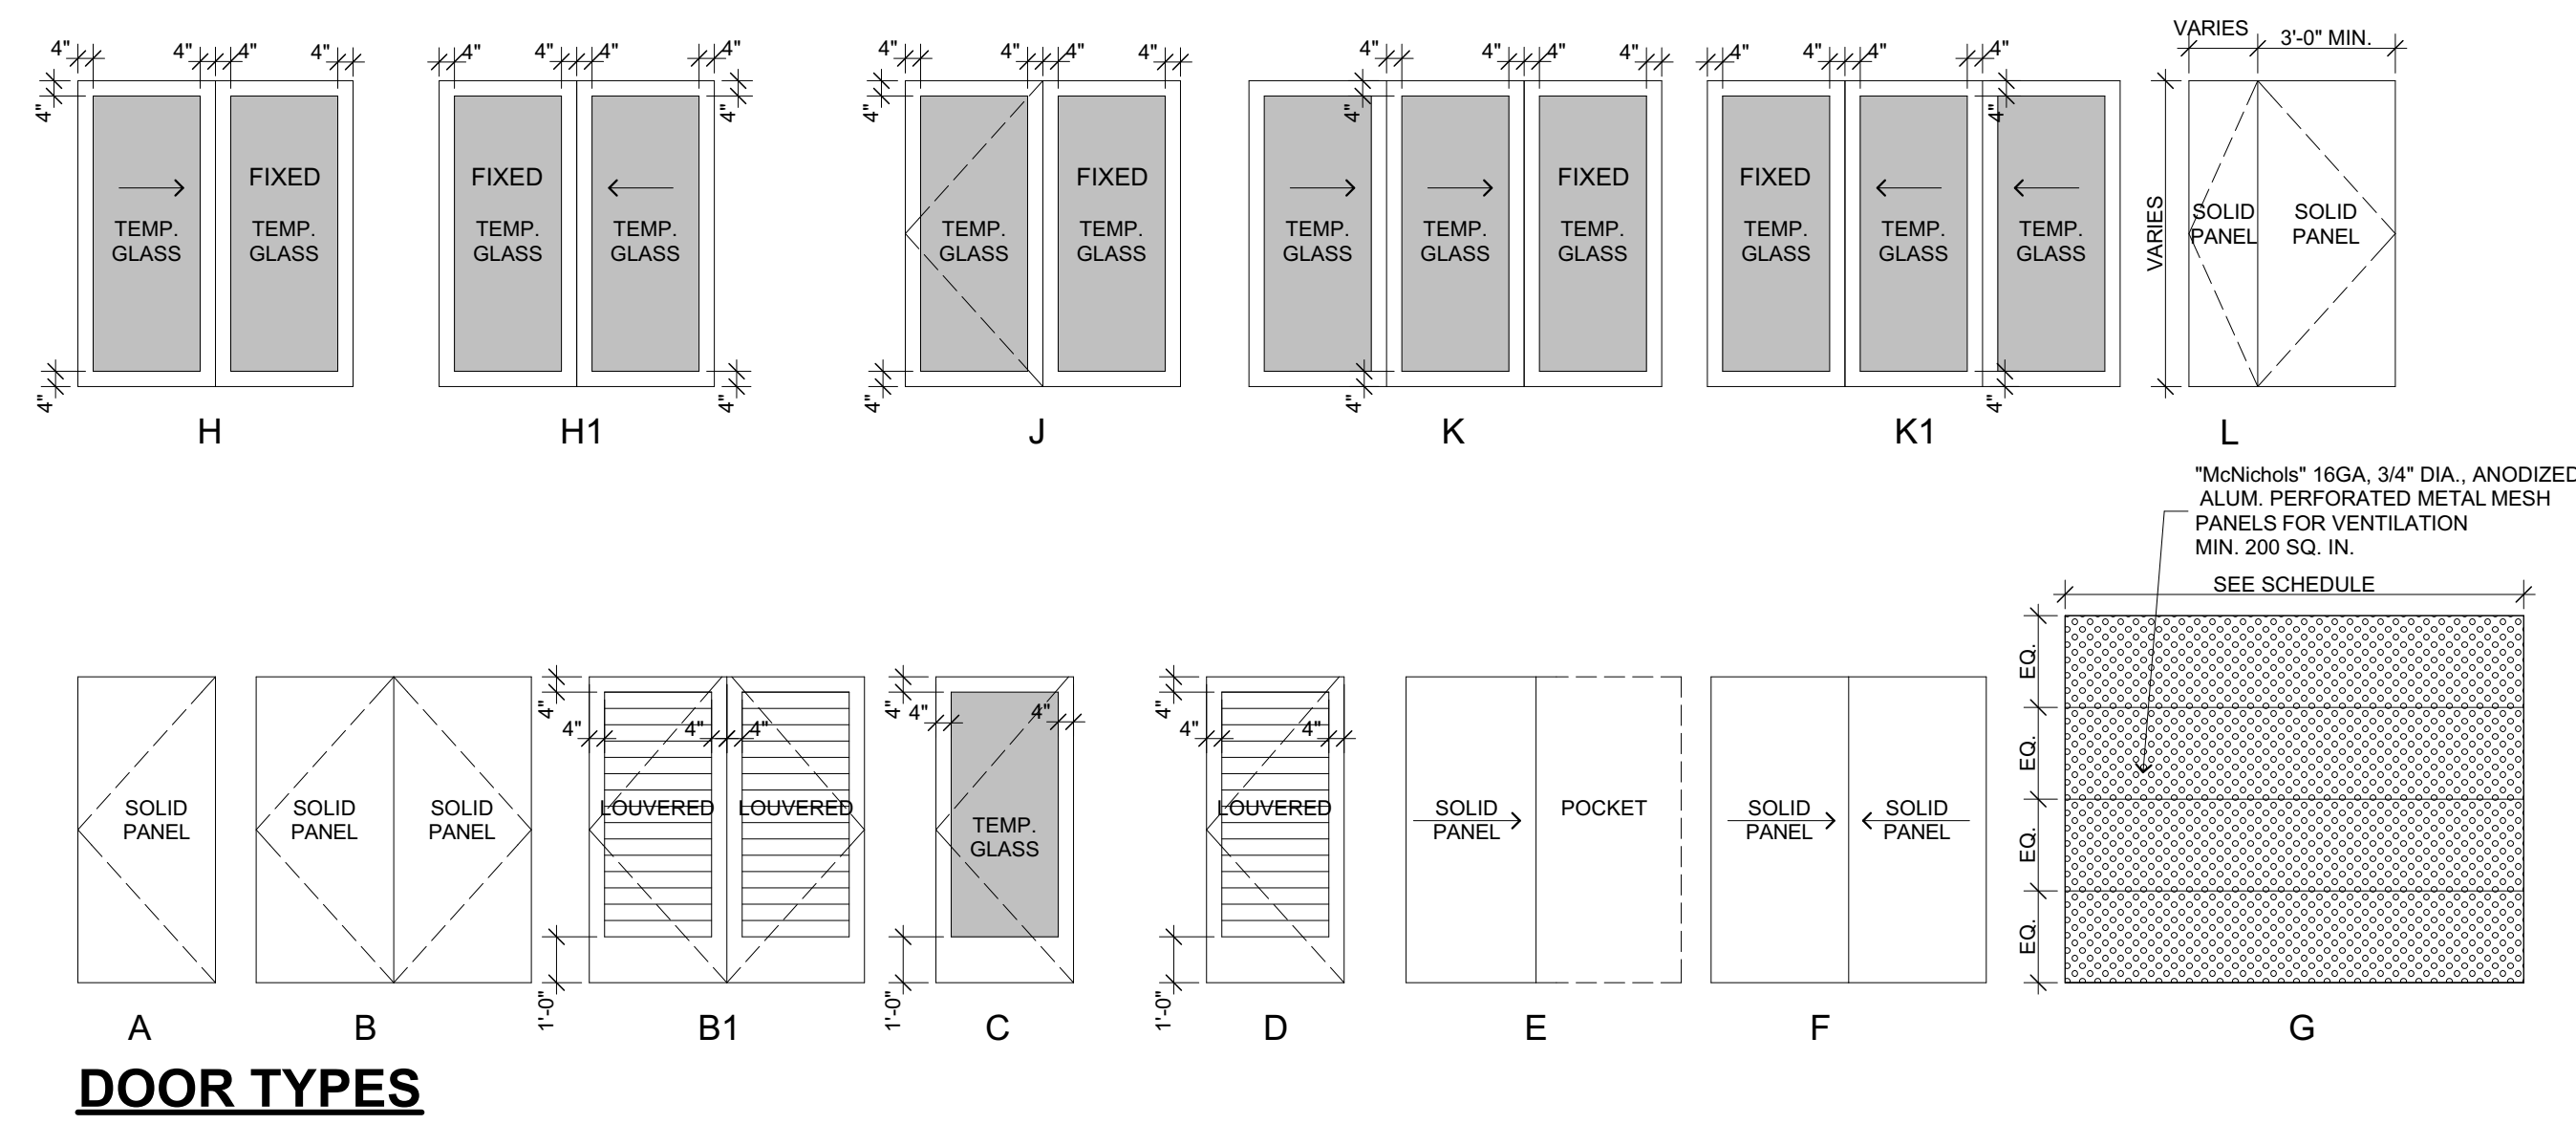

FOR DBI USE

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Revisions	By
PROGRESS SET 01.15.20	BM
DBI RESPONSE 03.25.20	BM
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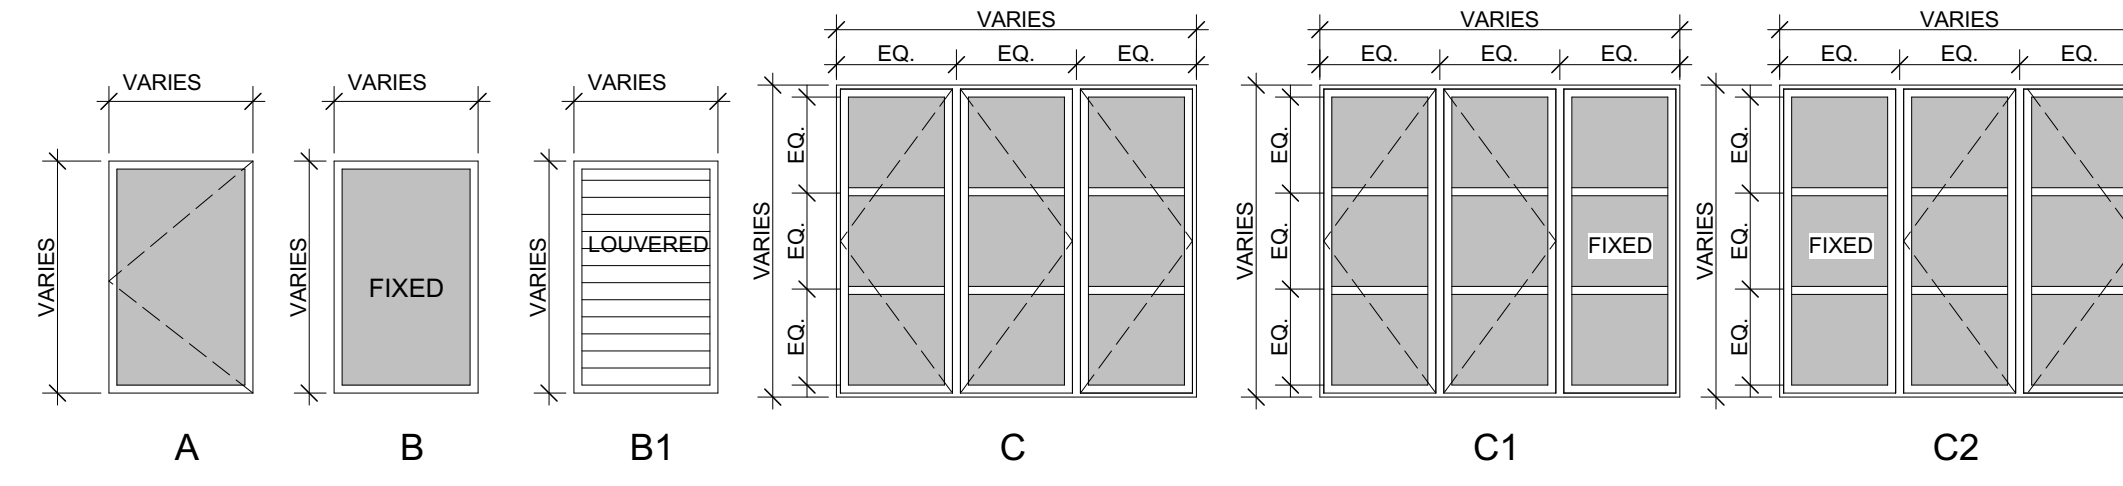
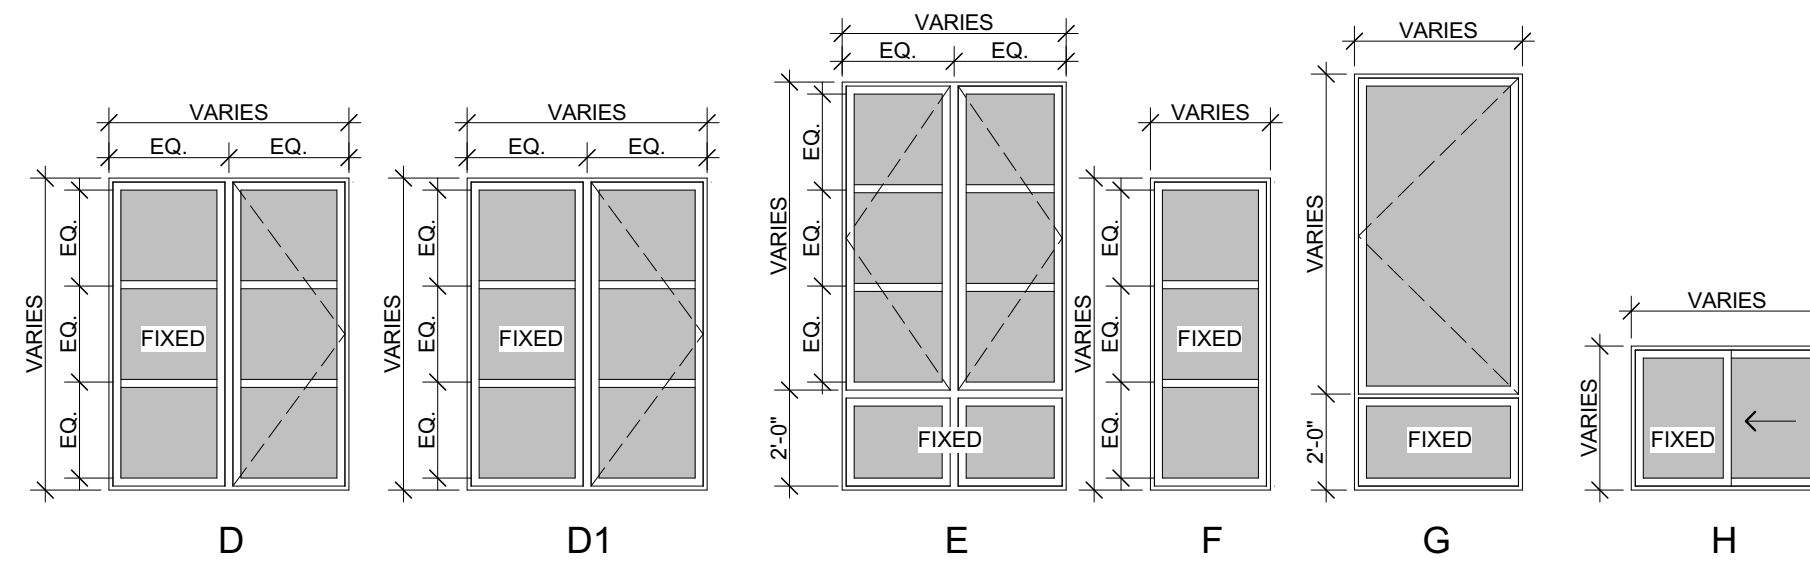
15 RESIDENTIAL UNITS
986 SOUTH VAN NESS AVENUE
SAN FRANCISCO, CA 94110

Sheet Title:
Floor Plans:
DOOR
SCHEDULE

Date: 11.19
Drawn By: BM
Job Number: 2-1119

A2.0a

MARK	ROOM	SIZE		SILL HEIGHT	TYPE	MATERIAL	GLASS	NOTES
		WIDTH	HEIGHT					
106	GARAGE	5'-0"	2'-0"	6'-8"	B1	ANOZIDED ALUM		
109	ELECTRICAL ROOM	5'-0"	2'-0"	6'-8"	B1	ANOZIDED ALUM		
111	LIVE/DINE	6'-6"	4'-2"	3'-6"	C2	ALUM. CLAD WOOD	DOUBLE	MIN. 31 OITC
112	ADA BATH	4'-6"	6'-8"	1'-0"	D1	ALUM. CLAD WOOD	DOUBLE	MIN. 23 OITC
213	LIVE/DINE	7'-6"	6'-6"	2'-0"	C	ALUM. CLAD WOOD	DOUBLE	MIN. 35 OITC
213A	LIVE/DINE	5'-0"	6'-6"	2'-0"	D	ALUM. CLAD WOOD	DOUBLE	MIN. 35 OITC
214	BEDROOM 1	4'-8"	8'-6"	0'-0"	E	ALUM. CLAD WOOD	DOUBLE	MIN. 29 OITC
222	LIVE/DINE	7'-6"	6'-6"	2'-0"	C1	ALUM. CLAD WOOD	DOUBLE	MIN. 29 OITC
224	BEDROOM 1	7'-6"	6'-6"	2'-0"	C	ALUM. CLAD WOOD	DOUBLE	MIN. 31 OITC
224A	BEDROOM 1	1'-8"	6'-8"	2'-0"	F	ALUM. CLAD WOOD	DOUBLE	MIN. 31 OITC
224B	BEDROOM 1	1'-8"	6'-6"	2'-0"	F	ALUM. CLAD WOOD	DOUBLE	MIN. 31 OITC
232	ADA BATH	2'-8"	4'-6"	3'-6"	B	ALUM. CLAD WOOD	DOUBLE	MIN. 23 OITC
234	BEDROOM 1	3'-6"	8'-8"	0'-0"	G	ALUM. CLAD WOOD	DOUBLE	MIN. 23 OITC
244	BEDROOM 1	3'-6"	8'-8"	0'-0"	G	ALUM. CLAD WOOD	DOUBLE	MIN. 23 OITC
313	LIVE/DINE	7'-6"	6'-6"	2'-0"	C	ALUM. CLAD WOOD	DOUBLE	MIN. 35 OITC
313A	LIVE/DINE	5'-0"	6'-6"	2'-0"	D	ALUM. CLAD WOOD	DOUBLE	MIN. 35 OITC
314	BEDROOM 1	4'-8"	8'-6"	0'-0"	E	ALUM. CLAD WOOD	DOUBLE	MIN. 29 OITC
322	LIVE/DINE	7'-6"	6'-6"	2'-0"	C1	ALUM. CLAD WOOD	DOUBLE	MIN. 29 OITC
324	BEDROOM 1	7'-6"	6'-6"	2'-0"	C	ALUM. CLAD WOOD	DOUBLE	MIN. 29 OITC
324A	BEDROOM 1	1'-8"	6'-8"	2'-0"	F	ALUM. CLAD WOOD	DOUBLE	MIN. 29 OITC
324B	BEDROOM 1	1'-8"	6'-6"	2'-0"	F	ALUM. CLAD WOOD	DOUBLE	MIN. 29 OITC
332	ADA BATH	2'-8"	4'-6"	3'-6"	B	ALUM. CLAD WOOD	DOUBLE	MIN. 23 OITC
334	BEDROOM 1	3'-6"	8'-8"	0'-0"	G	ALUM. CLAD WOOD	DOUBLE	MIN. 23 OITC
335	BEDROOM 2	3'-6"	8'-8"	0'-0"	G	ALUM. CLAD WOOD	DOUBLE	MIN. 23 OITC
344	BEDROOM 1	3'-6"	8'-8"	0'-0"	G	ALUM. CLAD WOOD	DOUBLE	MIN. 23 OITC
345	BEDROOM 2	3'-6"	8'-8"	0'-0"	G	ALUM. CLAD WOOD	DOUBLE	MIN. 23 OITC
413	LIVE/DINE	7'-6"	6'-6"	2'-0"	C	ALUM. CLAD WOOD	DOUBLE	MIN. 35 OITC
413A	LIVE/DINE	5'-0"	6'-6"	2'-0"	D	ALUM. CLAD WOOD	DOUBLE	MIN. 35 OITC
414	BEDROOM 1	4'-8"	8'-6"	0'-0"	E	ALUM. CLAD WOOD	DOUBLE	MIN. 29 OITC
422	LIVE/DINE	7'-6"	6'-6"	2'-0"	C1	ALUM. CLAD WOOD	DOUBLE	MIN. 27 OITC
424	BEDROOM 1	7'-6"	6'-6"	2'-0"	C	ALUM. CLAD WOOD	DOUBLE	MIN. 29 OITC
424A	BEDROOM 1	1'-8"	6'-8"	2'-0"	F	ALUM. CLAD WOOD	DOUBLE	MIN. 29 OITC
424B	BEDROOM 1	1'-8"	6'-6"	2'-0"	F	ALUM. CLAD WOOD	DOUBLE	MIN. 29 OITC
431	KITCHEN	3'-0"	4'-0"	3'-6"	A	ALUM. CLAD WOOD	DOUBLE	MIN. 23 OITC
432	LIVE/DINE	4'-0"	8'-8"	0'-0"	G	ALUM. CLAD WOOD	DOUBLE	MIN. 23 OITC
434	ADA BATH	4'-0"	3'-0"	5'-0"	H	ALUM. CLAD WOOD	DOUBLE	MIN. 23 OITC
435	BEDROOM 2	3'-6"	8'-8"	0'-0"	G	ALUM. CLAD WOOD	DOUBLE	MIN. 23 OITC
513	LIVE/DINE	7'-6"	6'-6"	2'-0"	C	ALUM. CLAD WOOD	DOUBLE	MIN. 31 OITC
513A	LIVE/DINE	5'-0"	6'-6"	2'-0"	D	ALUM. CLAD WOOD	DOUBLE	MIN. 31 OITC
514	BEDROOM 1	4'-8"	8'-6"	0'-0"	E	ALUM. CLAD WOOD	DOUBLE	MIN. 27 OITC
522	LIVE/DINE	7'-6"	6'-6"	2'-0"	C1	ALUM. CLAD WOOD	DOUBLE	MIN. 27 OITC
531	KITCHEN	3'-0"	4'-0"	3'-6"	A	ALUM. CLAD WOOD	DOUBLE	MIN. 23 OITC
532	LIVE/DINE	4'-0"	8'-8"	0'-0"	G	ALUM. CLAD WOOD	DOUBLE	MIN. 23 OITC
534	ADA BATH	4'-0"	3'-0"	5'-0"	H	ALUM. CLAD WOOD	DOUBLE	MIN. 23 OITC
535	BEDROOM 2	3'-6"	8'-8"	0'-0"	G	ALUM. CLAD WOOD	DOUBLE	MIN. 23 OITC
601	STAIR 1	3'-6"	4'-0"	3'-0"	9	STEEL	SINGLE	90 MIN. RATED, MIN. 23 OITC



WINDOW TYPES

NOTES:
1. WINDOWS WITH SILL LESS THAN 3'-0" A.F.F. MUST HAVE 4" MAX. RESTRICTOR.



Simulated Divided Lite with Spacer Bar (SDLS)



Simulated Divided Lite (SDL)


Simulated Divided Lite

- **Simulated Divided Lite with Spacer Bar (SDLS)** - an energy-efficient way to create the look of divided lites. SDLS bars are permanently adhered to both sides of the glass. A spacer bar is installed between the glass, creating the essence of Authentic Divided Lites.
- **Simulated Divided Lite (SDL)** - SDL bars are permanently adhered to both sides of the glass.


7 EXTERIOR SIMULATED DIVIDED LITE WITH SPACER BAR WINDOW
1 1/2" = 1'-0"

NATURAL LIGHT CALCULATIONS- 06.30.20					
FLOOR	UNIT#	ROOM NAME	FLOOR AREA	8% NATURAL LIGHT REQUIRED (SQ.FT.)	NATURAL LIGHT PROVIDED (SQ.FT.)
1st FLOOR:	101	LIVE/DINE	269	21.5	50
2nd FLOOR:	201	LIVE/DINE	321	25.7	81
		BEDROOM 1	108	8.6	39
	202	LIVE/DINE	253	20.2	49
		BEDROOM 1	127	10.2	70
	203	LIVE/DINE	309	24.7	93
		BEDROOM 1	111	8.9	30
		BEDROOM 2	109	8.7	25
	204	LIVE/DINE	275	22.0	93
		BEDROOM 1	100	8.0	30
		BEDROOM 2	104	8.3	28
3rd FLOOR:	301	LIVE/DINE	321	25.7	81
		BEDROOM 1	108	8.6	39
	302	LIVE/DINE	253	20.2	49
		BEDROOM 1	130	10.4	70
	303	LIVE/DINE	309	24.7	93
		BEDROOM 1	111	8.9	30
		BEDROOM 2	109	8.7	25
	304	LIVE/DINE	275	22.0	93
		BEDROOM 1	100	8.0	30
		BEDROOM 2	104	8.3	28
4th FLOOR:	401	LIVE/DINE	321	25.7	81
		BEDROOM 1	108	8.6	39
	402	LIVE/DINE	253	20.2	49
		BEDROOM 1	130	10.4	70
	403	LIVE/DINE	260	20.8	98
		BEDROOM 1	100	8.0	76
		BEDROOM 2	148	11.8	106
5th FLOOR:	501	LIVE/DINE	321	25.7	81
		BEDROOM 1	108	8.6	39
	502	LIVE/DINE	253	20.2	49
		BEDROOM 1	110	8.8	56
	503	LIVE/DINE	260	20.8	98
		BEDROOM 1	100	8.0	76
		BEDROOM 2	148	11.8	106


NOTE:
ALL HABITABLE ROOMS TO HAVE MECH. VENTILATION

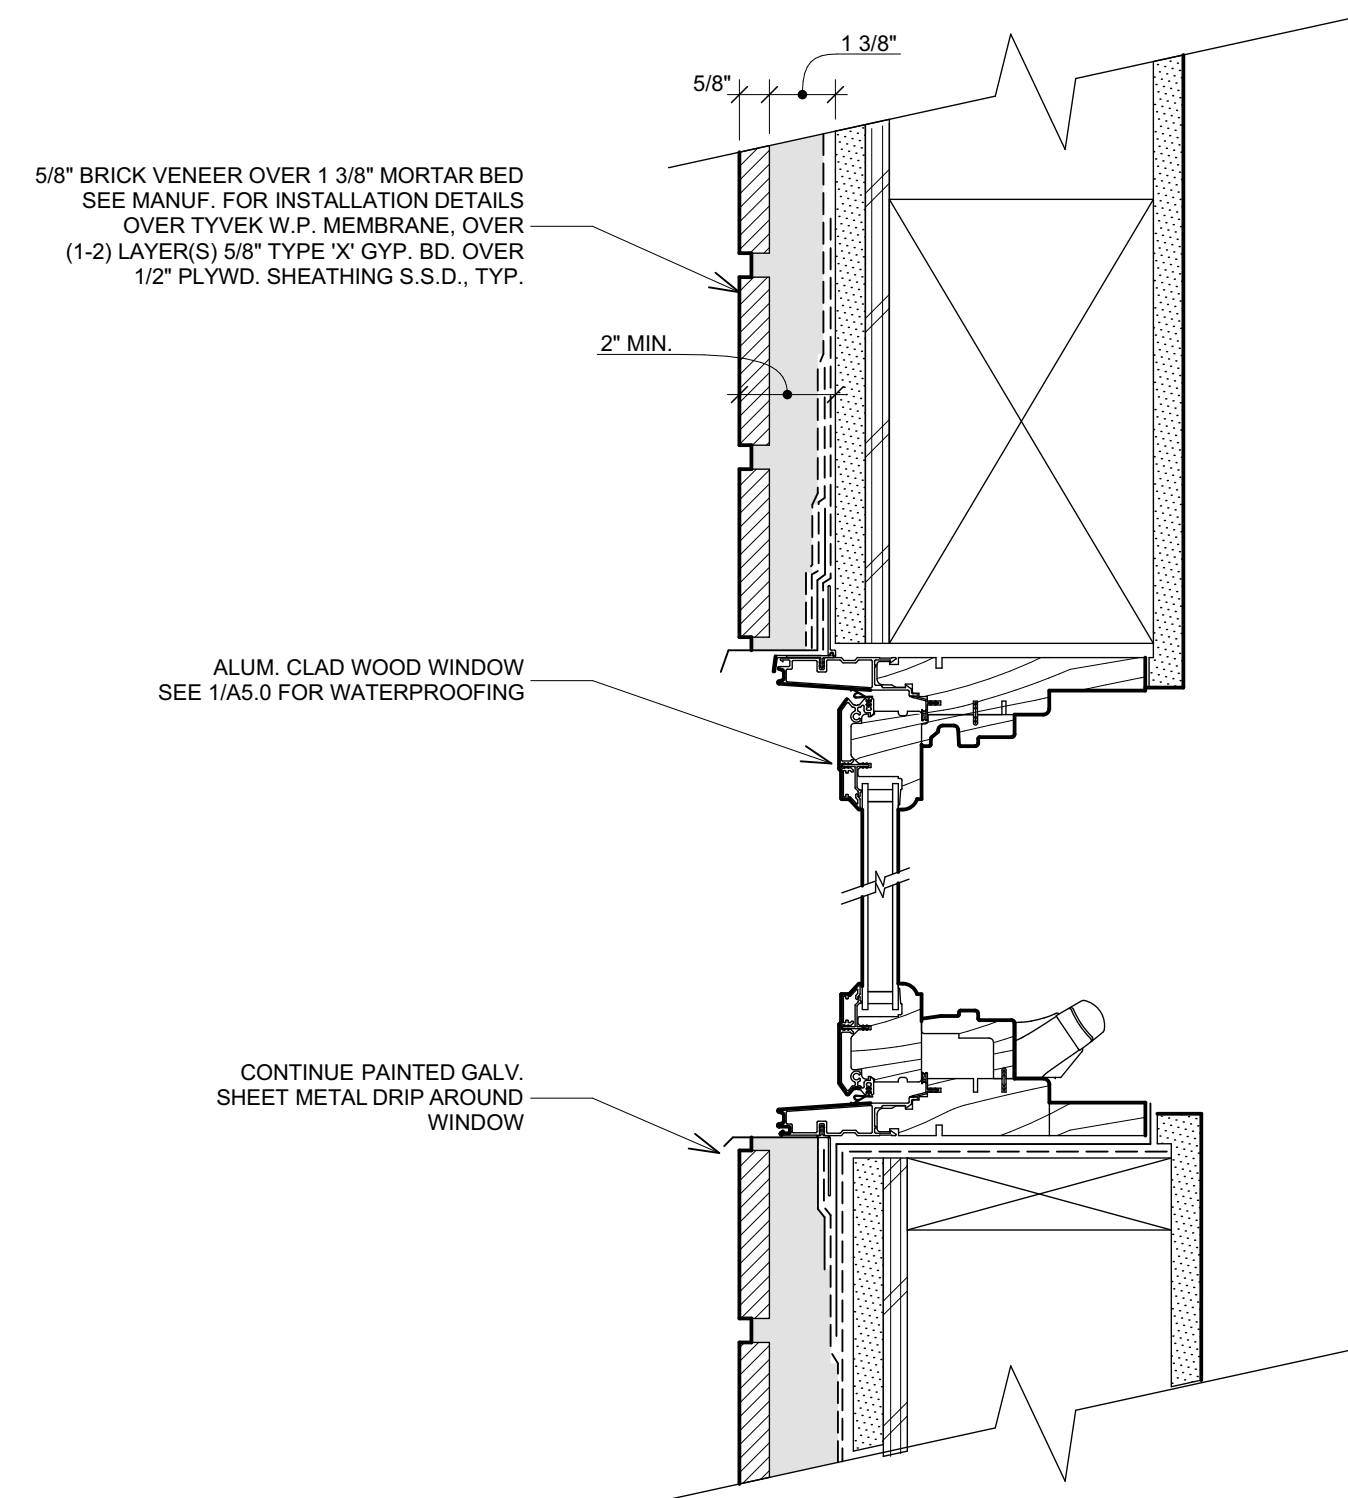

5 Head and Sill W/ Brick Veneer 2" Recess
SCALE: 3" = 1'-0"

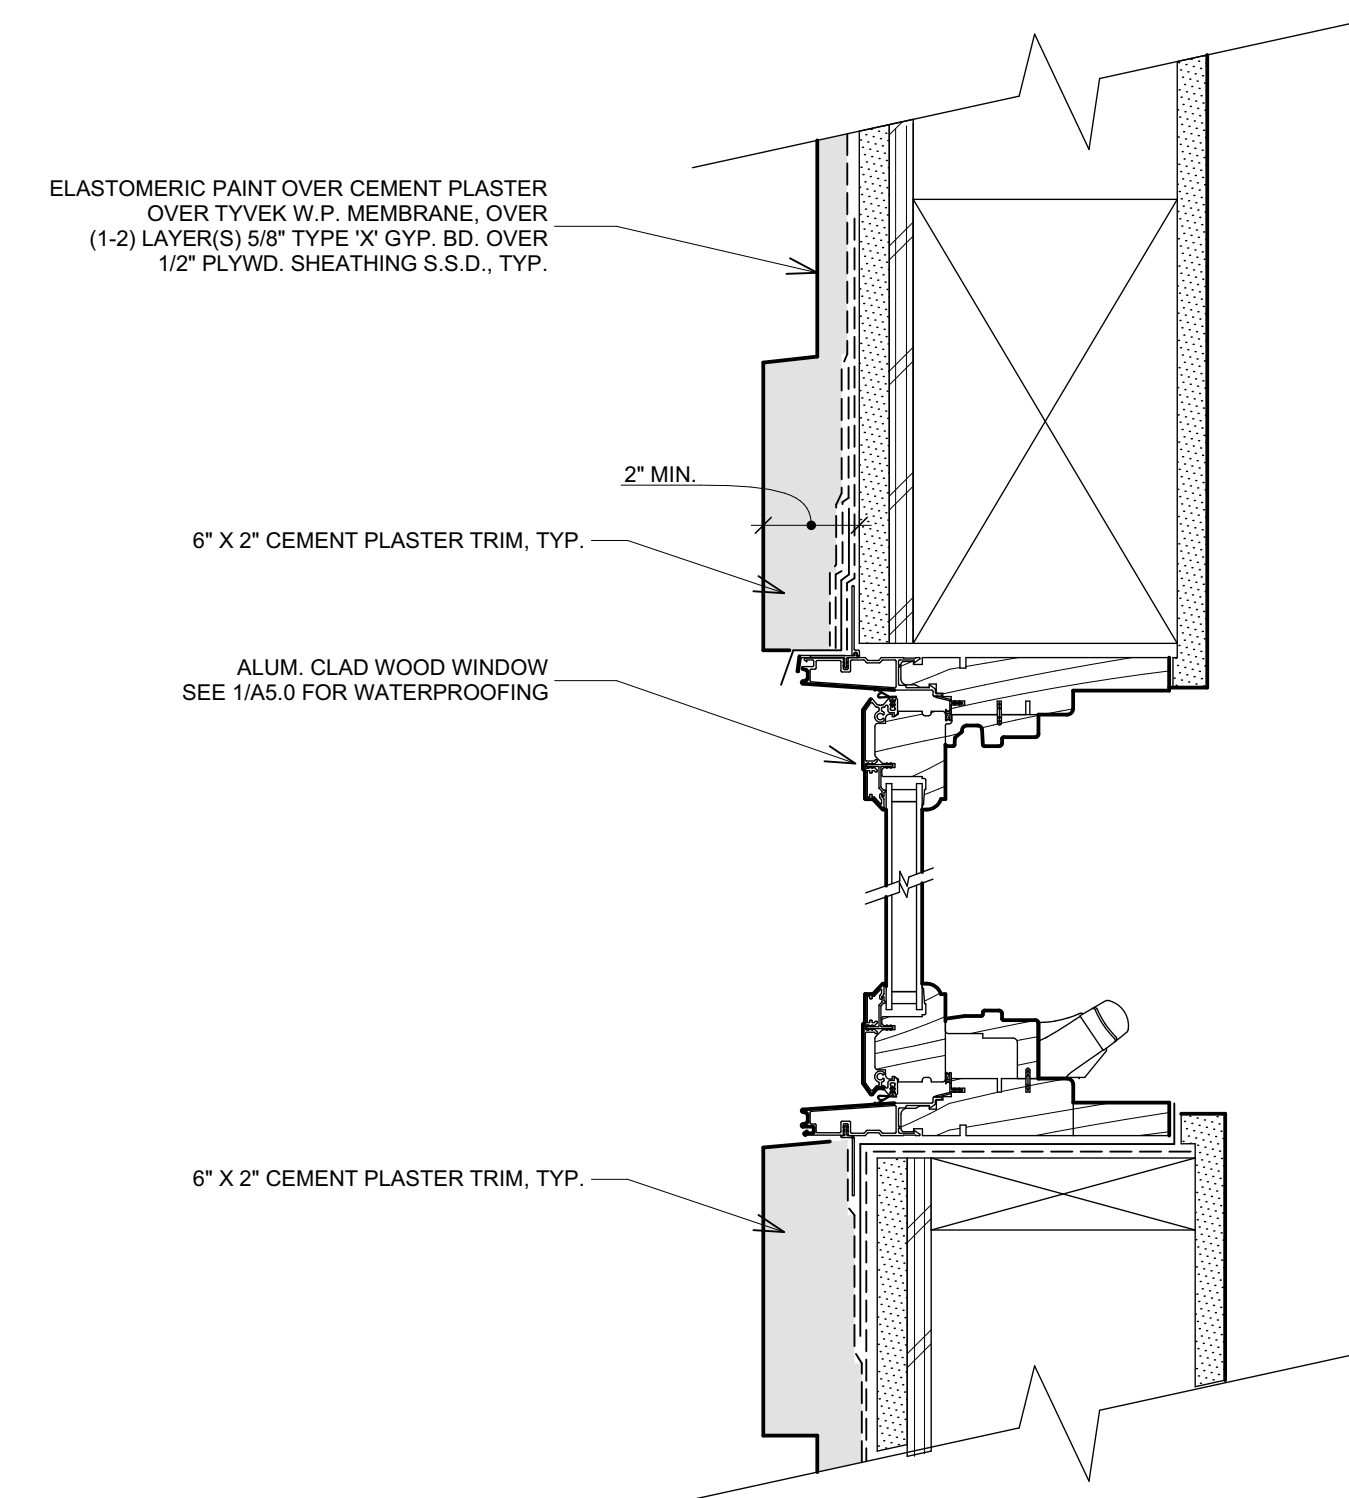

4 Head and Sill W/ Cement Plaster 2" Recess
SCALE: 3" = 1'-0"

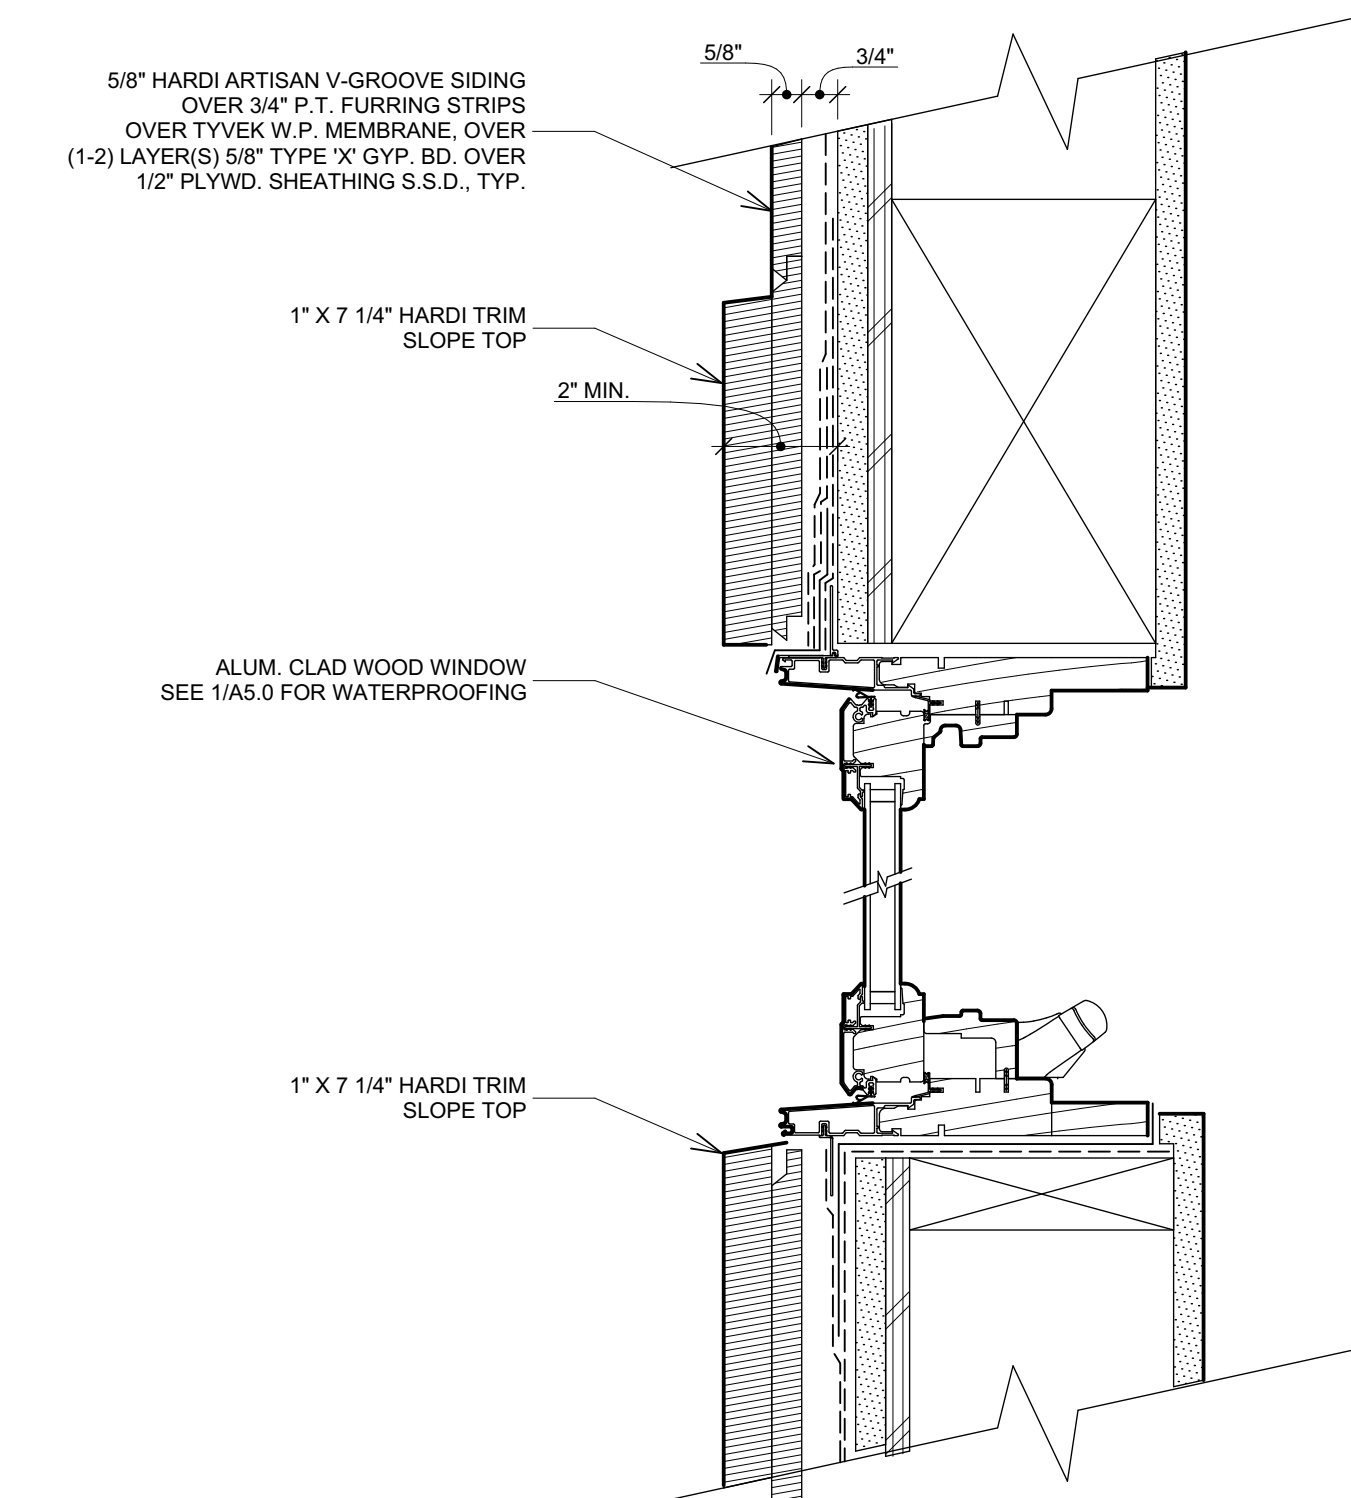










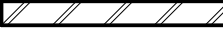


3 Head and Sill W/ Hardi Siding 2" Recess
SCALE: 3" = 1'-0"

FOR DBI USE

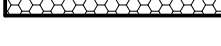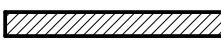


Revisions	By
PROGRESS SET 01.15.20	BM
DBI RESPONSE 03.25.20	BM
FIRE RESPONSE 04.07.20	BM
PLANNING REVISIONS 05.06.20	BM
DBI-PLNG RESPONSE 06.30.20	BM

WALL SCHEDULE

-  **NEW MASONRY WALL:**
S.S.D. FOR WIDTH & REINFORCING
-  **NEW CONCRETE WALL:**
S.S.D. FOR WIDTH & REINFORCING
-  **NEW ONE-HOUR RATED EXTERIOR WALL:** SEE A/A5.4
-  **NEW TWO-HOUR RATED EXTERIOR WALL:** SEE B/A5.4
-  **NEW ONE-HOUR RATED INTERIOR WALL:** SEE E/A5.4
-  **NEW ONE-HOUR RATED INTERIOR BEARING WALL:** SEE F/A5.4
-  **NEW ONE-HOUR RATED INTERIOR PARTY WALL:** SEE C/A5.4
-  **NEW TWO-HOUR RATED INTERIOR WALL:** SEE G/A5.4
-  **NEW NON-RATED INTERIOR WALL:** SEE H/A5.5
-  **NEW LOW HEIGHT INTERIOR WALL:**
-  **NEW 2-HOUR RATED SHAFT WALL:** SEE D/A5.4
-  **NEW 2-HOUR EXTERIOR WALL:** SEE N/A5.5

SEE A5.0 & A5.1 FOR CBC 11A REQUIREMENTS

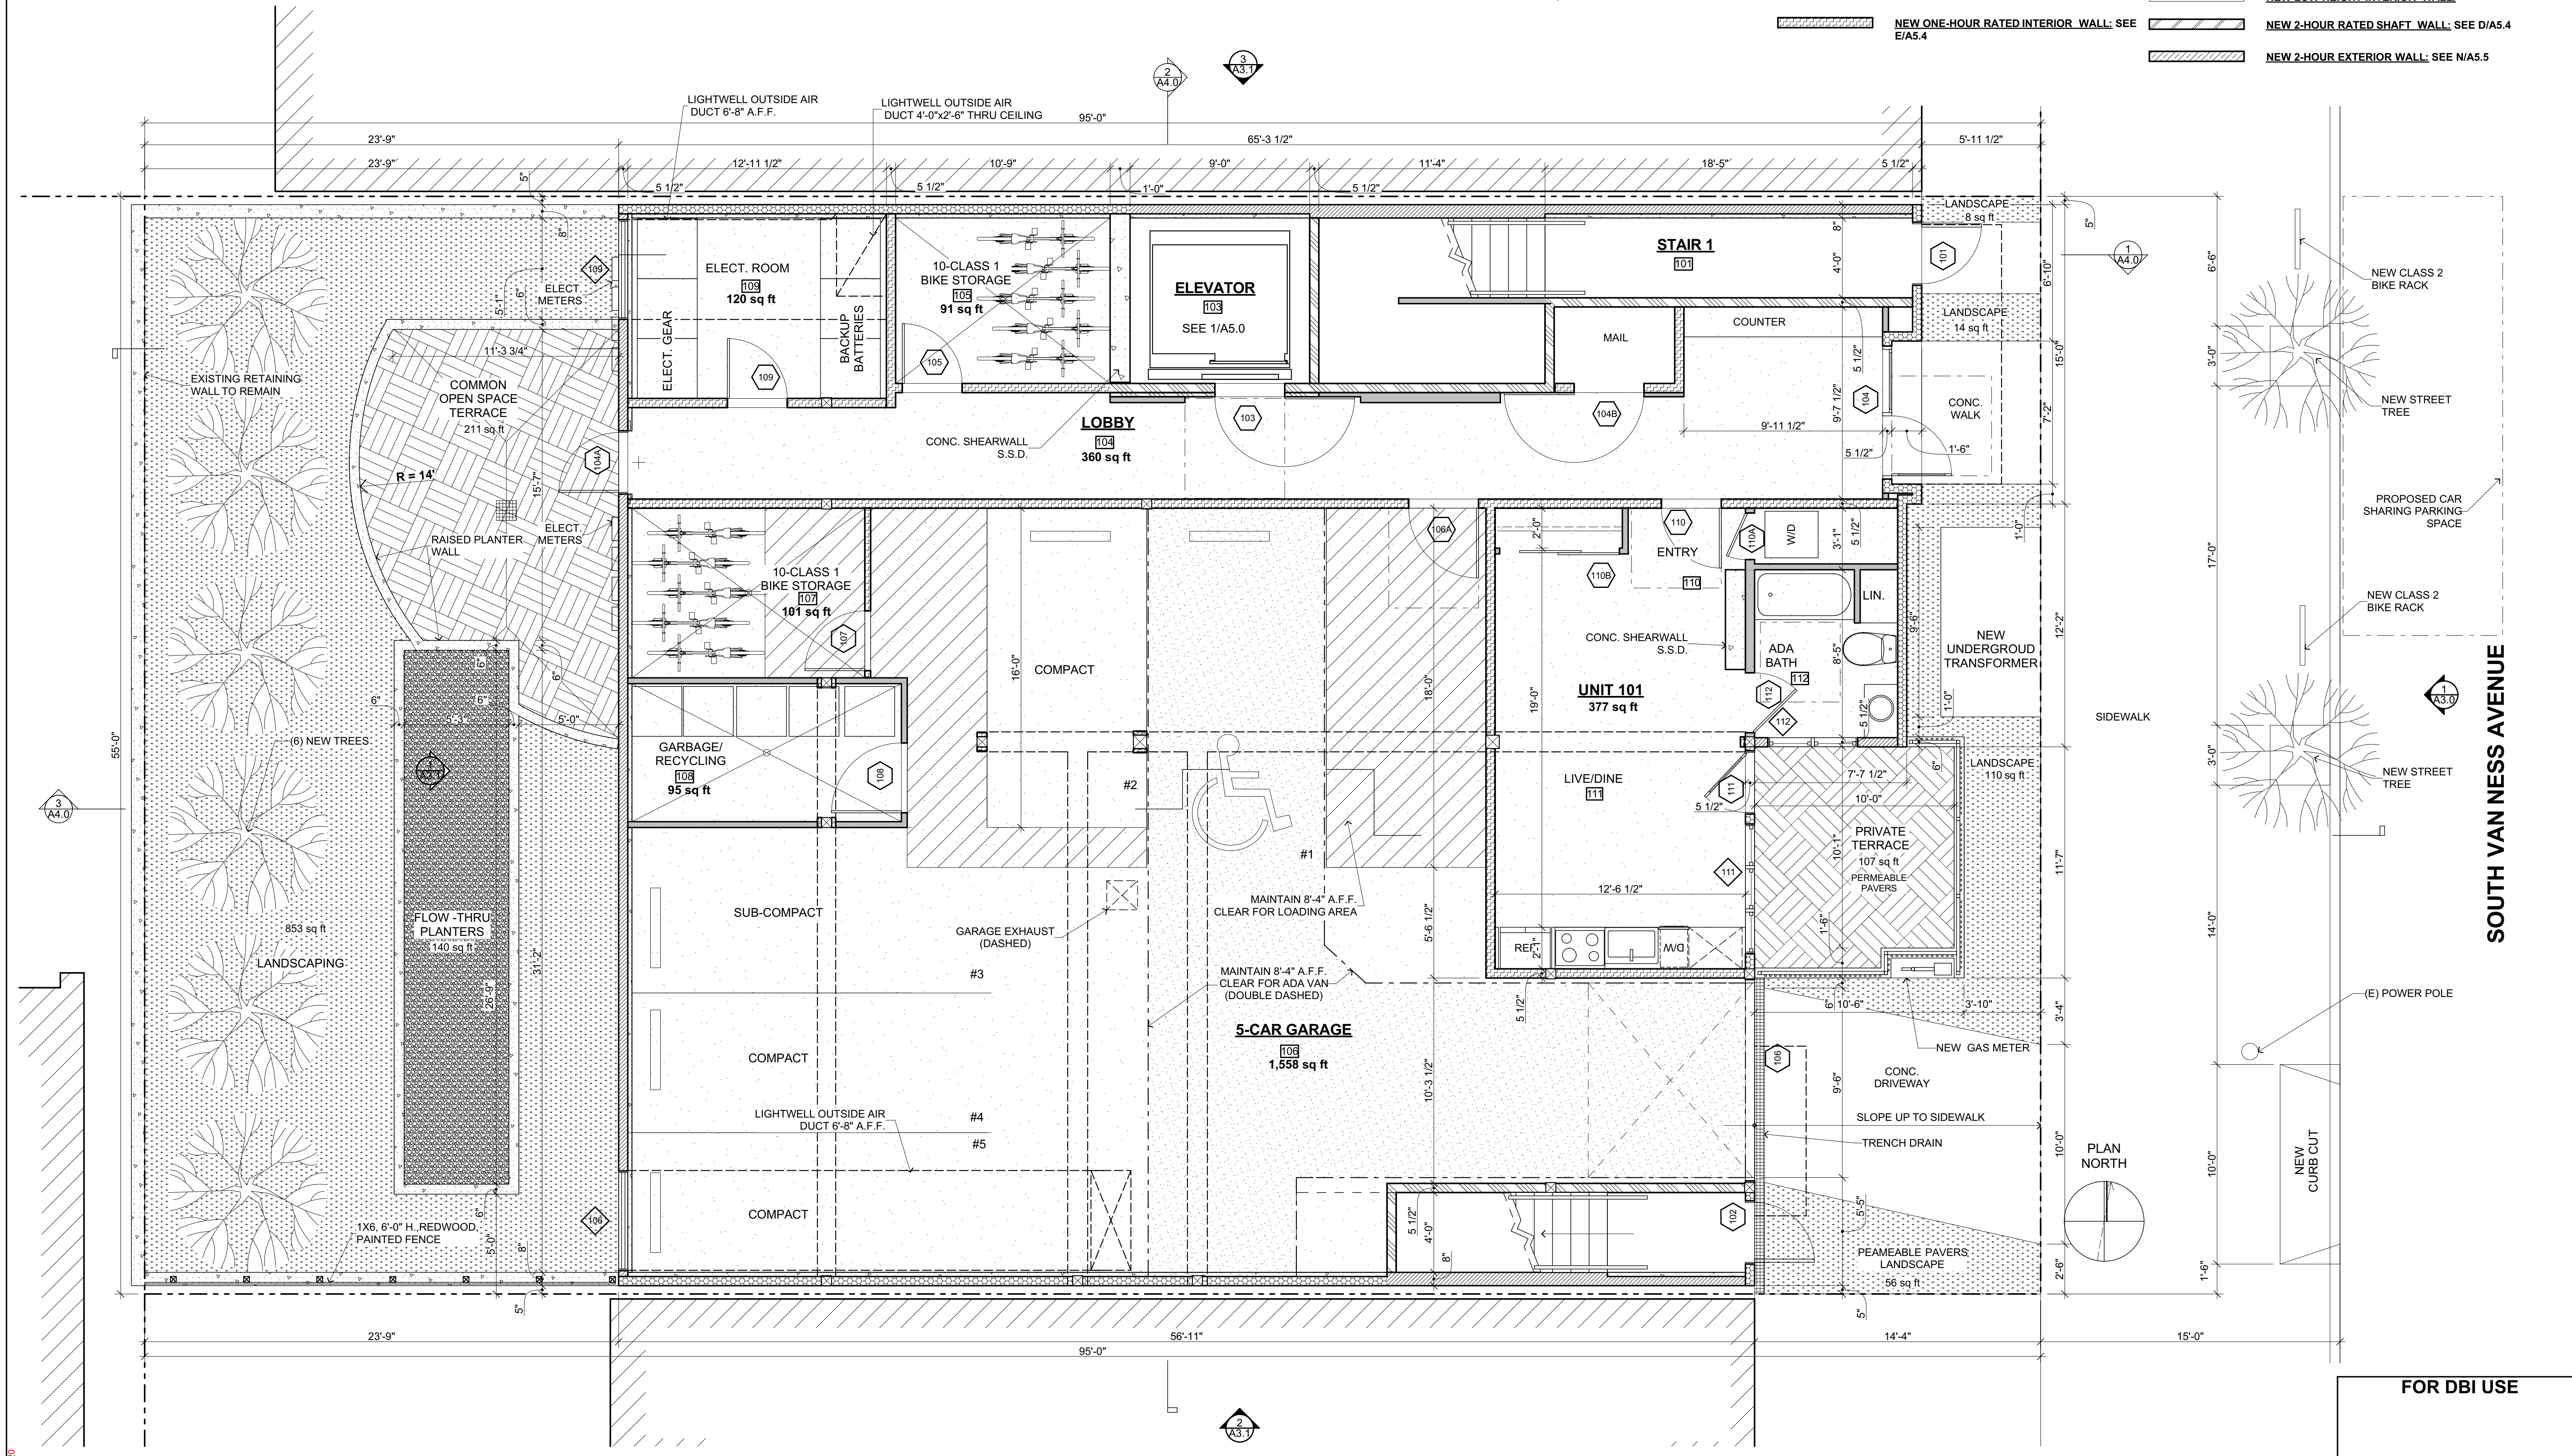

**Kotas/
Pantaleoni
Architects**
Anthony A. Pantaleoni
LEED AP
710 Zee Street Suite 200
San Francisco, California 94107
t 415 496 4051
design@kpa-architects.com



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**15 RESIDENTIAL UNITS
986 SOUTH VAN NESS AVENUE
SAN FRANCISCO, CA 94110**

Sheet Title:
**Floor Plans:
PROPOSED 1ST
FLOOR**




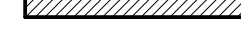








Date: 11.19
Drawn By: BM
Job Number: 2-1119

A2.1


1 PROPOSED 1ST FLOOR
SCALE: 1/4" = 1'-0"

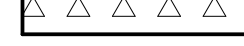FOR DBI USE

WALL SCHEDULE

-  **NEW MASONRY WALL:**
S.S.D. FOR WIDTH & REINFORCING
-  **NEW CONCRETE WALL:**
S.S.D. FOR WIDTH & REINFORCING
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-  **NEW TWO-HOUR RATED EXTERIOR WALL:** SEE B/A5.4
-  **NEW ONE-HOUR RATED INTERIOR WALL:** SEE E/A5.4
-  **NEW ONE-HOUR RATED INTERIOR BEARING WALL:** SEE F/A5.4
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-  **NEW NON-RATED INTERIOR WALL:** SEE H/A5.5
-  **NEW LOW HEIGHT INTERIOR WALL:**
-  **NEW 2-HOUR RATED SHAFT WALL:** SEE D/A5.4
-  **NEW 2-HOUR EXTERIOR WALL:** SEE I/A5.5

SEE A5.0 & A5.1 FOR CBC 11A REQUIREMENTS

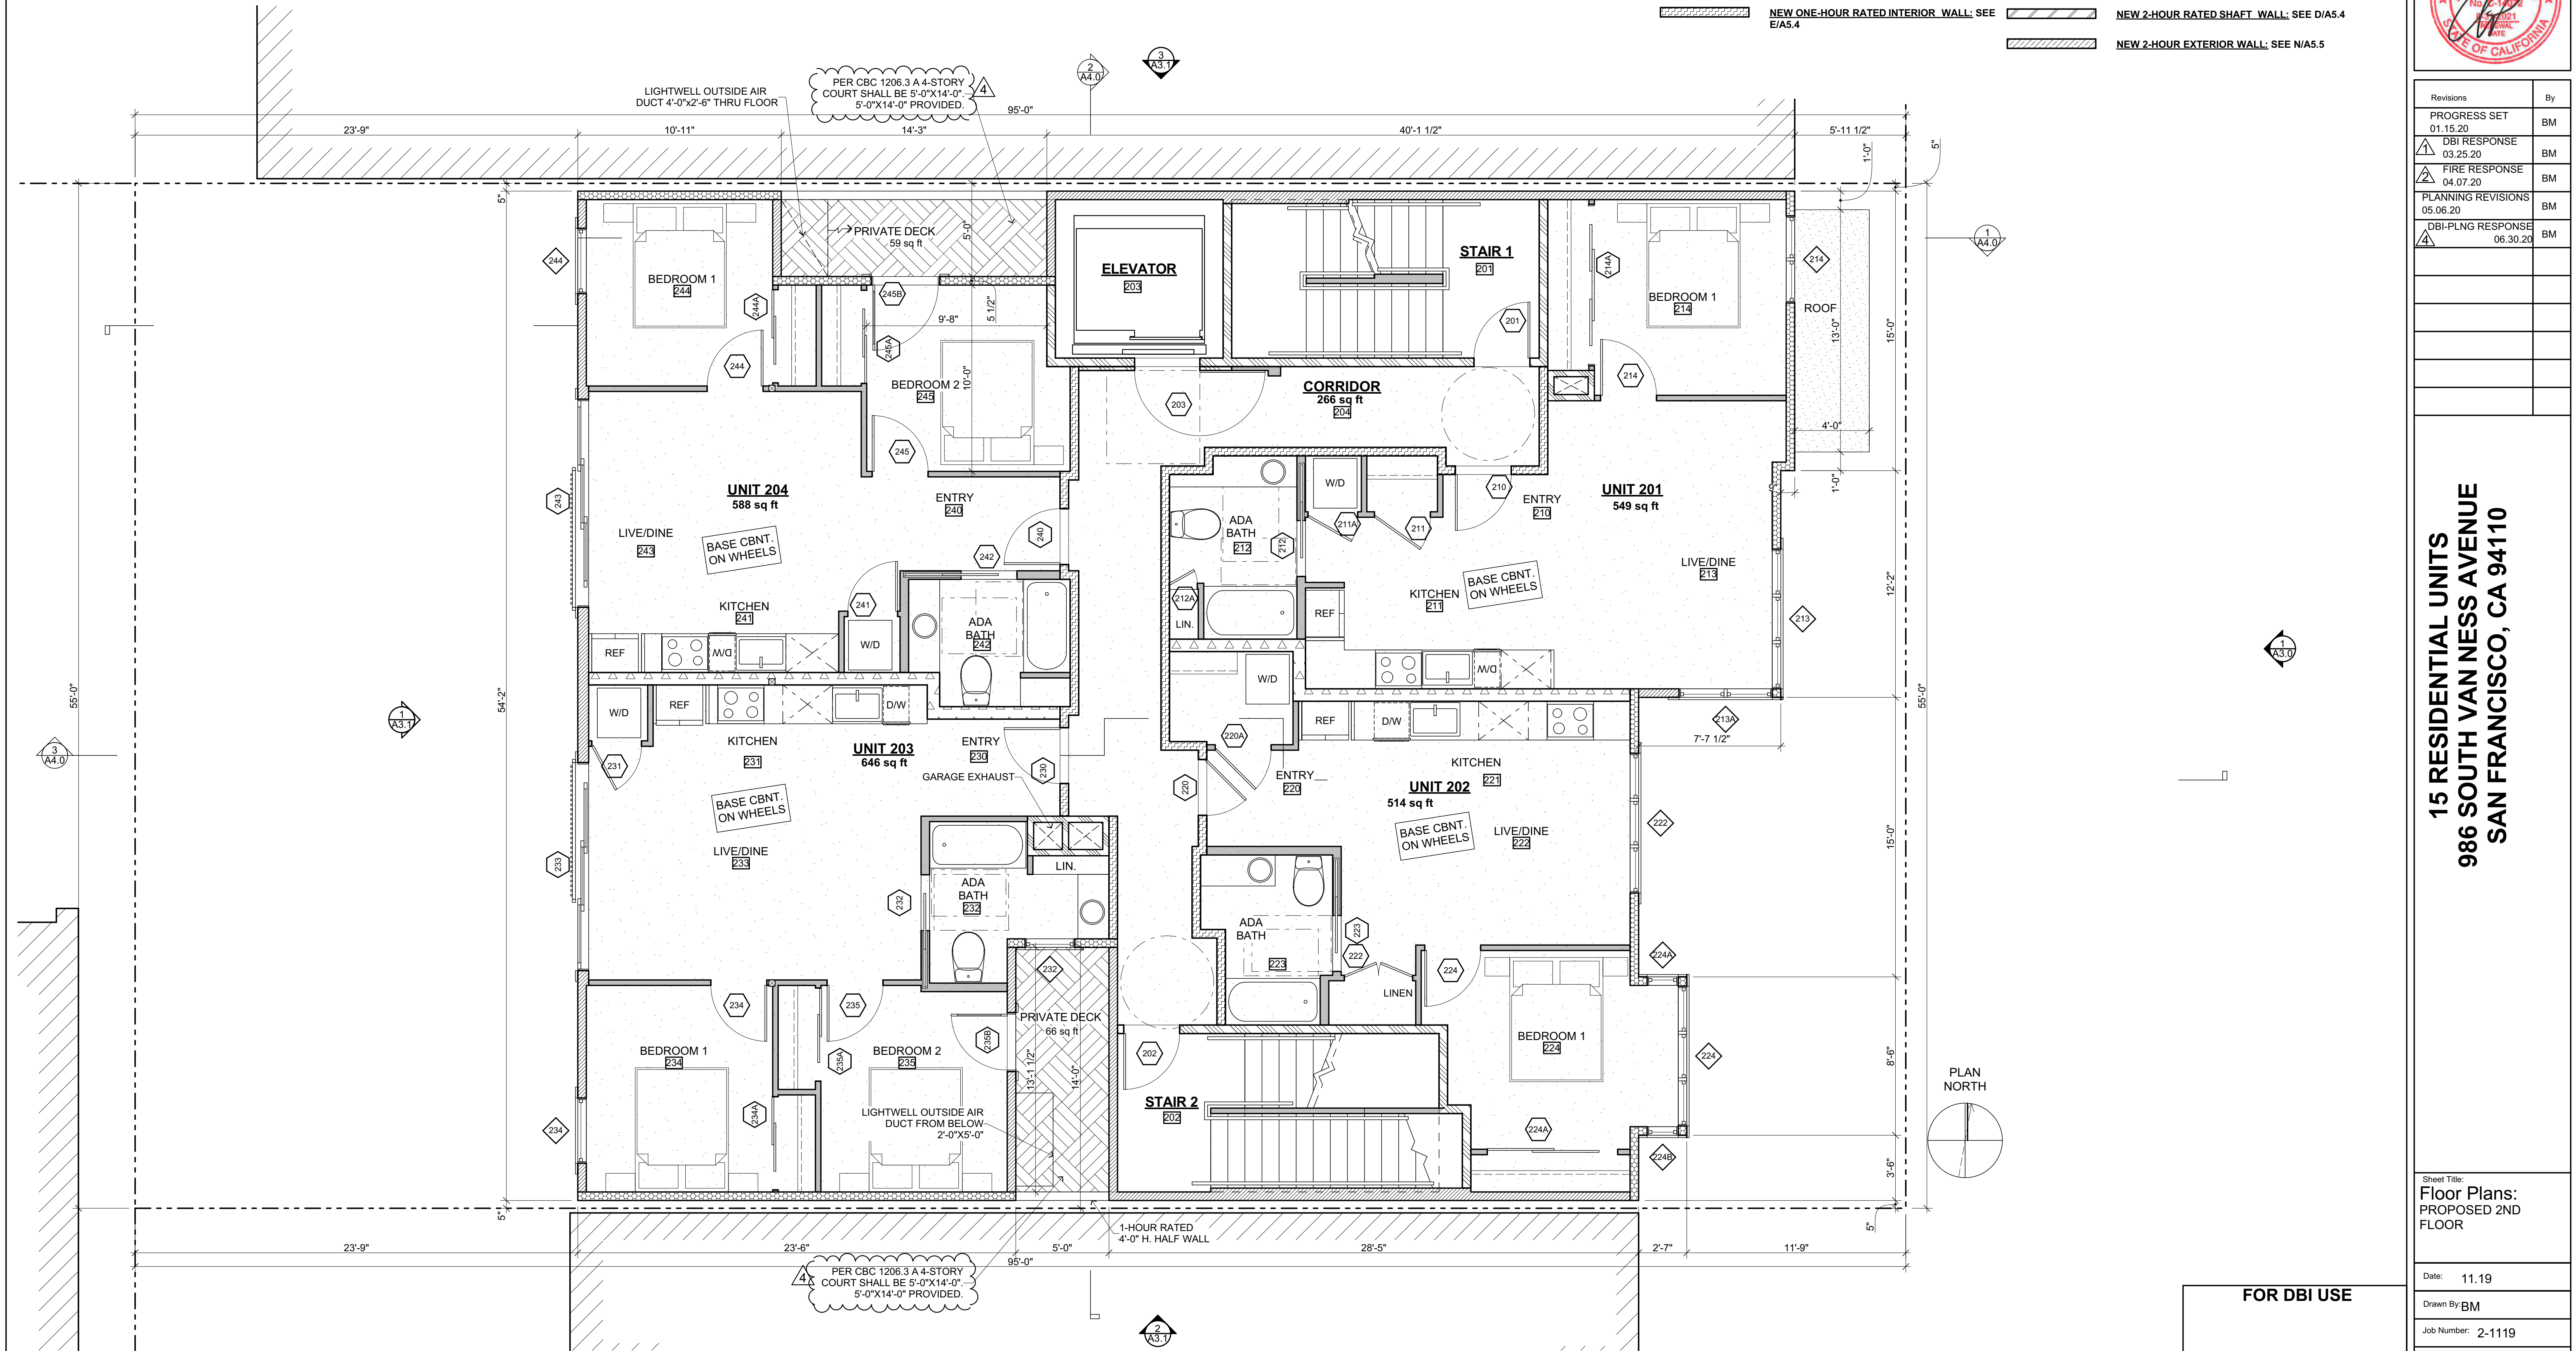

1 PROPOSED 2ND FLOOR
SCALE: 1/4" = 1'-0"

FOR DBI USE

**Kotas/
Pantaleoni
Architects**
Anthony A. Pantaleoni
LEED AP
710 Zee Street Suite 200
San Francisco, California 94107
t 415 496 4051
design@kpa-architects.com



Revisions	By
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


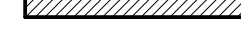








**15 RESIDENTIAL UNITS
986 SOUTH VAN NESS AVENUE
SAN FRANCISCO, CA 94110**

Sheet Title:
**Floor Plans:
PROPOSED 2ND
FLOOR**



Date: 11.19
Drawn By: BM
Job Number: 2-1119

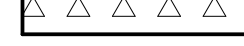A2.2

WALL SCHEDULE

-  **NEW MASONRY WALL:**
S.S.D. FOR WIDTH & REINFORCING
-  **NEW CONCRETE WALL:**
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-  **NEW TWO-HOUR RATED EXTERIOR WALL:** SEE B/A5.4
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-  **NEW 2-HOUR RATED SHAFT WALL:** SEE D/A5.4
-  **NEW 2-HOUR EXTERIOR WALL:** SEE I/A5.5

SEE A5.0 & A5.1 FOR CBC 11A REQUIREMENTS

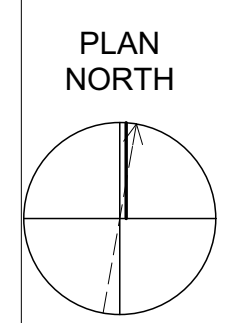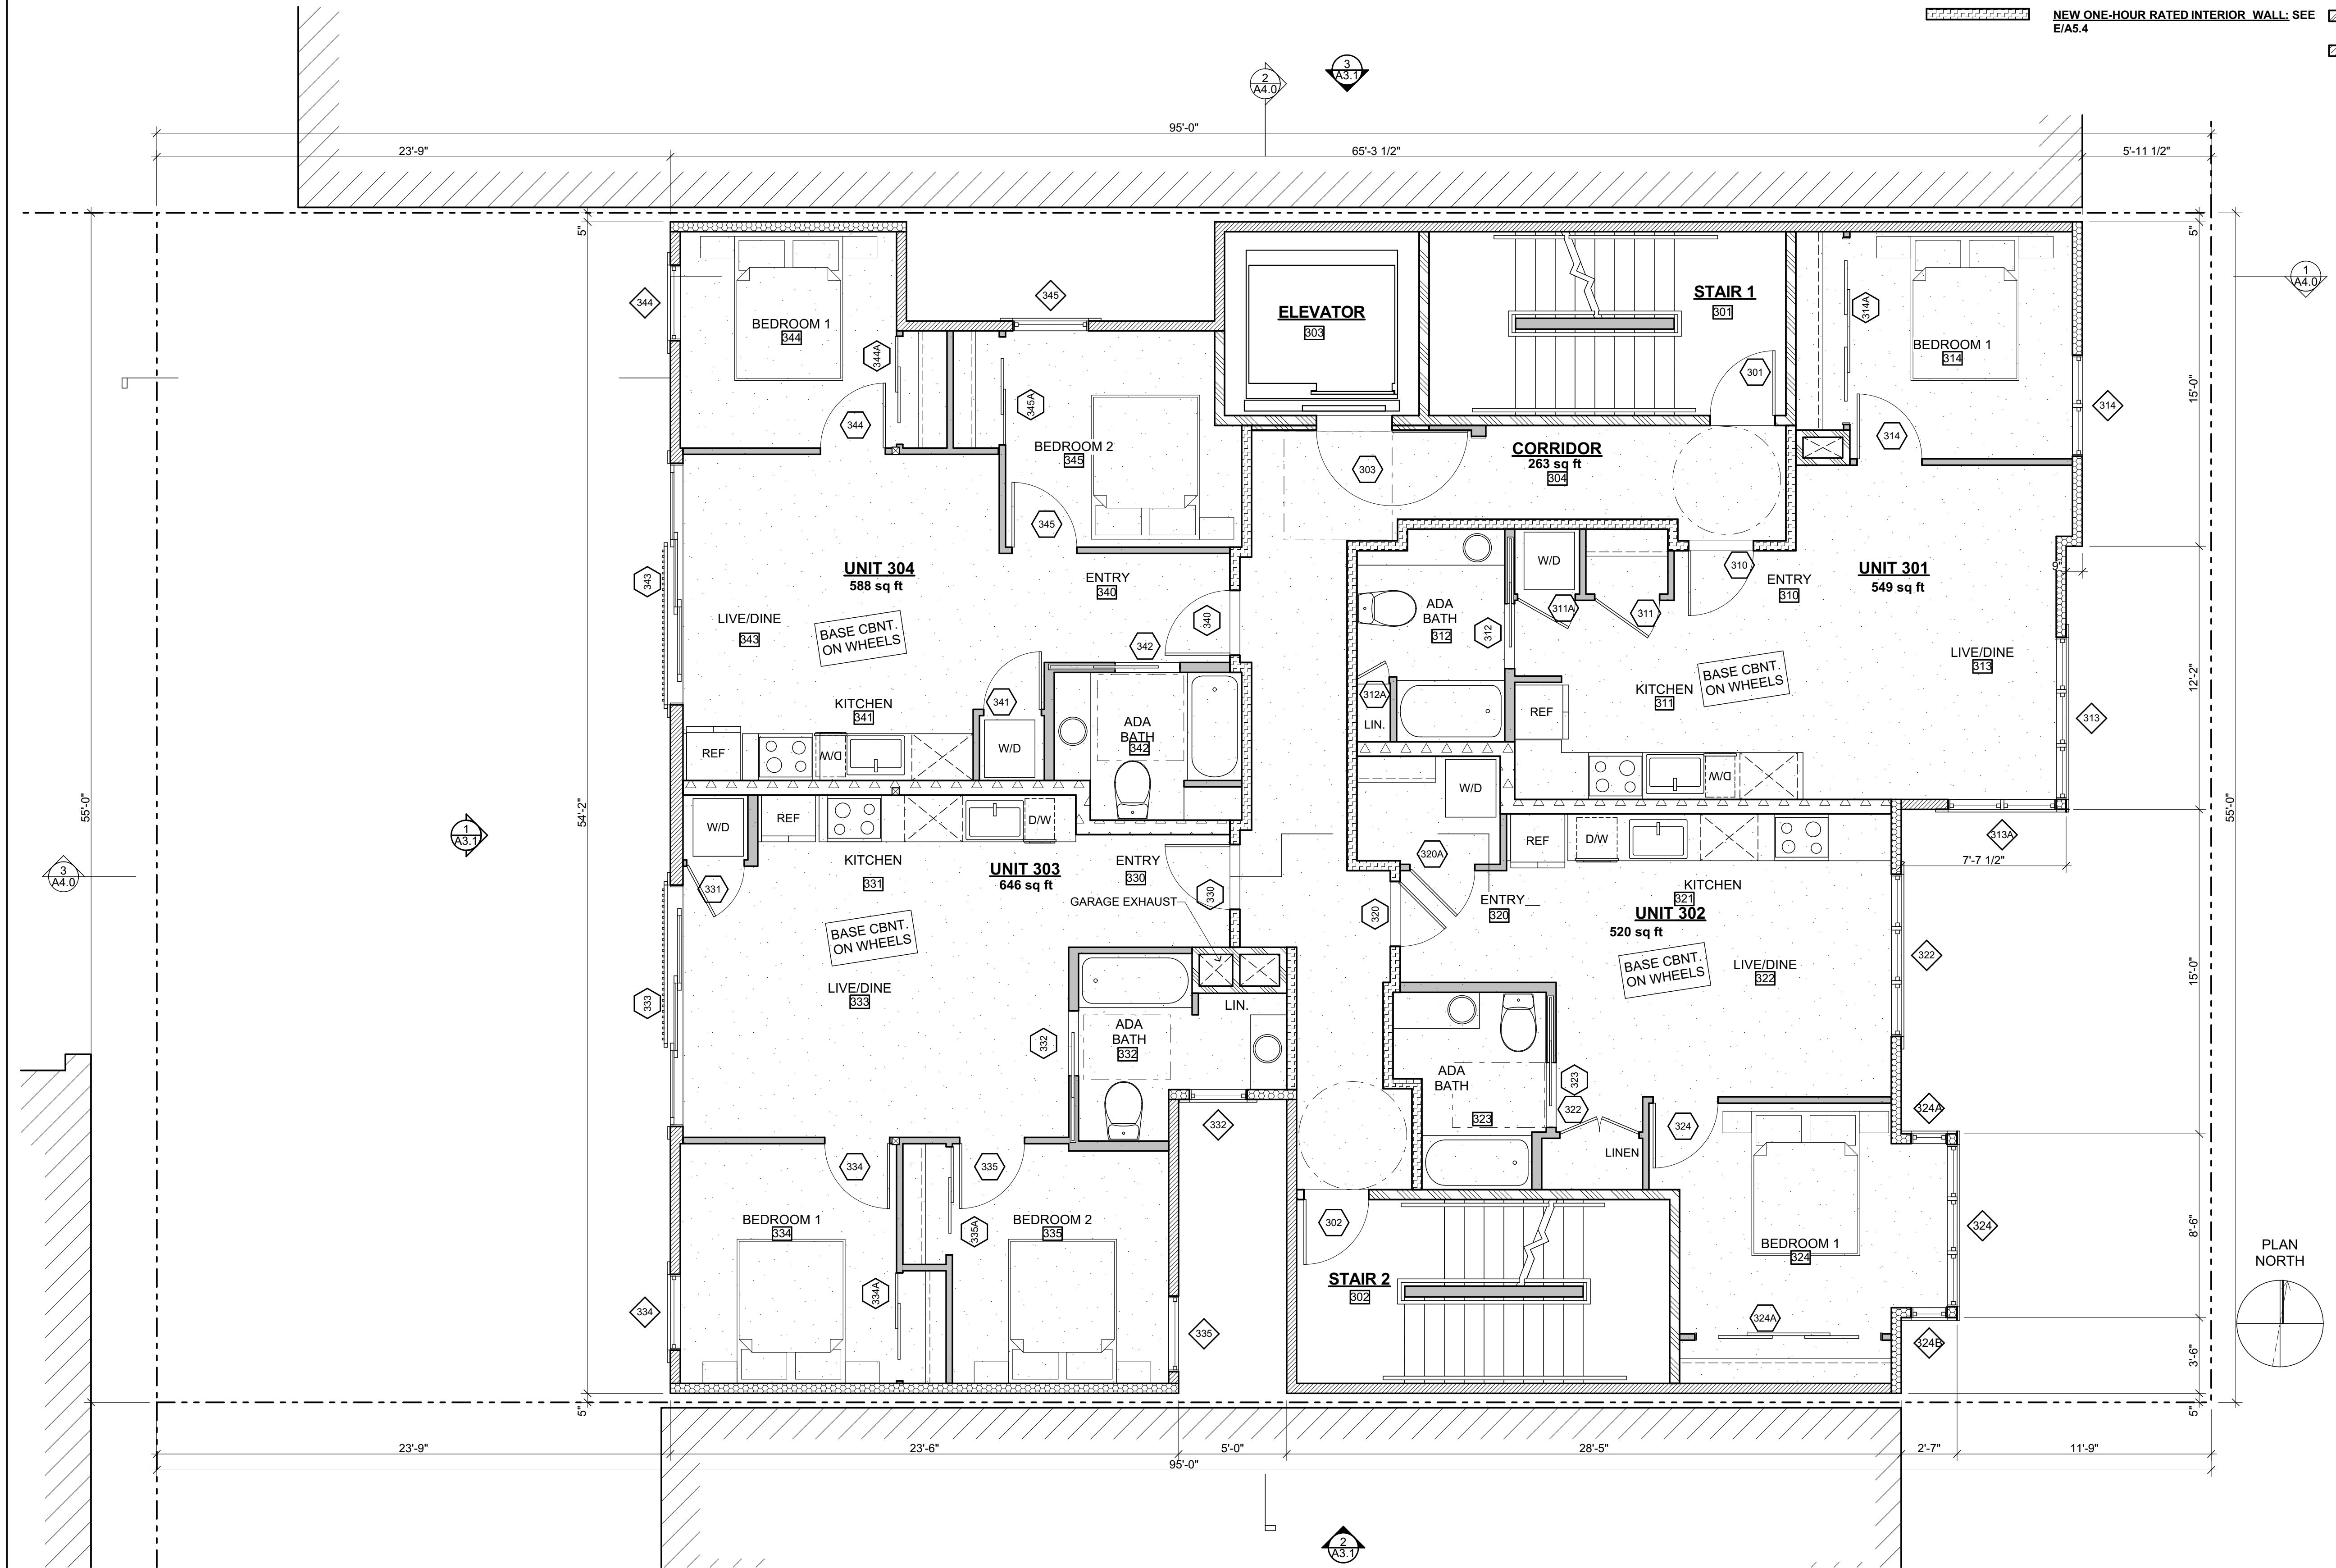

1 PROPOSED 3RD FLOOR
SCALE: 1/4" = 1'-0"

Kotas/
Pantaleoni
Architects
Anthony A. Pantaleoni
LEED AP
717 Zee Street Suite 200
San Francisco, California 94107
t 415 496 4051
design@kpa-architects.com



Revisions	By
PROGRESS SET 01.15.20	BM
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PLANNING REVISIONS 05.06.20	BM
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15 RESIDENTIAL UNITS
986 SOUTH VAN NESS AVENUE
SAN FRANCISCO, CA 94110




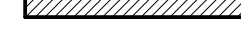








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Floor Plans:
PROPOSED 3RD
FLOOR

Date: 11.19
Drawn By: BM
Job Number: 2-1119



FOR DBI USE

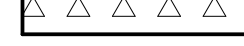A2.3

WALL SCHEDULE

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-  **NEW 2-HOUR EXTERIOR WALL:** SEE N/A5.5

SEE A5.0 & A5.1 FOR CBC 11A REQUIREMENTS

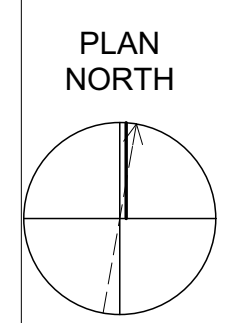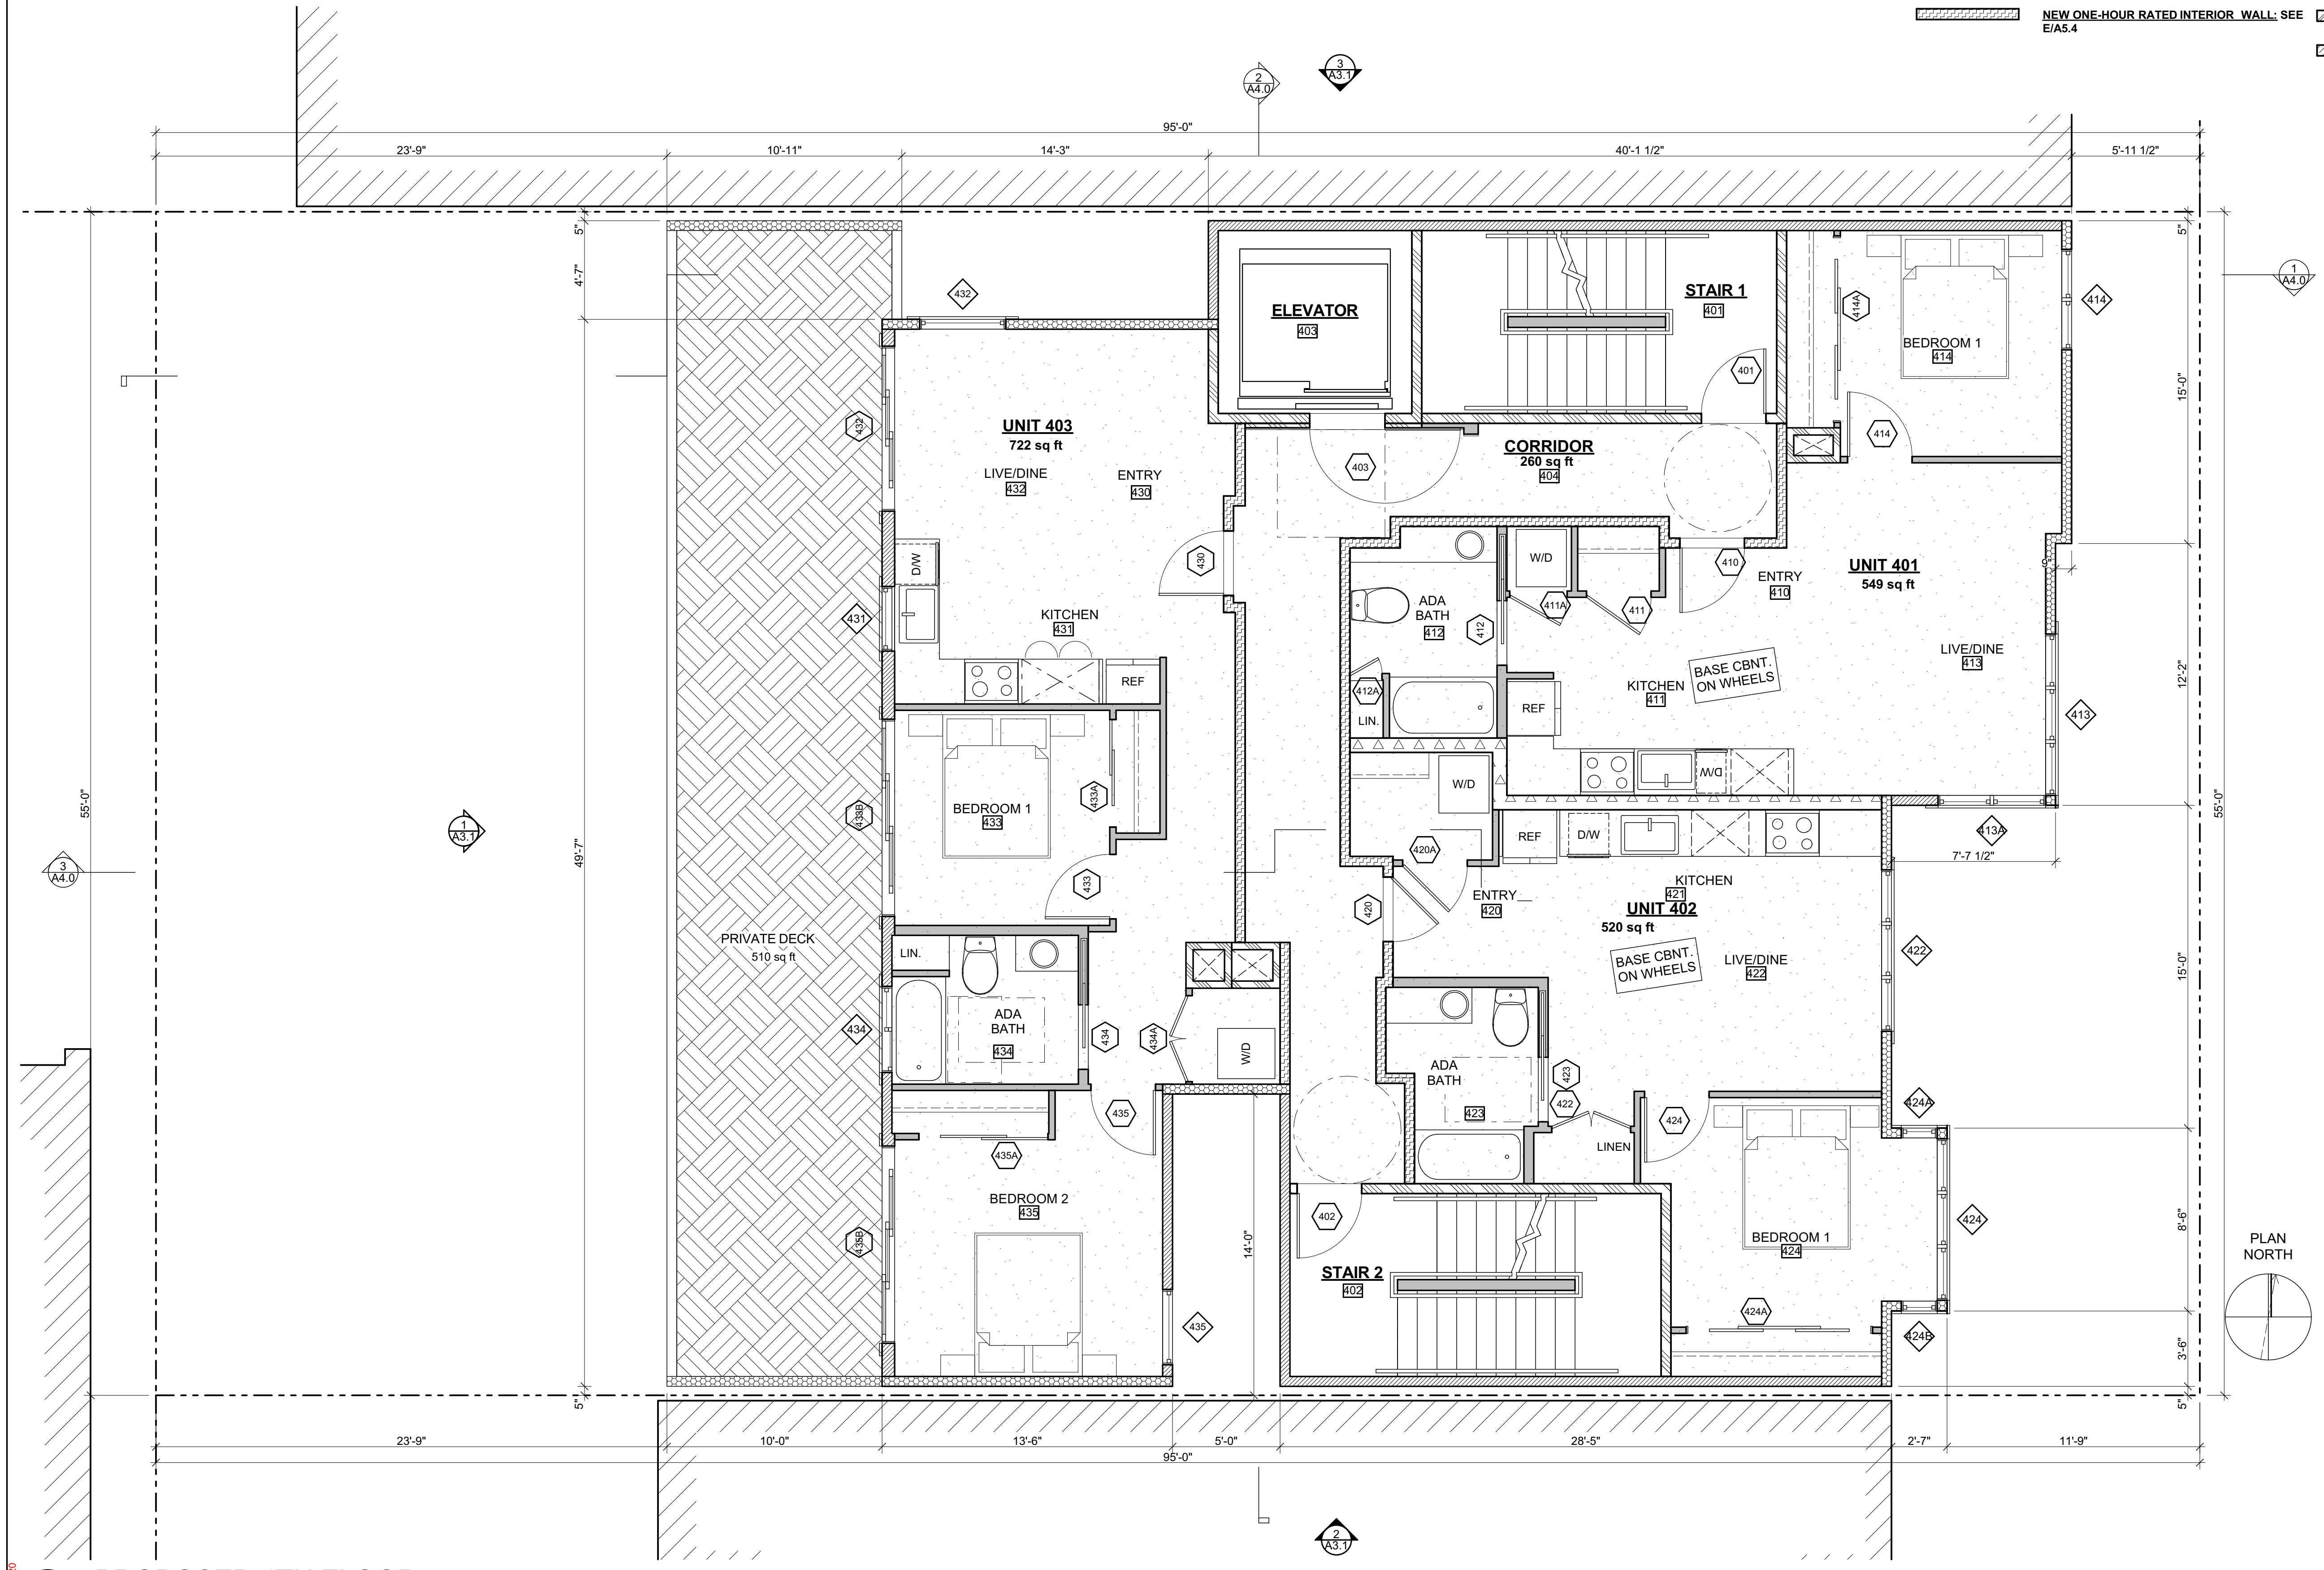

1 PROPOSED 4TH FLOOR
SCALE: 1/4" = 1'-0"

**Kotas/
Pantaleoni
Architects**
Anthony A. Pantaleoni
LEED AP
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San Francisco, California 94107
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design@kpa-architects.com



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


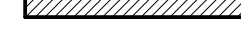








Sheet Title:
**Floor Plans:
PROPOSED 4TH
FLOOR**

Date: 11.19
Drawn By: BM
Job Number: 2-1119


FOR DBI USE

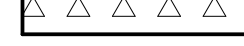A2.4

WALL SCHEDULE

-  **NEW MASONRY WALL:**
S.S.D. FOR WIDTH & REINFORCING
-  **NEW CONCRETE WALL:**
S.S.D. FOR WIDTH & REINFORCING
-  **NEW ONE-HOUR RATED EXTERIOR WALL:** SEE A/A5.4
-  **NEW TWO-HOUR RATED EXTERIOR WALL:** SEE B/A5.4
-  **NEW ONE-HOUR RATED INTERIOR WALL:** SEE E/A5.4
-  **NEW ONE-HOUR RATED INTERIOR BEARING WALL:** SEE F/A5.4
-  **NEW ONE-HOUR RATED INTERIOR PARTY WALL:** SEE C/A5.4
-  **NEW TWO-HOUR RATED INTERIOR WALL:** SEE G/A5.4
-  **NEW NON-RATED INTERIOR WALL:** SEE H/A5.5
-  **NEW LOW HEIGHT INTERIOR WALL:**
-  **NEW TWO-HOUR RATED SHAFT WALL:** SEE D/A5.4
-  **NEW TWO-HOUR EXTERIOR WALL:** SEE N/A5.5

SEE A5.0 & A5.1 FOR CBC 11A REQUIREMENTS

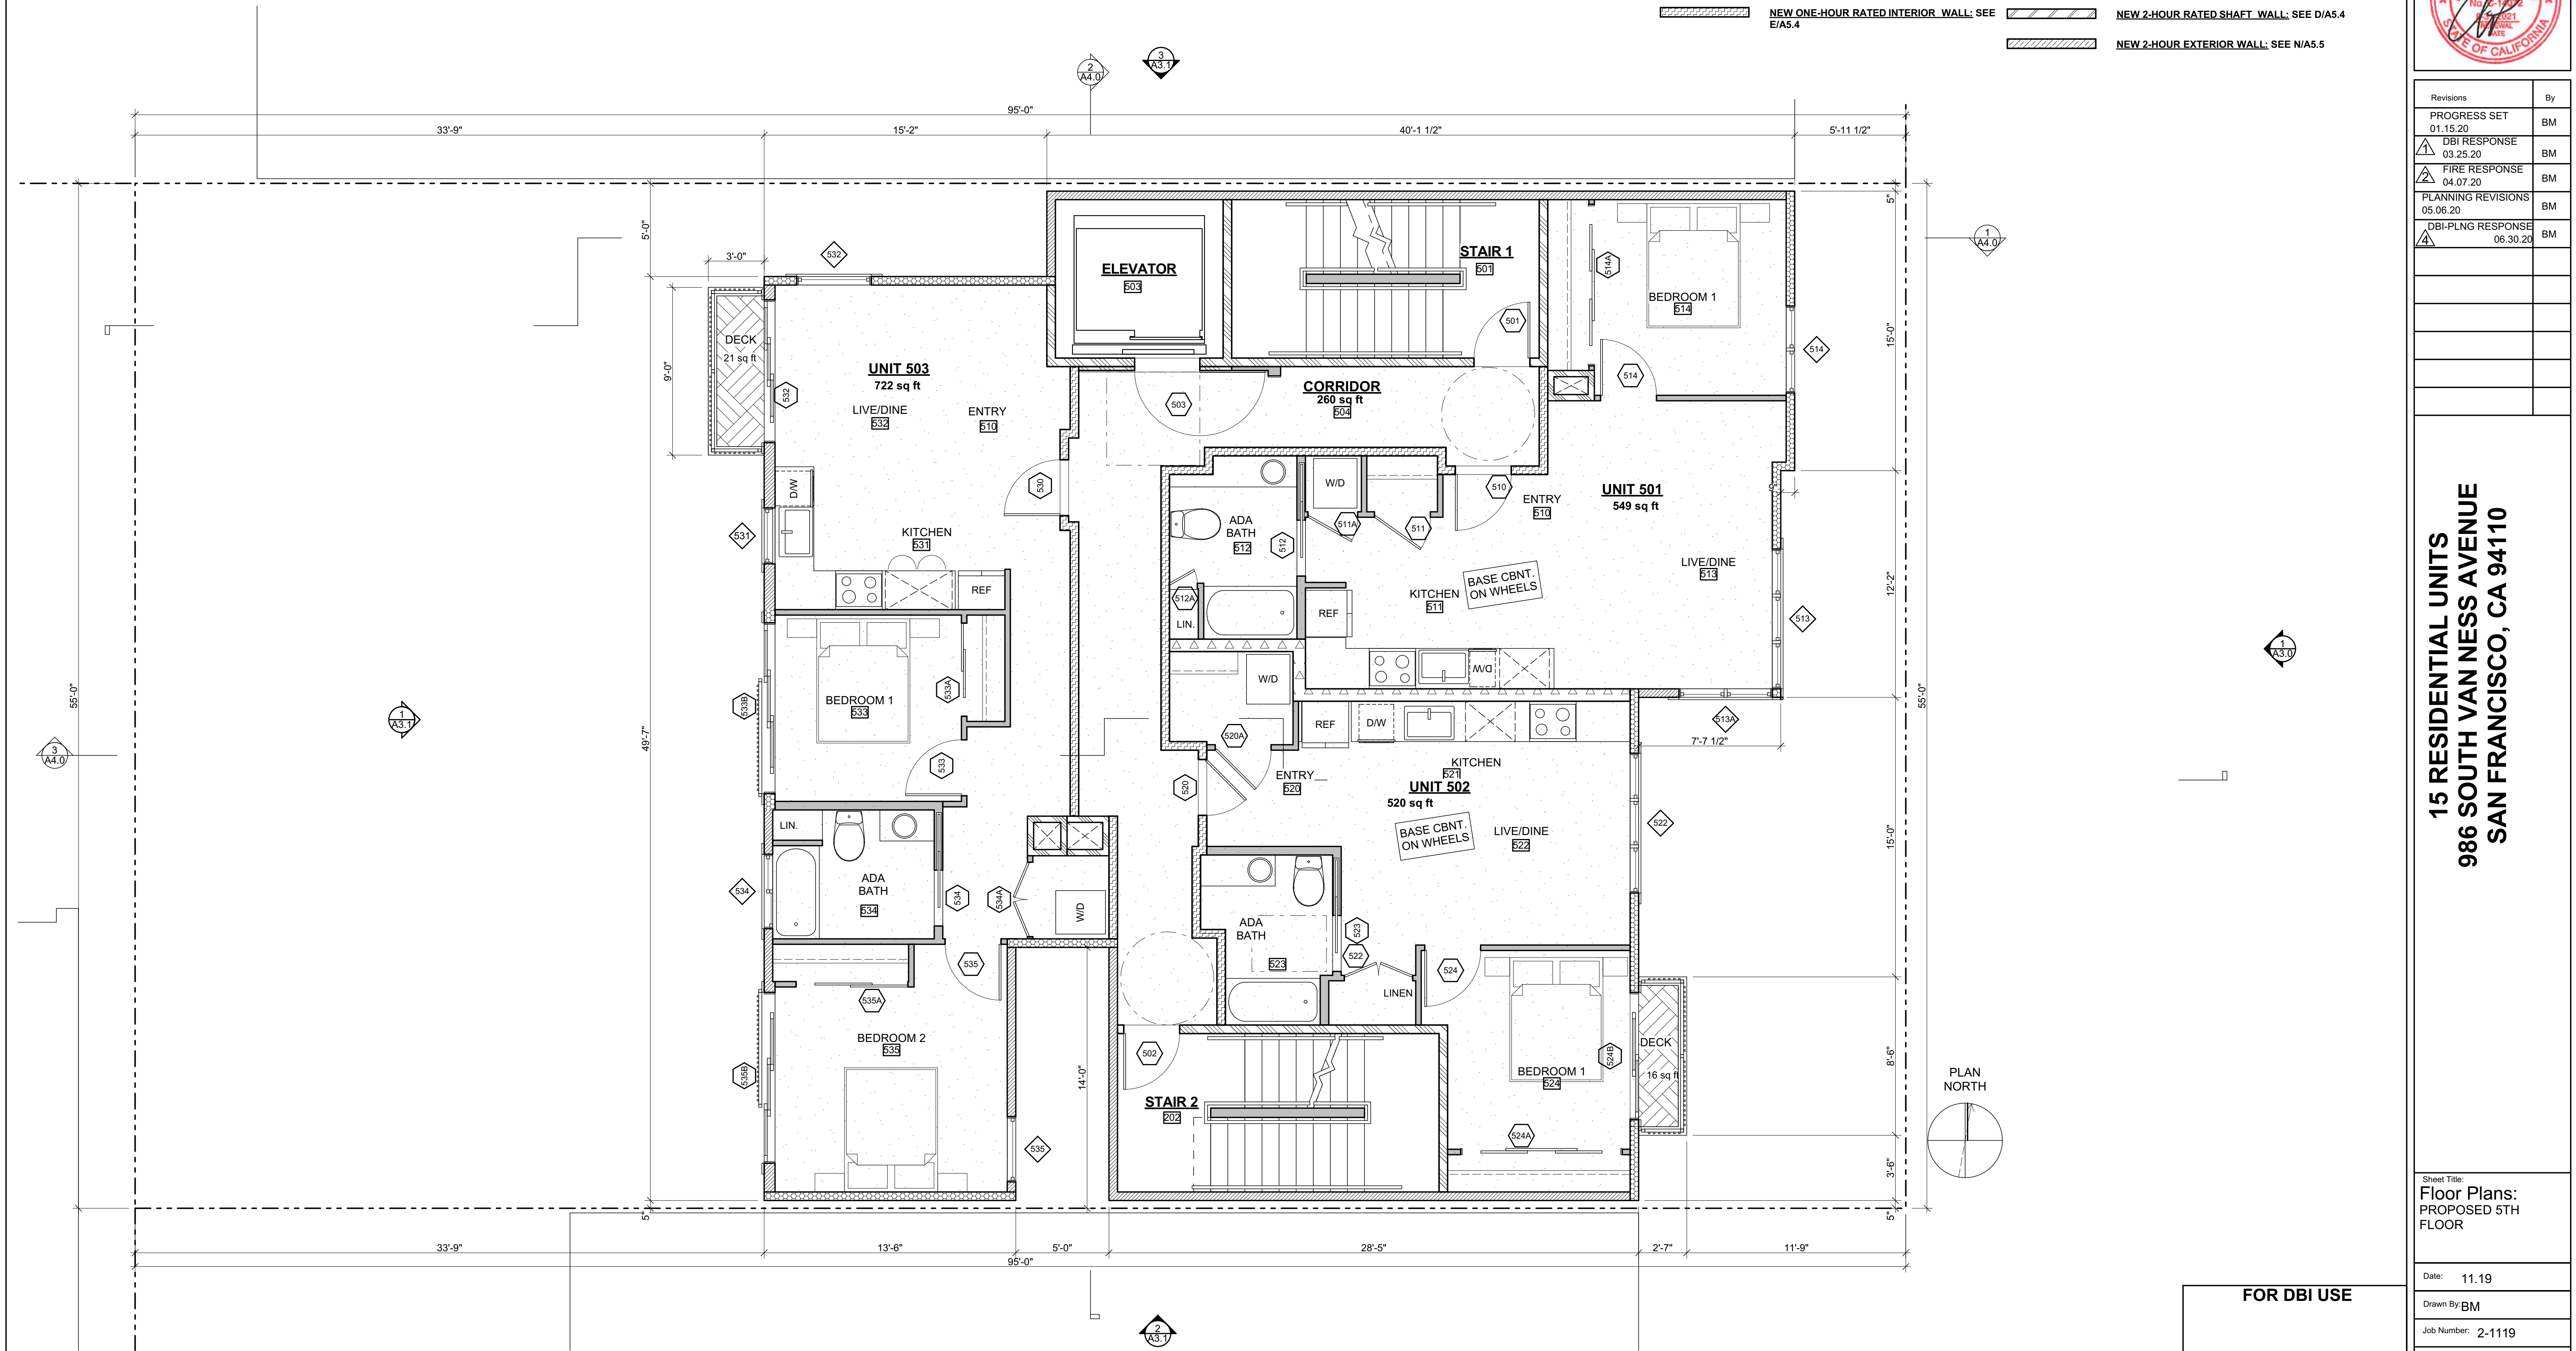

**Kotas/
Pantaleoni
Architects**
Anthony A. Pantaleoni
LEED AP
717 Zee Street Suite 200
San Francisco, California 94107
t 415 496 4051
design@kp-architects.com



Revisions	By
PROGRESS SET 01.15.20	BM
DBI RESPONSE 03.25.20	BM
FIRE RESPONSE 04.07.20	BM
PLANNING REVISIONS 05.06.20	BM
DBI-PLNG RESPONSE 06.30.20	BM

**15 RESIDENTIAL UNITS
986 SOUTH VAN NESS AVENUE
SAN FRANCISCO, CA 94110**

Sheet Title:
**Floor Plans:
PROPOSED 5TH
FLOOR**




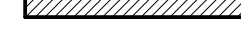








Date: 11.19
Drawn By: BM
Job Number: 2-1119


A2.5

1 PROPOSED 5TH FLOOR
SCALE: 1/4" = 1'-0"

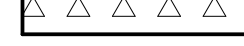FOR DBI USE

WALL SCHEDULE

-  **NEW MASONRY WALL:**
S.S.D. FOR WIDTH & REINFORCING
-  **NEW CONCRETE WALL:**
S.S.D. FOR WIDTH & REINFORCING
-  **NEW ONE-HOUR RATED EXTERIOR WALL:** SEE A/A5.4
-  **NEW TWO-HOUR RATED EXTERIOR WALL:** SEE B/A5.4
-  **NEW ONE-HOUR RATED INTERIOR WALL:** SEE E/A5.4
-  **NEW ONE-HOUR RATED INTERIOR BEARING WALL:** SEE F/A5.4
-  **NEW ONE-HOUR RATED INTERIOR PARTY WALL:** SEE C/A5.4
-  **NEW TWO-HOUR RATED INTERIOR WALL:** SEE G/A5.4
-  **NEW NON-RATED INTERIOR WALL:** SEE H/A5.5
-  **NEW LOW HEIGHT INTERIOR WALL:**
-  **NEW 2-HOUR RATED SHAFT WALL:** SEE D/A5.4
-  **NEW 2-HOUR EXTERIOR WALL:** SEE N/A5.5

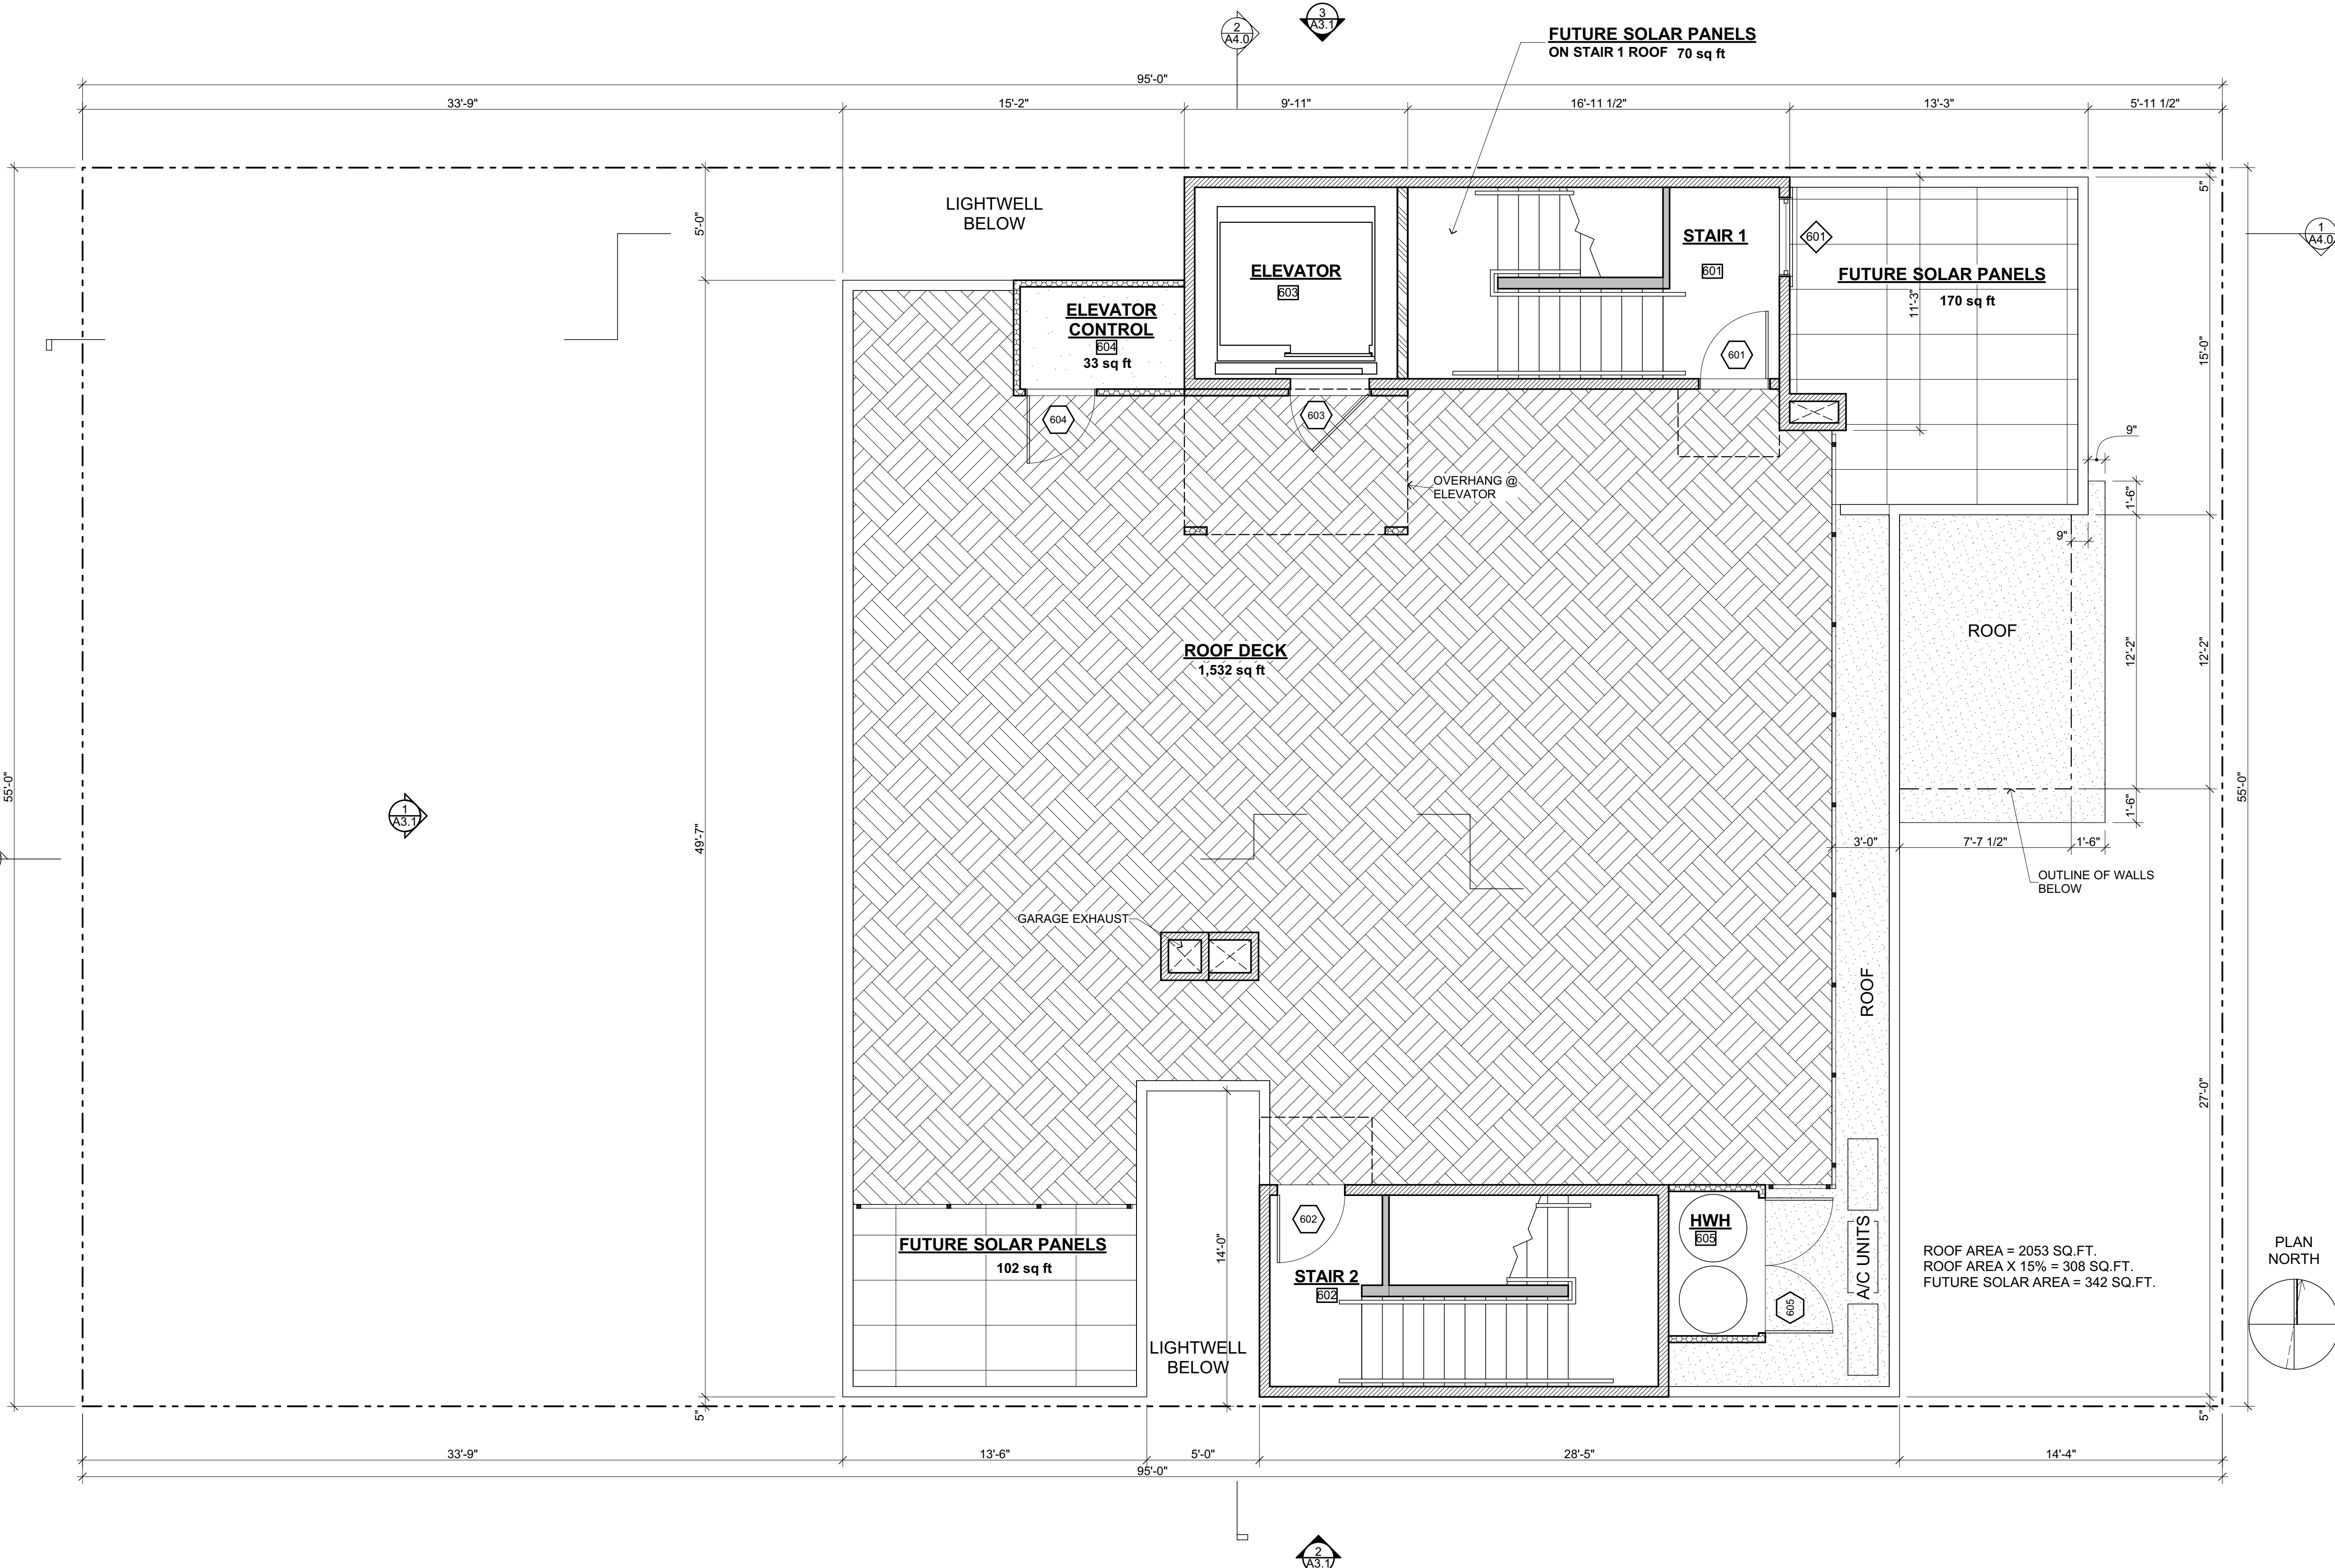

Kotas/
Pantaleoni
Architects
Anthony A. Pantaleoni
LEED AP
712 Zee Street Suite 200
San Francisco, California 94107
t 415 496 4051
design@kp-architects.com



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PLANNING REVISIONS 05.06.20	BM
DBI-PLNG RESPONSE 06.30.20	BM

15 RESIDENTIAL UNITS
986 SOUTH VAN NESS AVENUE
SAN FRANCISCO, CA 94110

Sheet Title:
Floor Plans:
PROPOSED
ROOF

Date: 11.19
Drawn By: BM
Job Number: 2-1119

FOR DBI USE

1 PROPOSED ROOF
SCALE: 1/4" = 1'-0"

A2.6



Revisions	By
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DBI-PLNG RESPONSE 06.30.20	BM

15 RESIDENTIAL UNITS
986 SOUTH VAN NESS AVENUE
SAN FRANCISCO, CA 94110

Sheet Title:
Exterior Elevs:
EAST

Date: 11.19
Drawn By: BM
Job Number: 2-1119

A3.0




- 1 PAINTED CEMENT PLASTER
 - 2 1X6 PAINTED HORIZONTAL SIDING
 - 3 1X3 PAINTED HORIZONTAL SIDING
 - 4 BRICK VENEER
 - 5 BLIND WALL
- SEE A2.0b FOR DETAILS


1 PROPOSED EAST ELEVATION @ VAN NESS
SCALE: 1/4" = 1'-0"

FOR DBI USE

Printed on: 6/20/2020

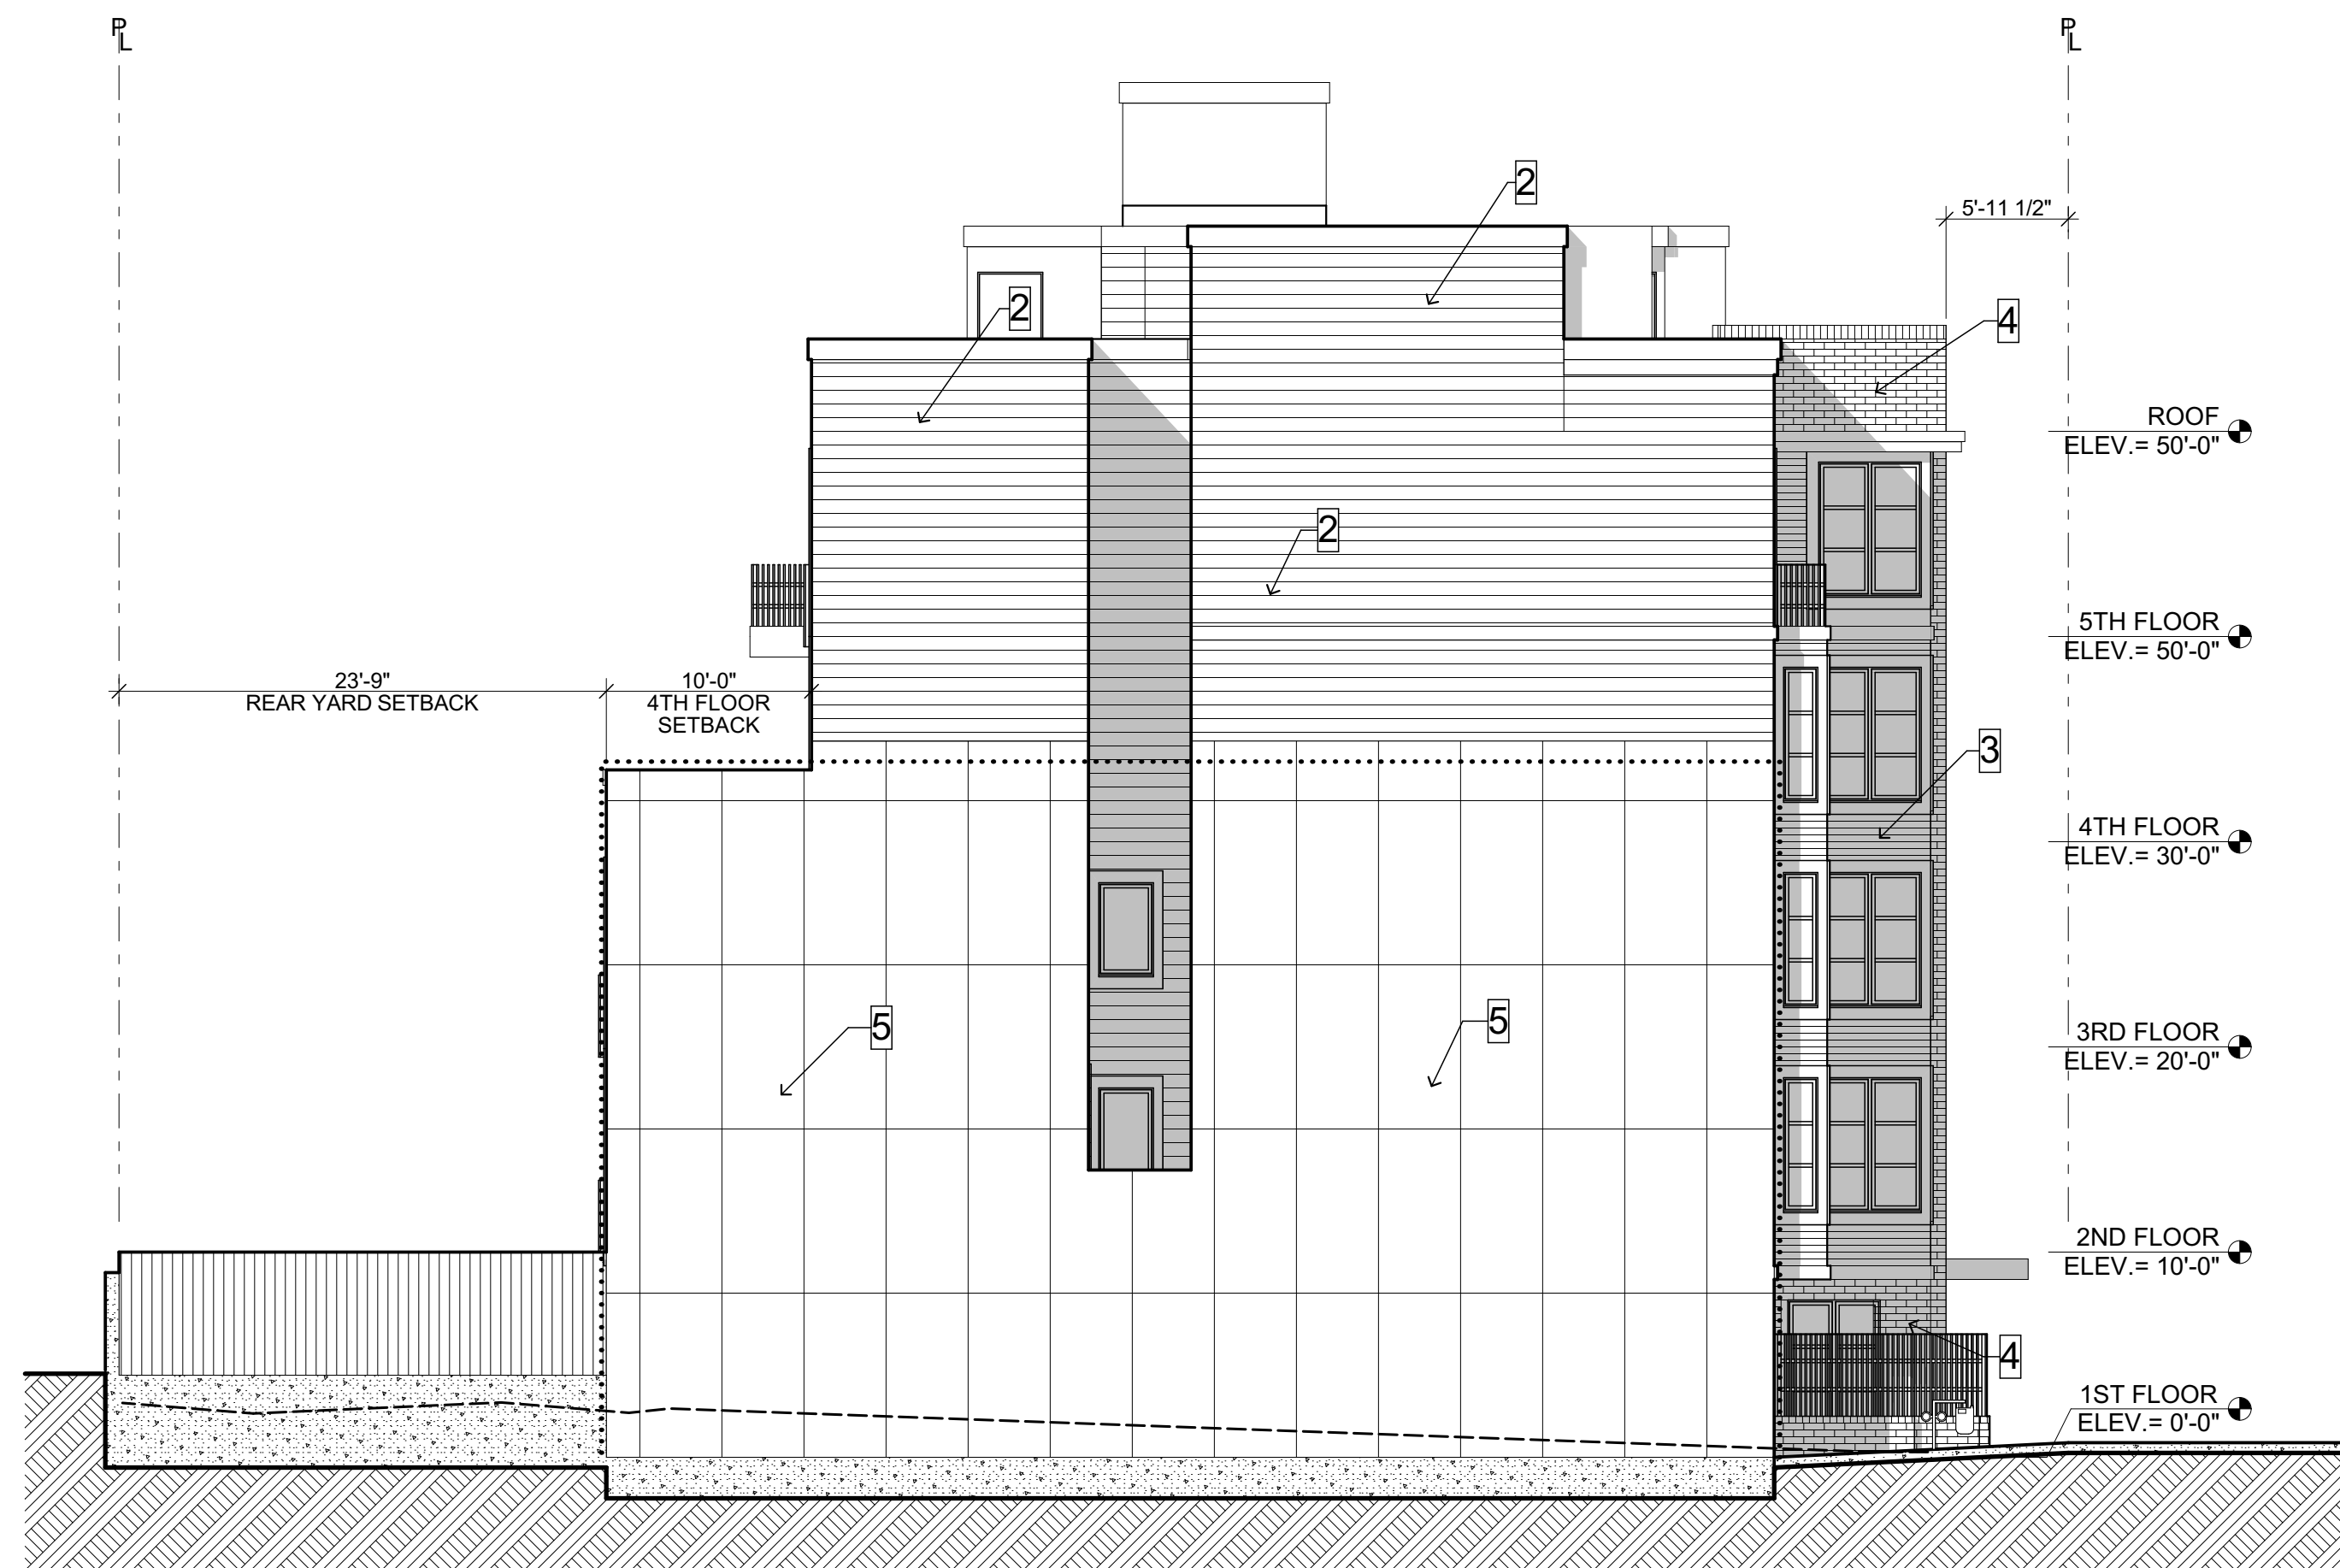

2 PROPOSED SOUTH ELEVATION
SCALE: 1/8" = 1'-0"

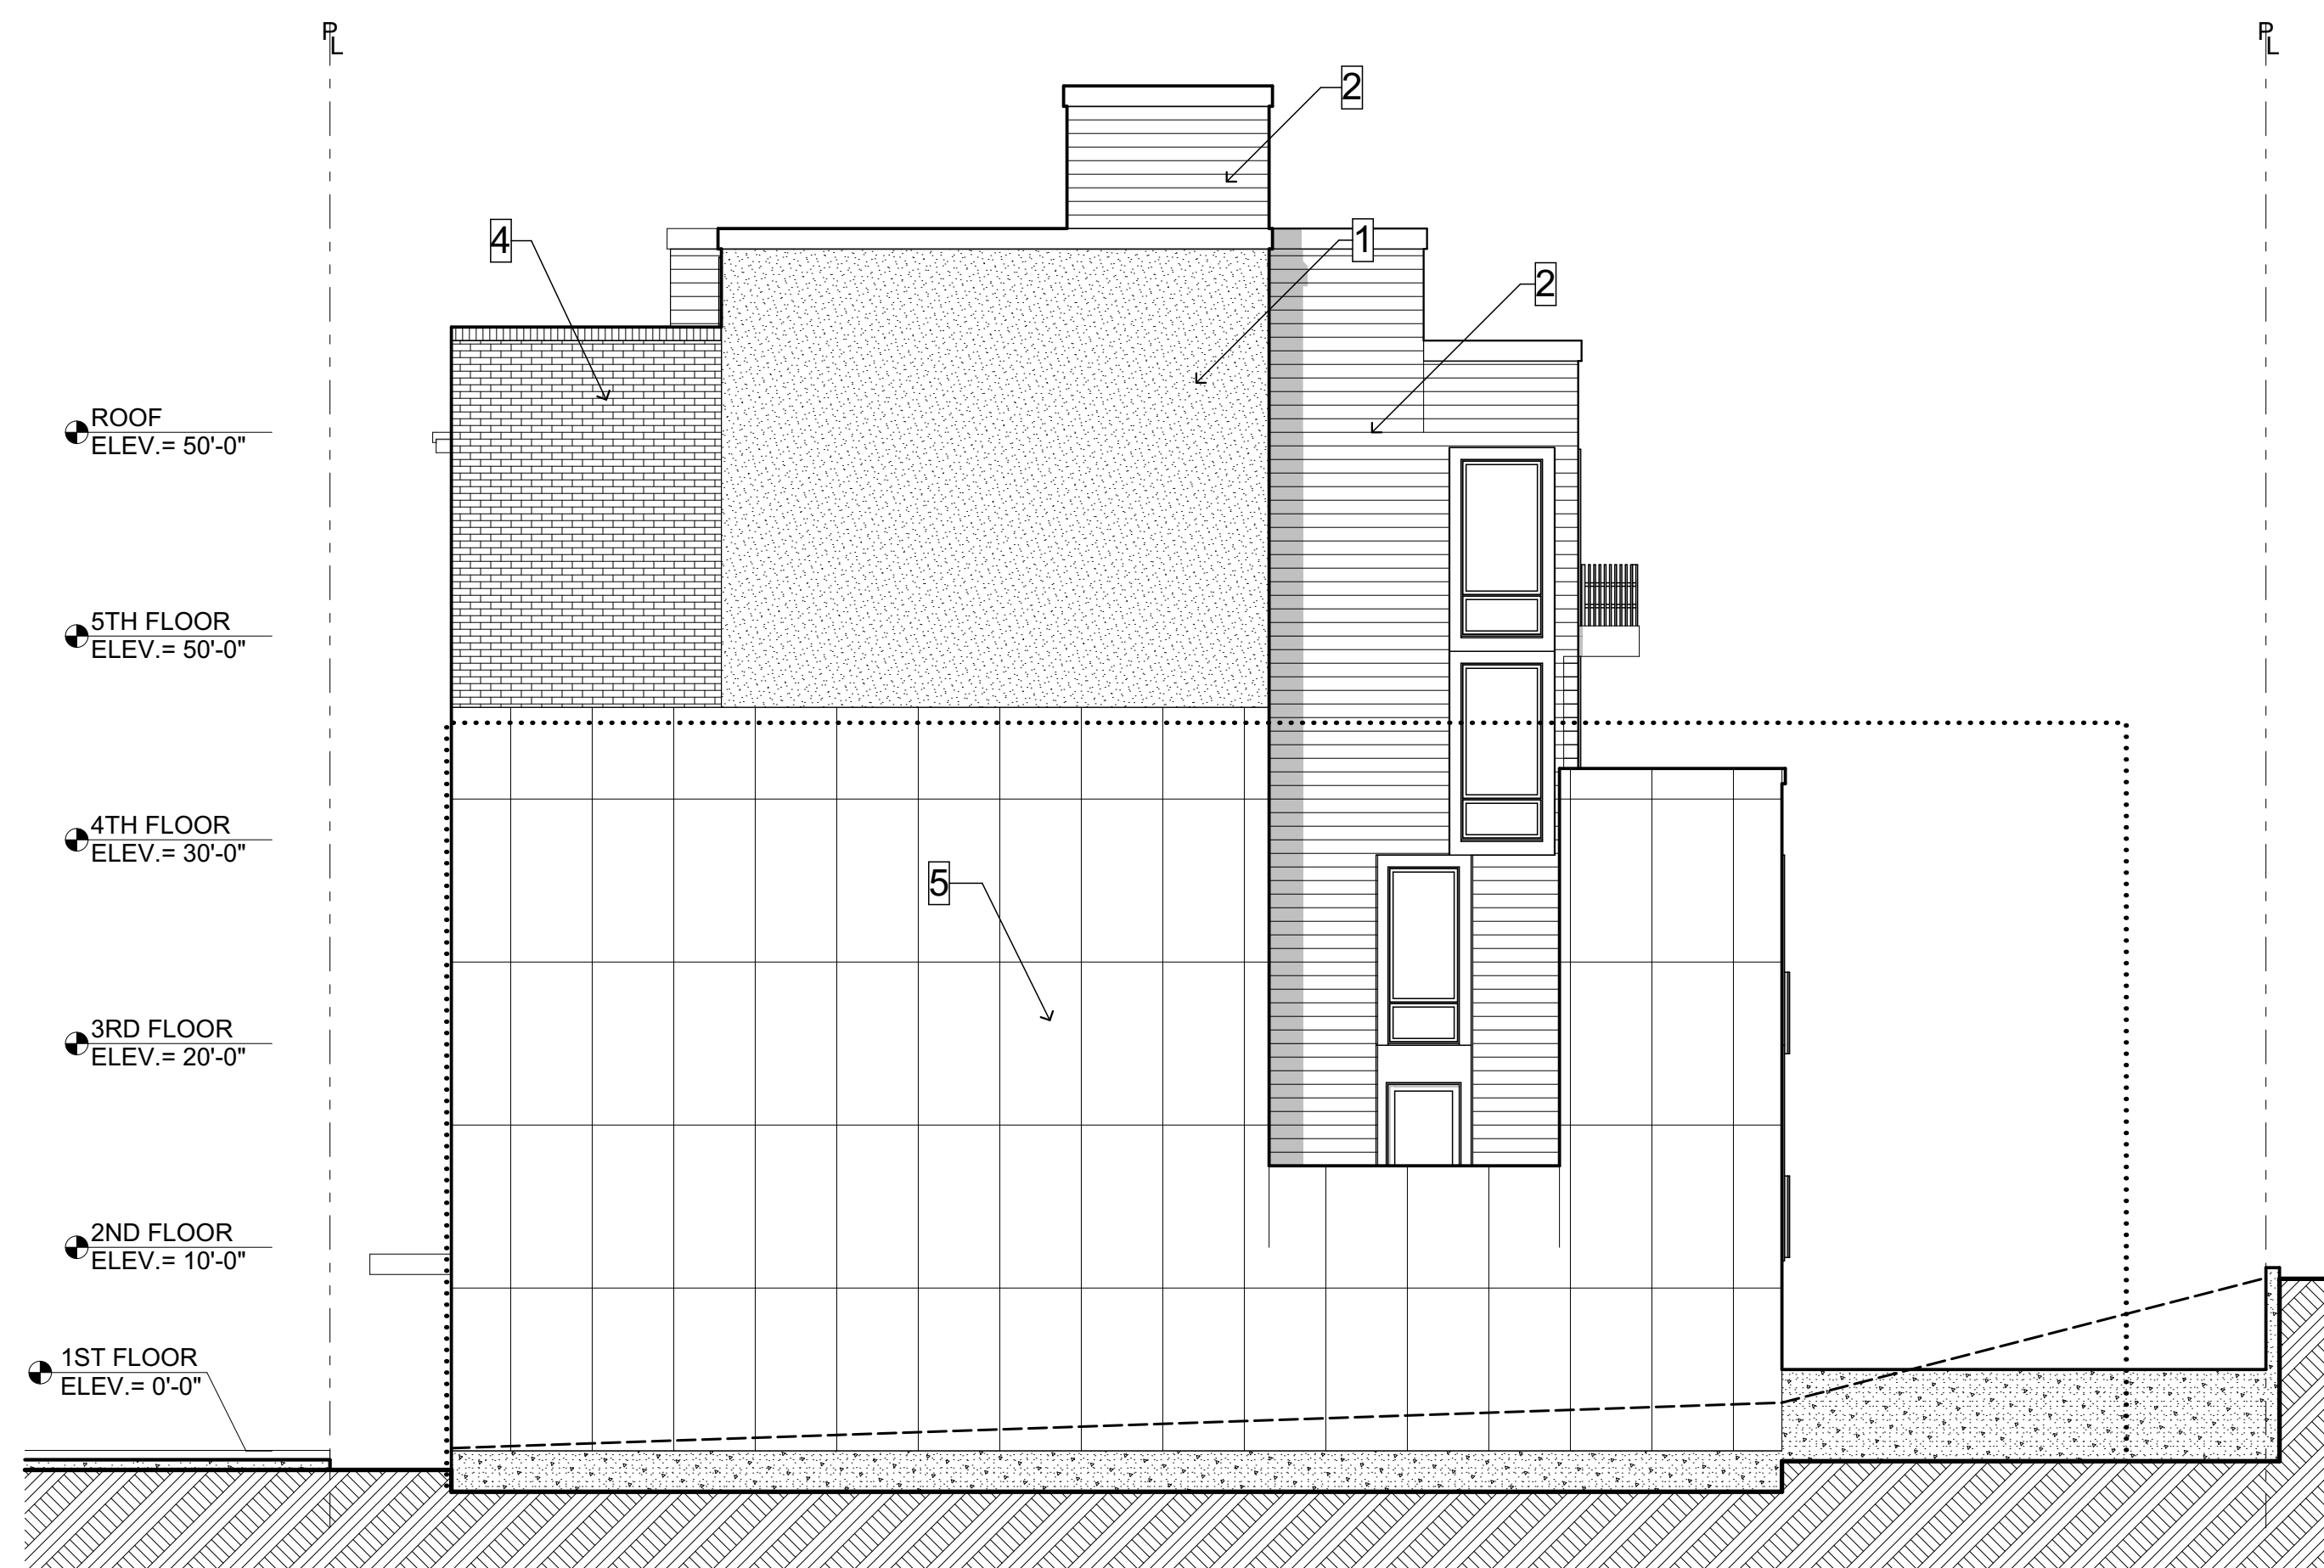

3 PROPOSED NORTH ELEVATION
SCALE: 1/8" = 1'-0"



1 PROPOSED WEST ELEVATION @ REAR
SCALE: 1/4" = 1'-0"

- 1 PAINTED CEMENT PLASTER
 - 2 1X6 PAINTED HORIZONTAL SIDING
 - 3 1X3 PAINTED HORIZONTAL SIDING
 - 4 BRICK VENEER
 - 5 BLIND WALL
- SEE A2.0b FOR DETAILS

Kotas/
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Anthony A. Pantaleoni
LEED AP
712 Zee Street Suite 200
San Francisco, California 94107
t 415 496 4051
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DBI-PLNG RESPONSE 06.30.20	BM

15 RESIDENTIAL UNITS
986 SOUTH VAN NESS AVENUE
SAN FRANCISCO, CA 94110

Sheet Title:
**Exterior Elevs:
WEST, NORTH,
SOUTH**

Date: 11.19
Drawn By: BM
Job Number: 2-1119

FOR DBI USE

A3.1




Revisions	By
PROGRESS SET 01.15.20	BM
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15 RESIDENTIAL UNITS
986 SOUTH VAN NESS AVENUE
SAN FRANCISCO, CA 94110


Sheet Title:
Sections:
LONG & SHORT

Date: 11.19
Drawn By: BM
Job Number: 2-1119

A4.0

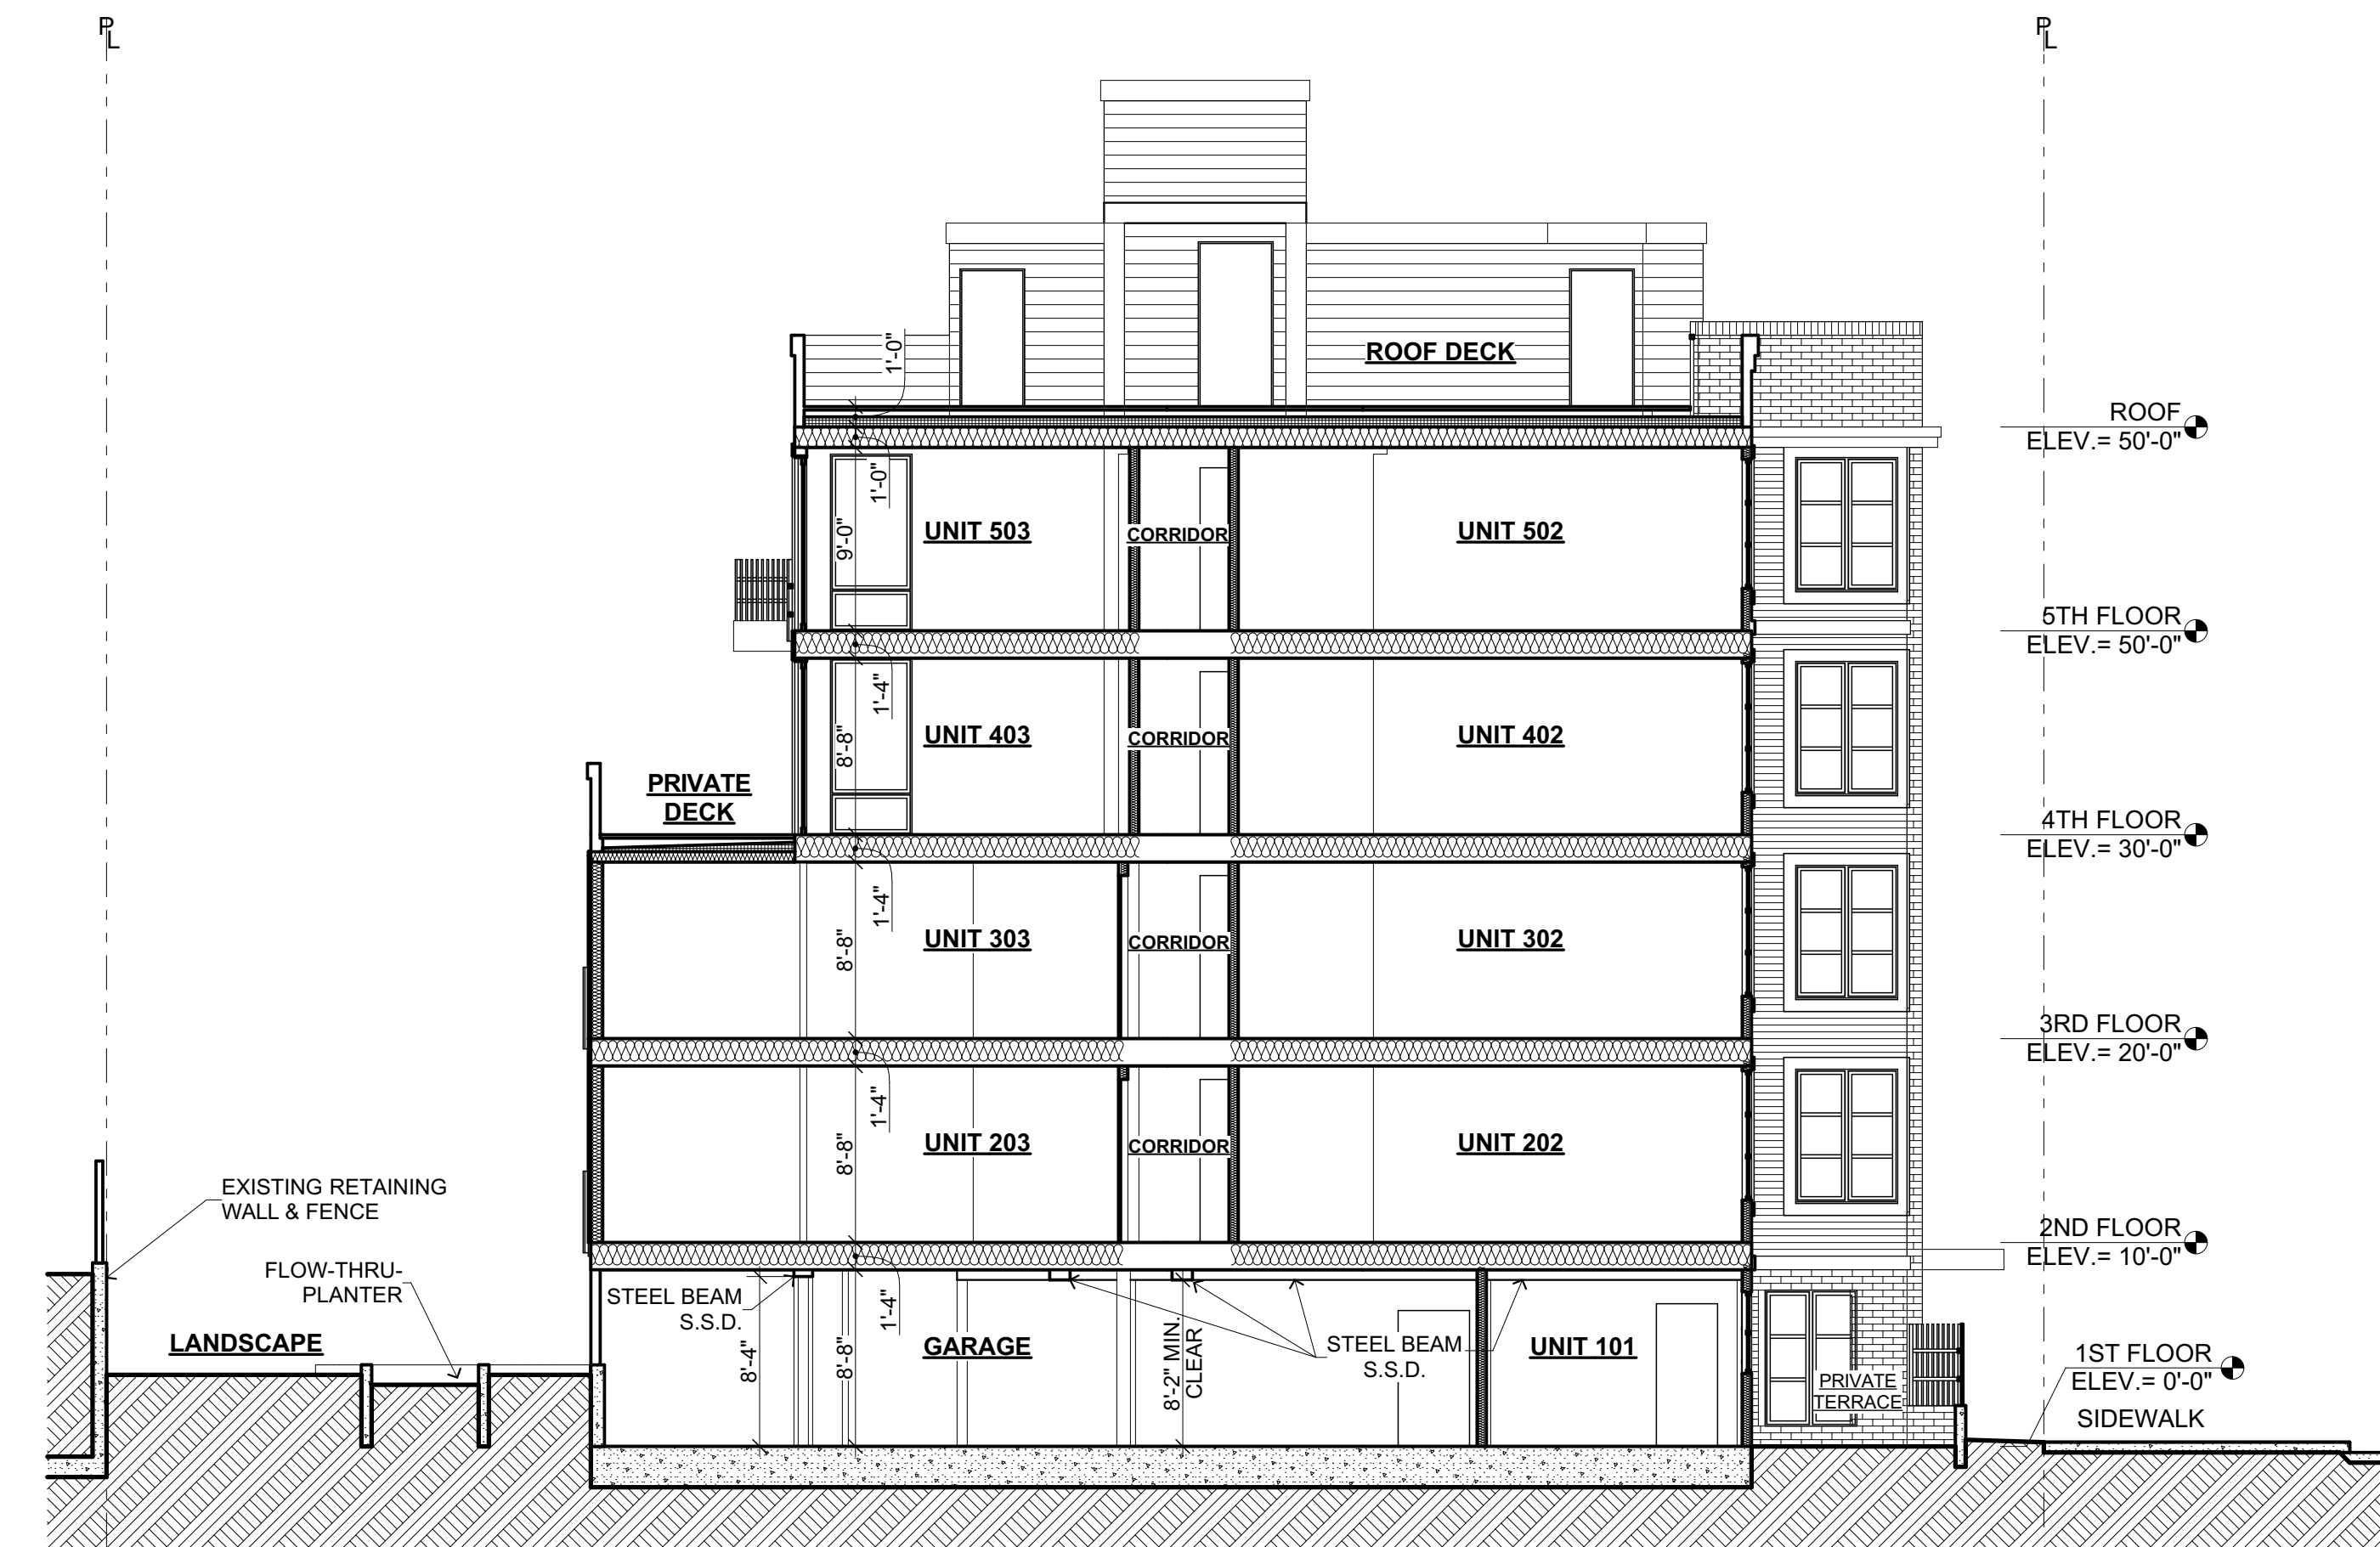


3 EAST-WEST SECTION @ RESIDENTIAL UNITS
SCALE: 1/8" = 1'-0"

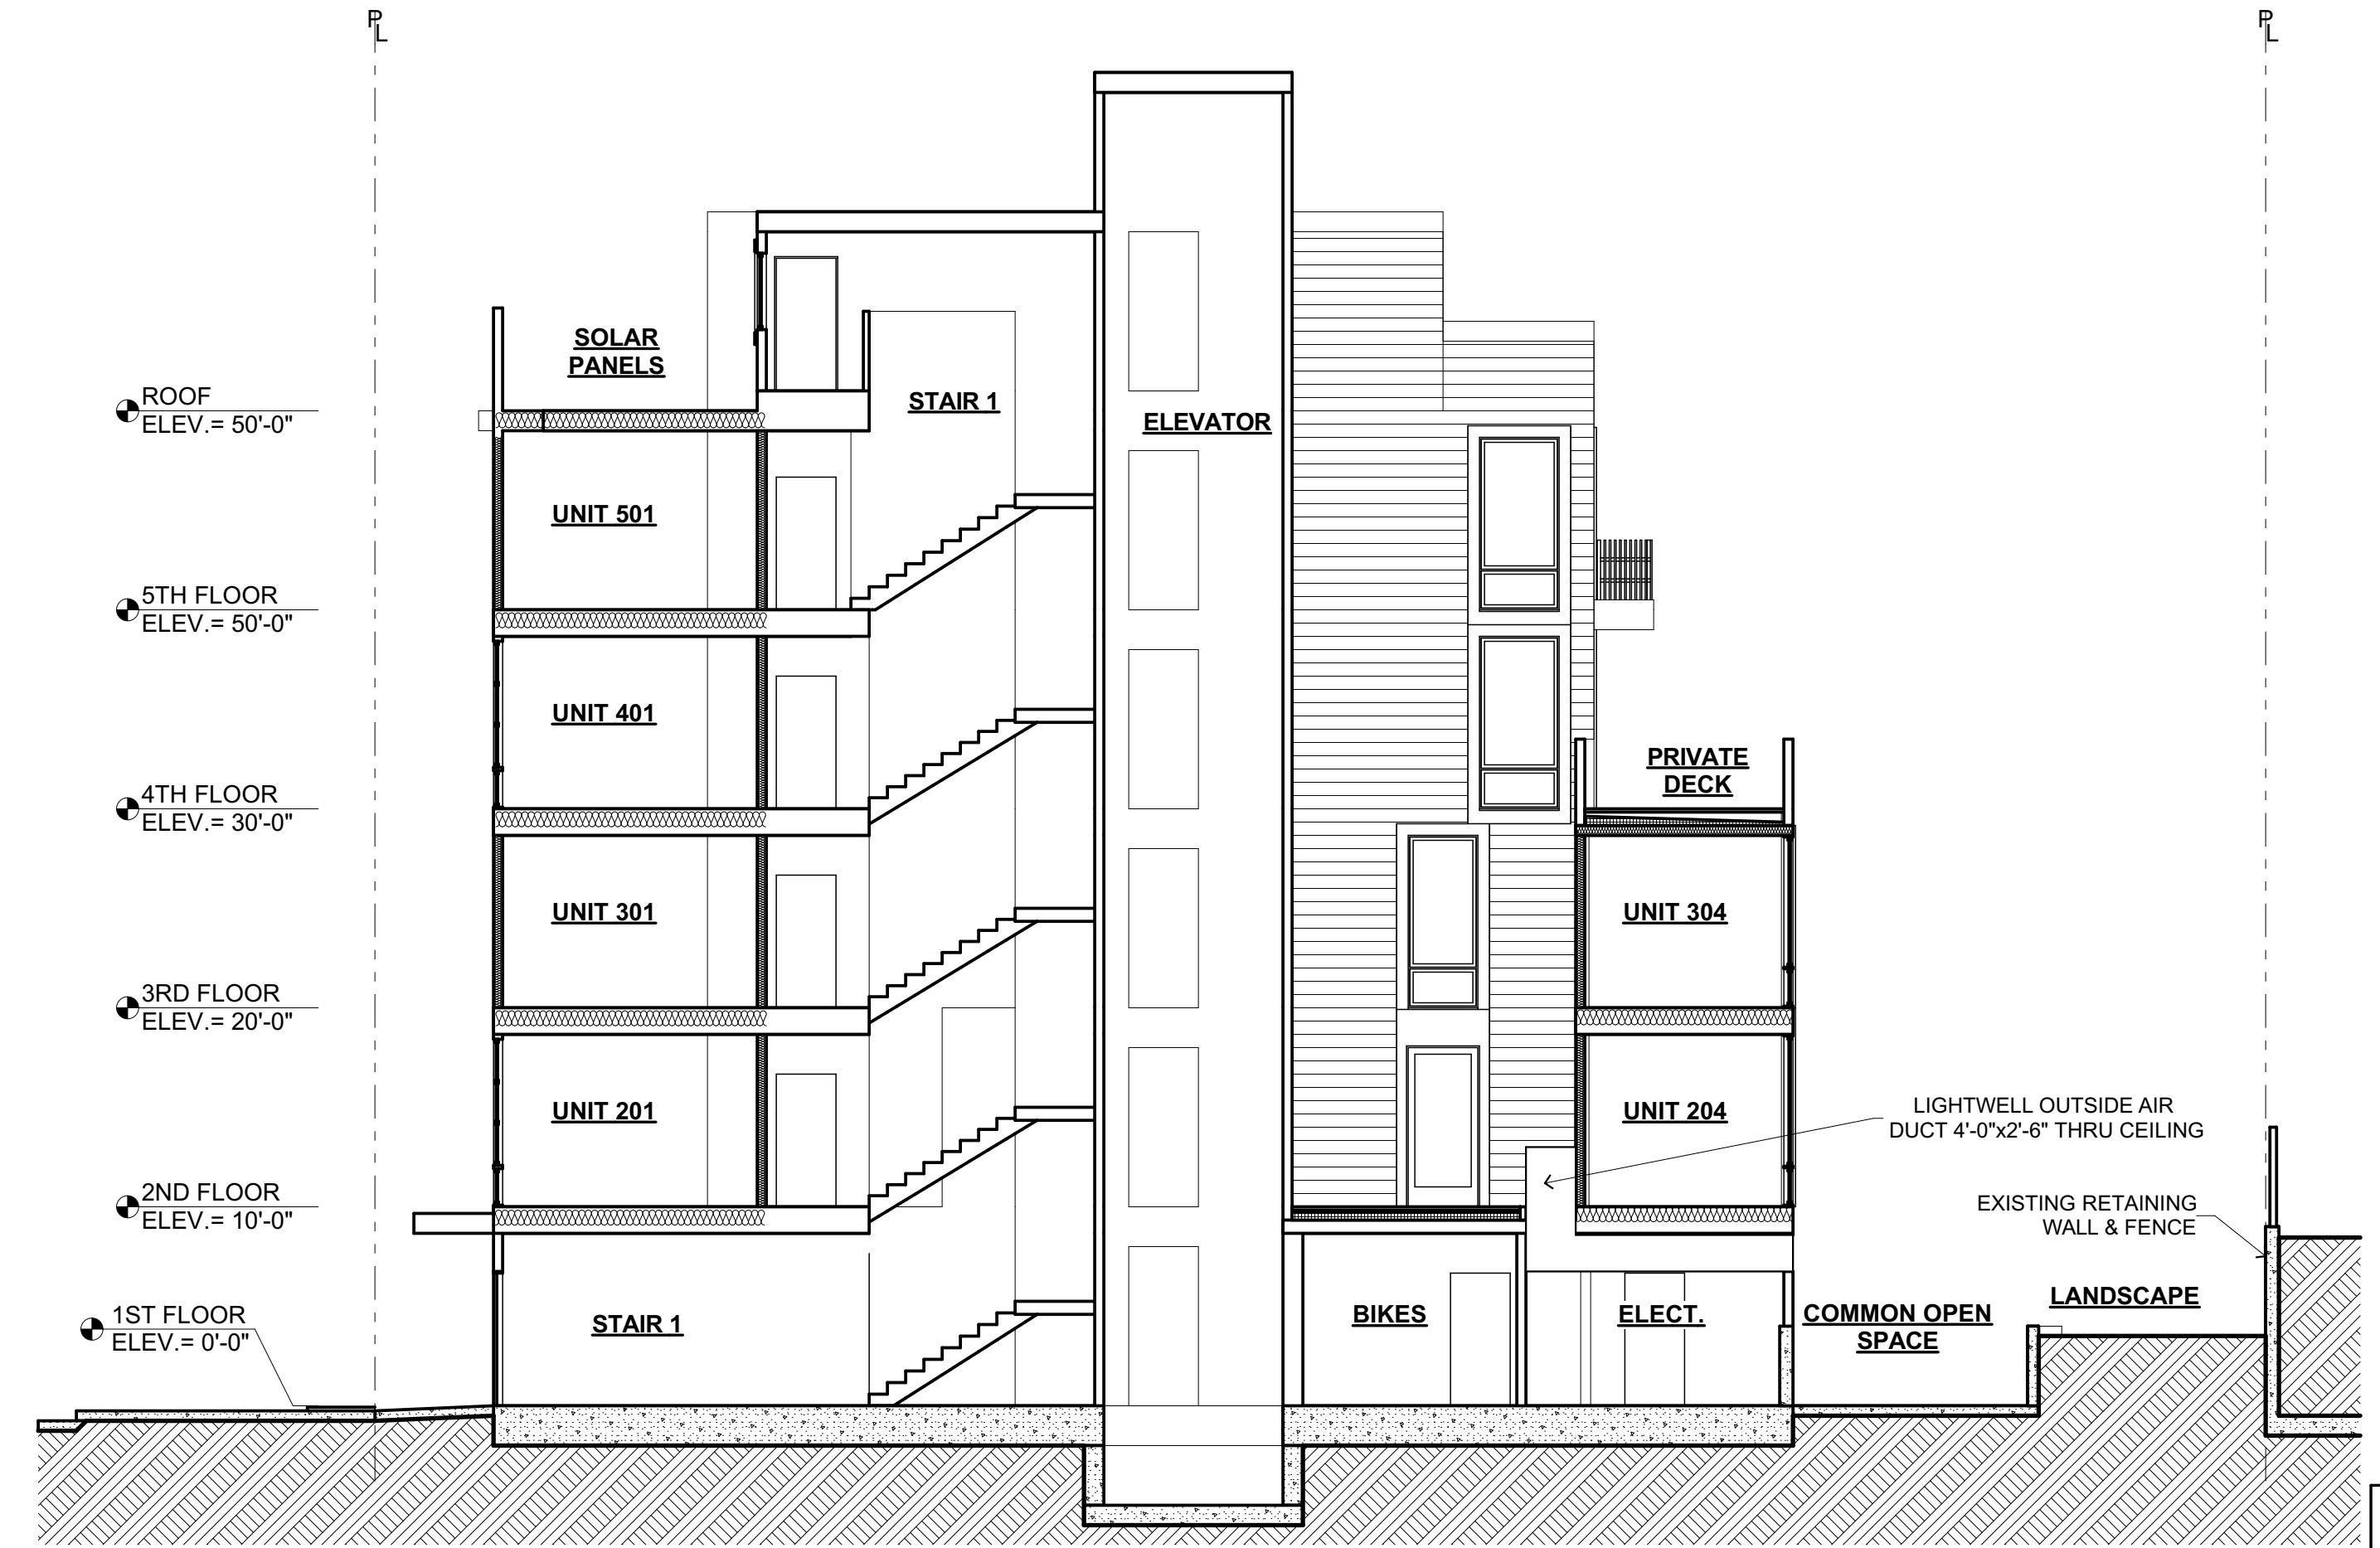







1 EAST-WEST SECTION @ STAIRS
SCALE: 1/8" = 1'-0"

FOR DBI USE

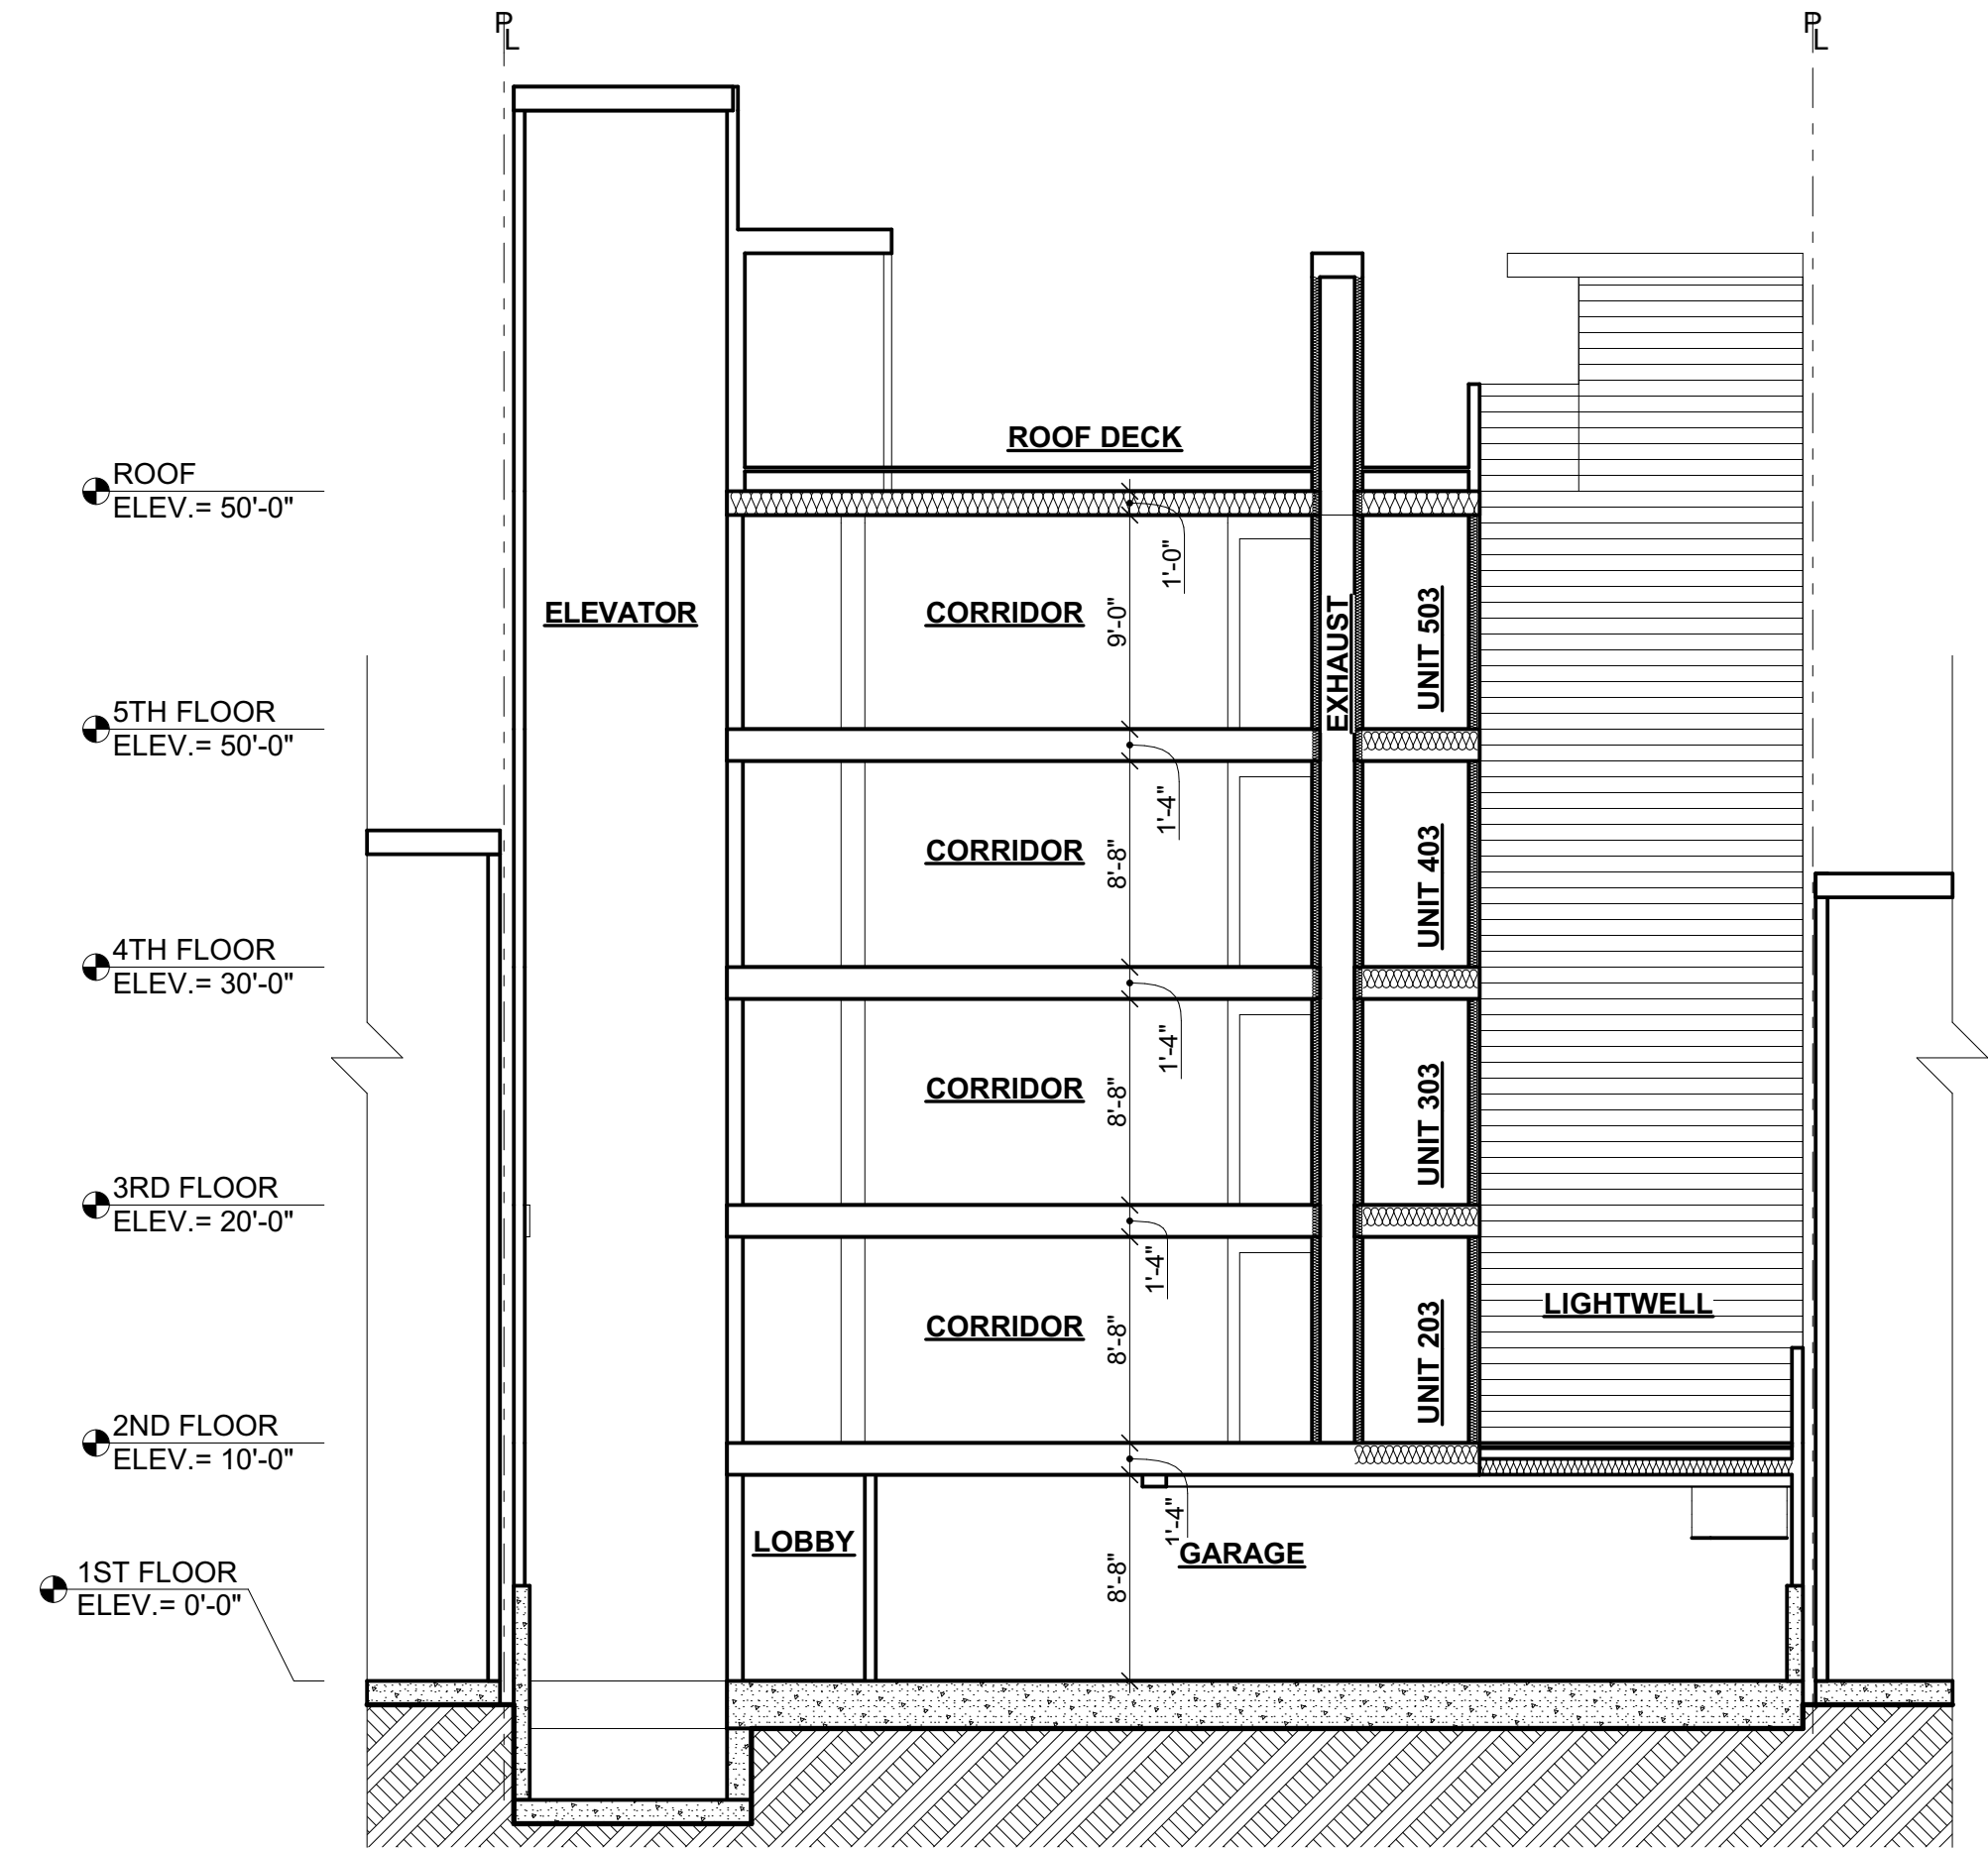

2 NORTH-SOUTH SECTION @ LIGHTWELL
SCALE: 1/8" = 1'-0"










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ACCESSIBILITY NOTES

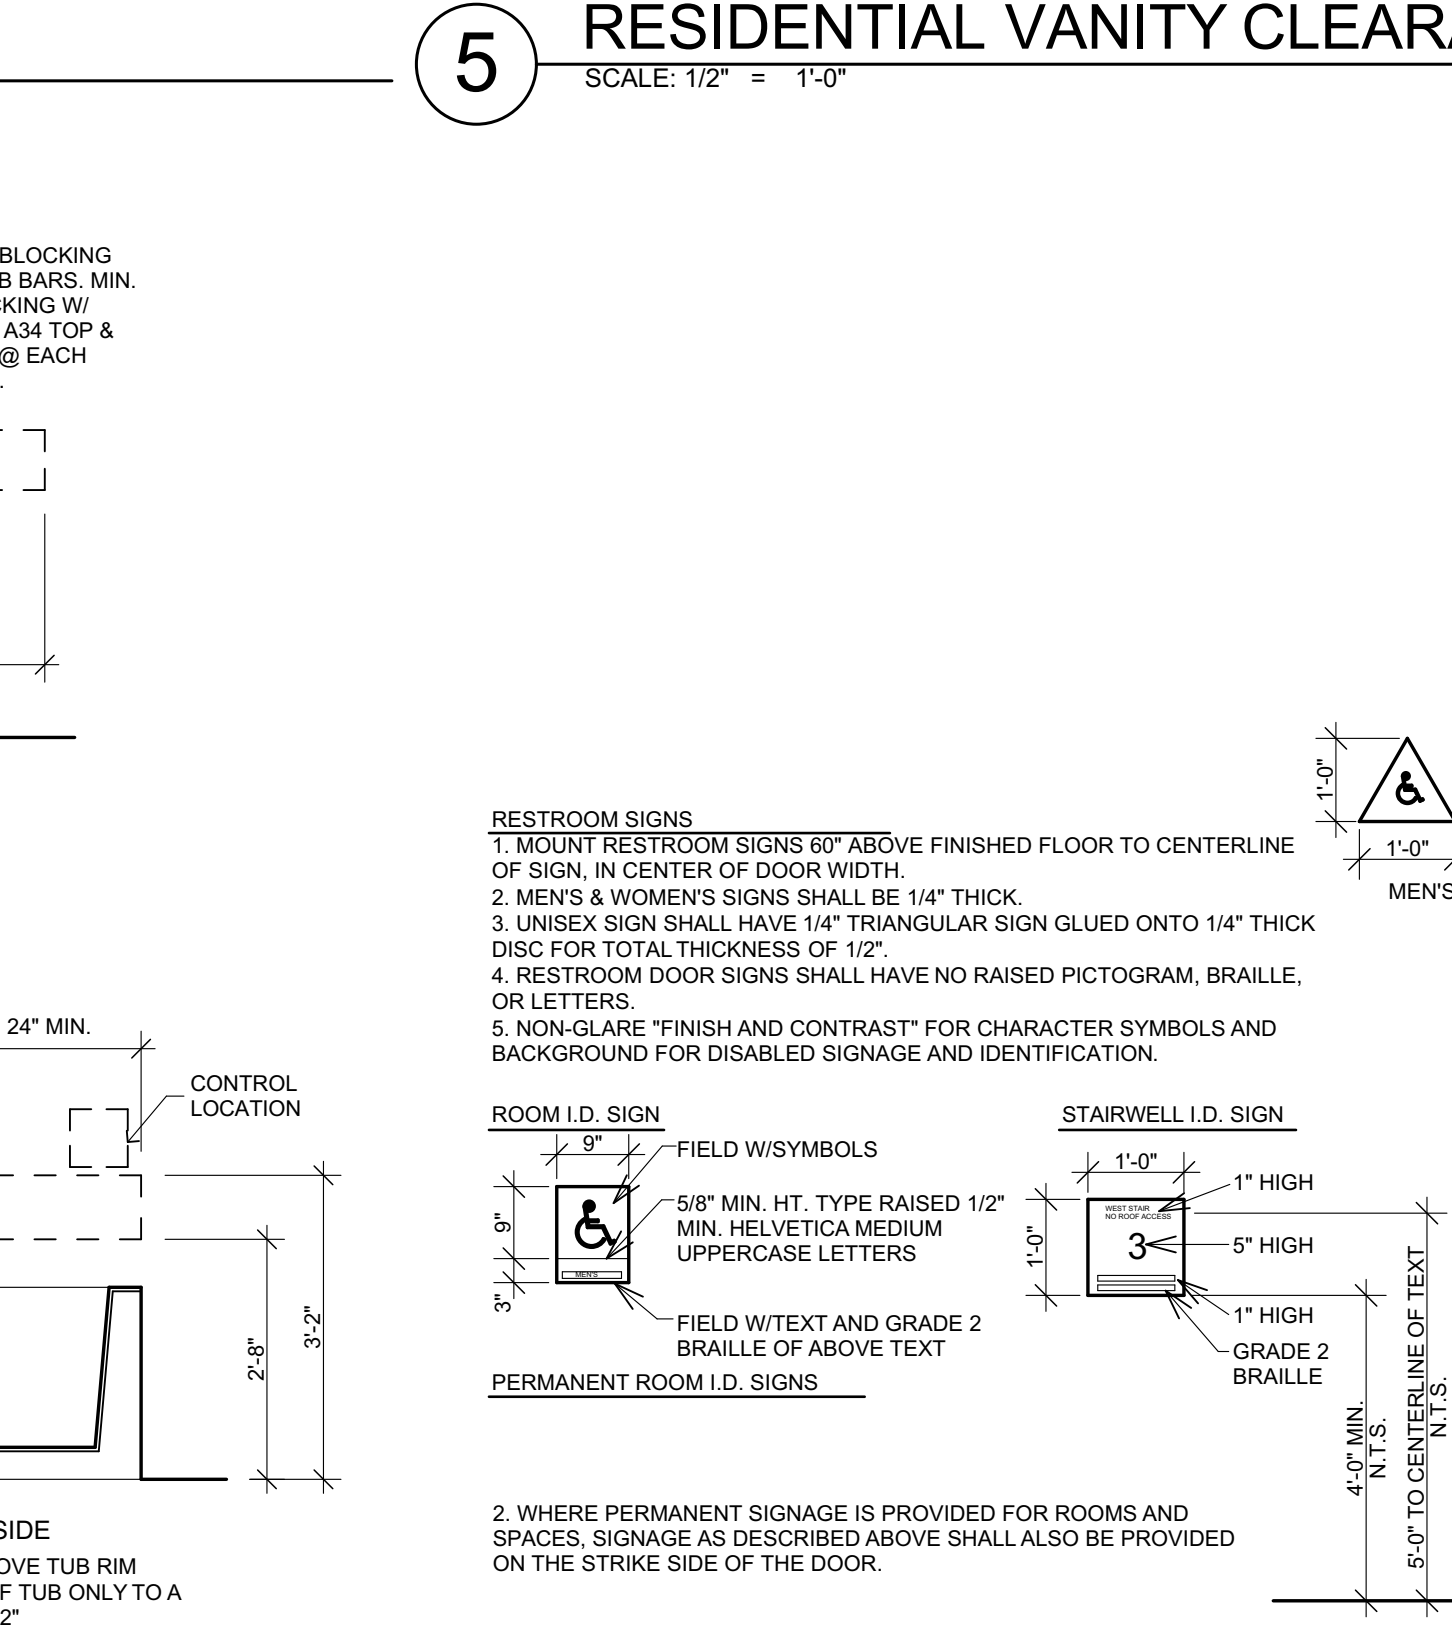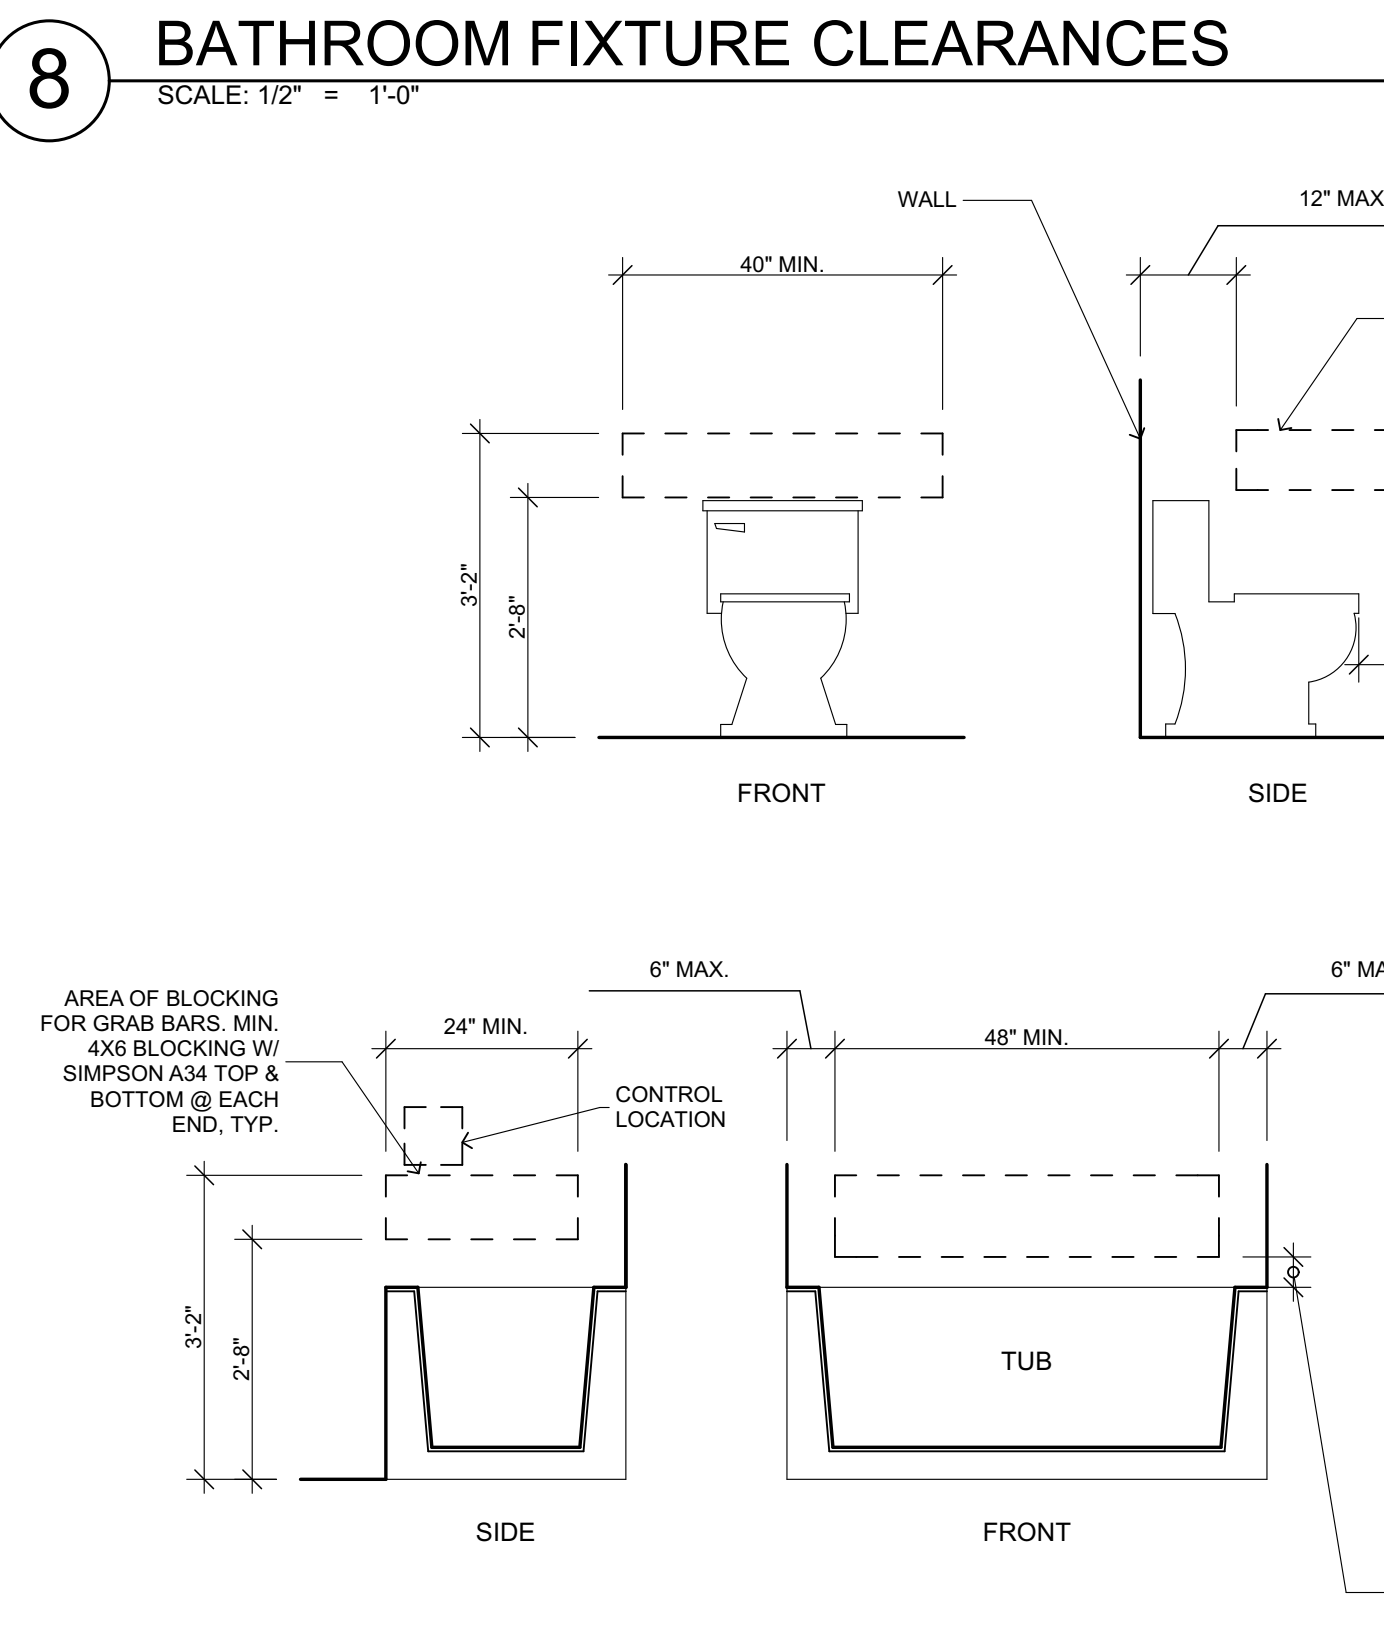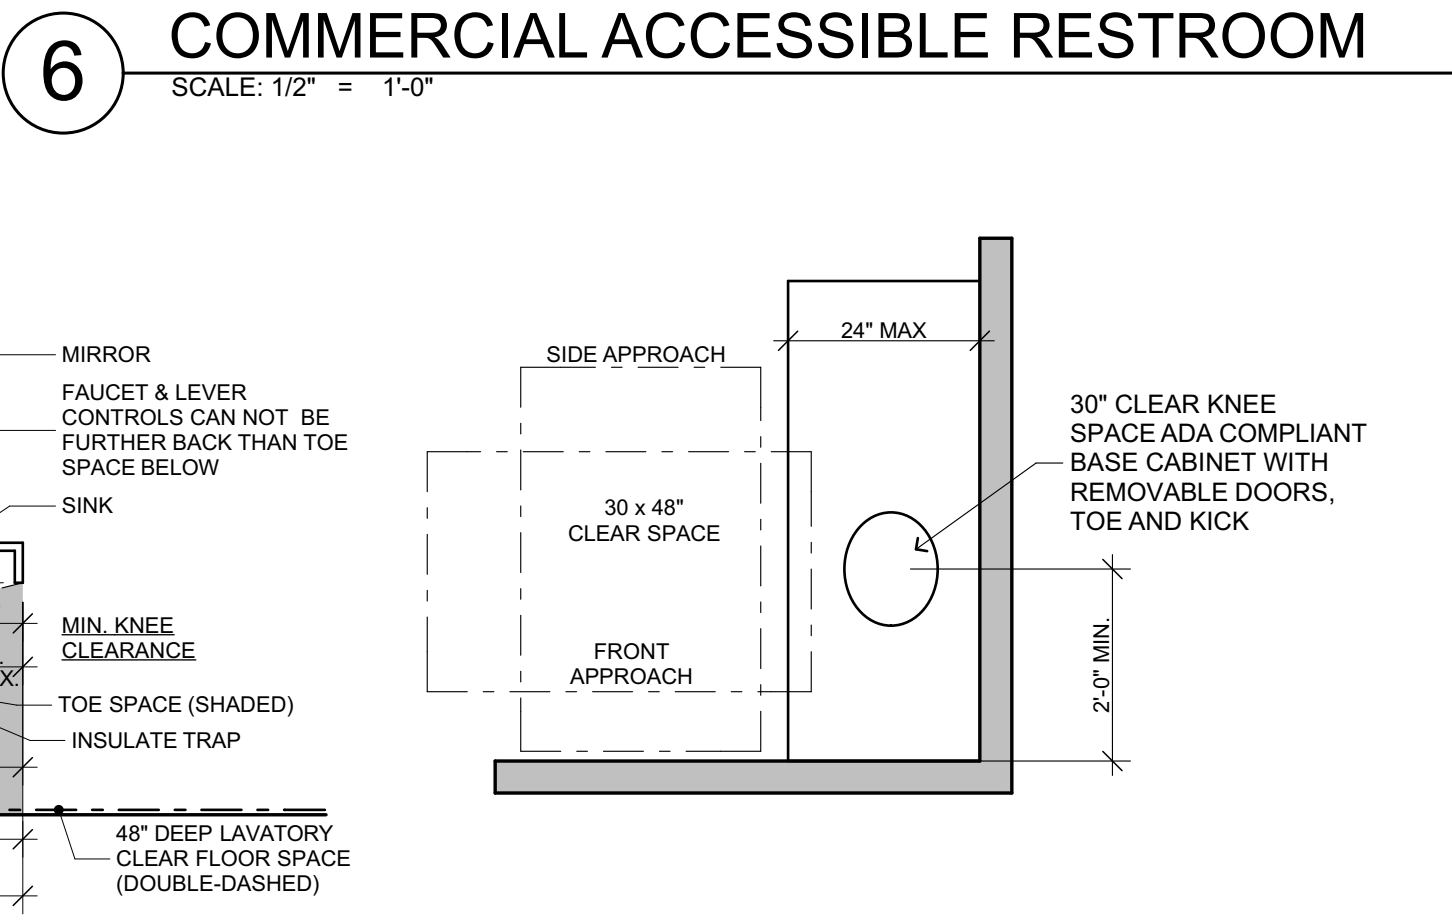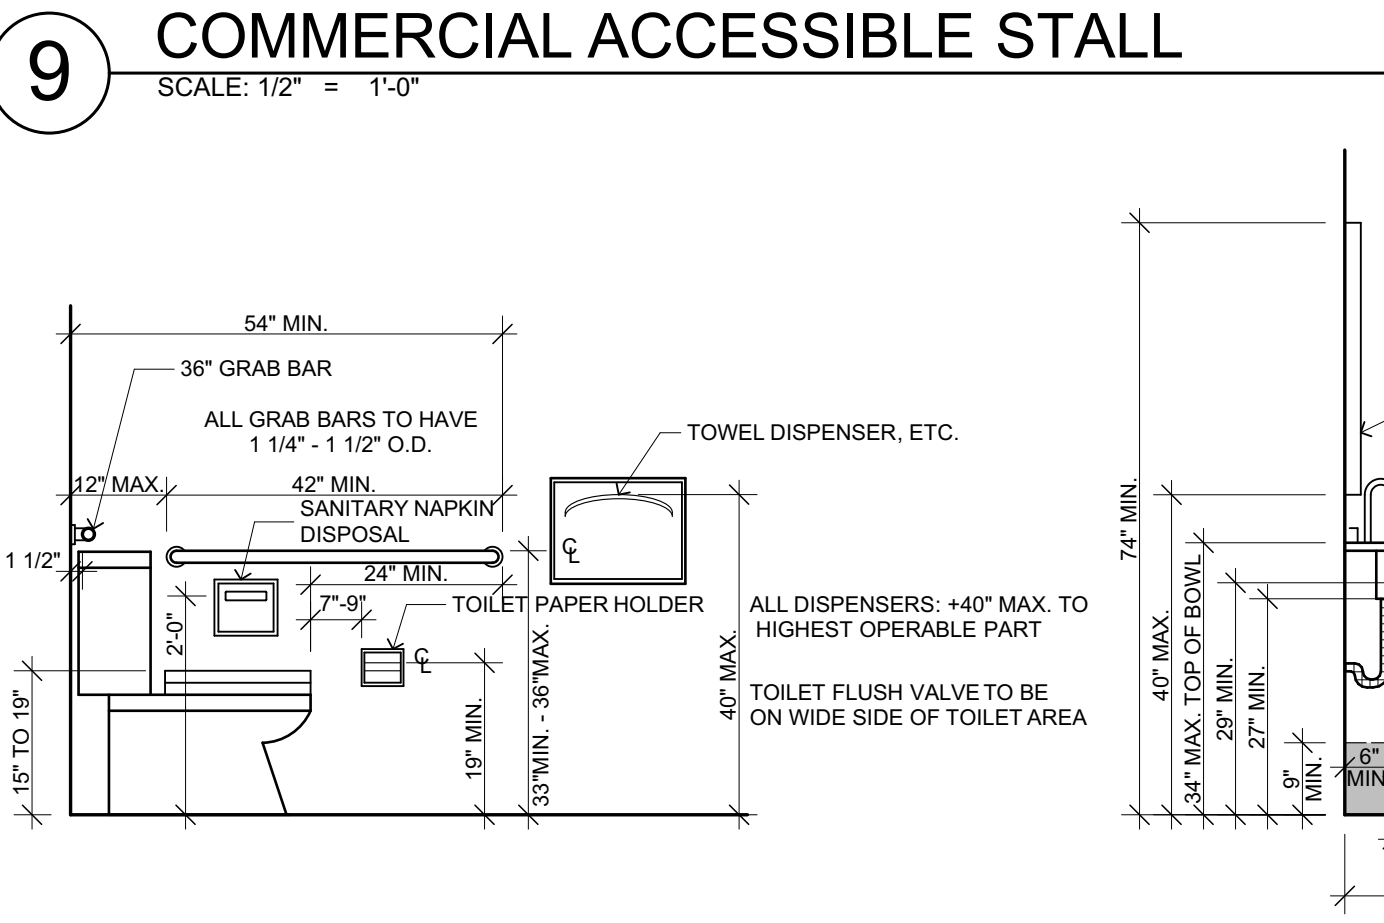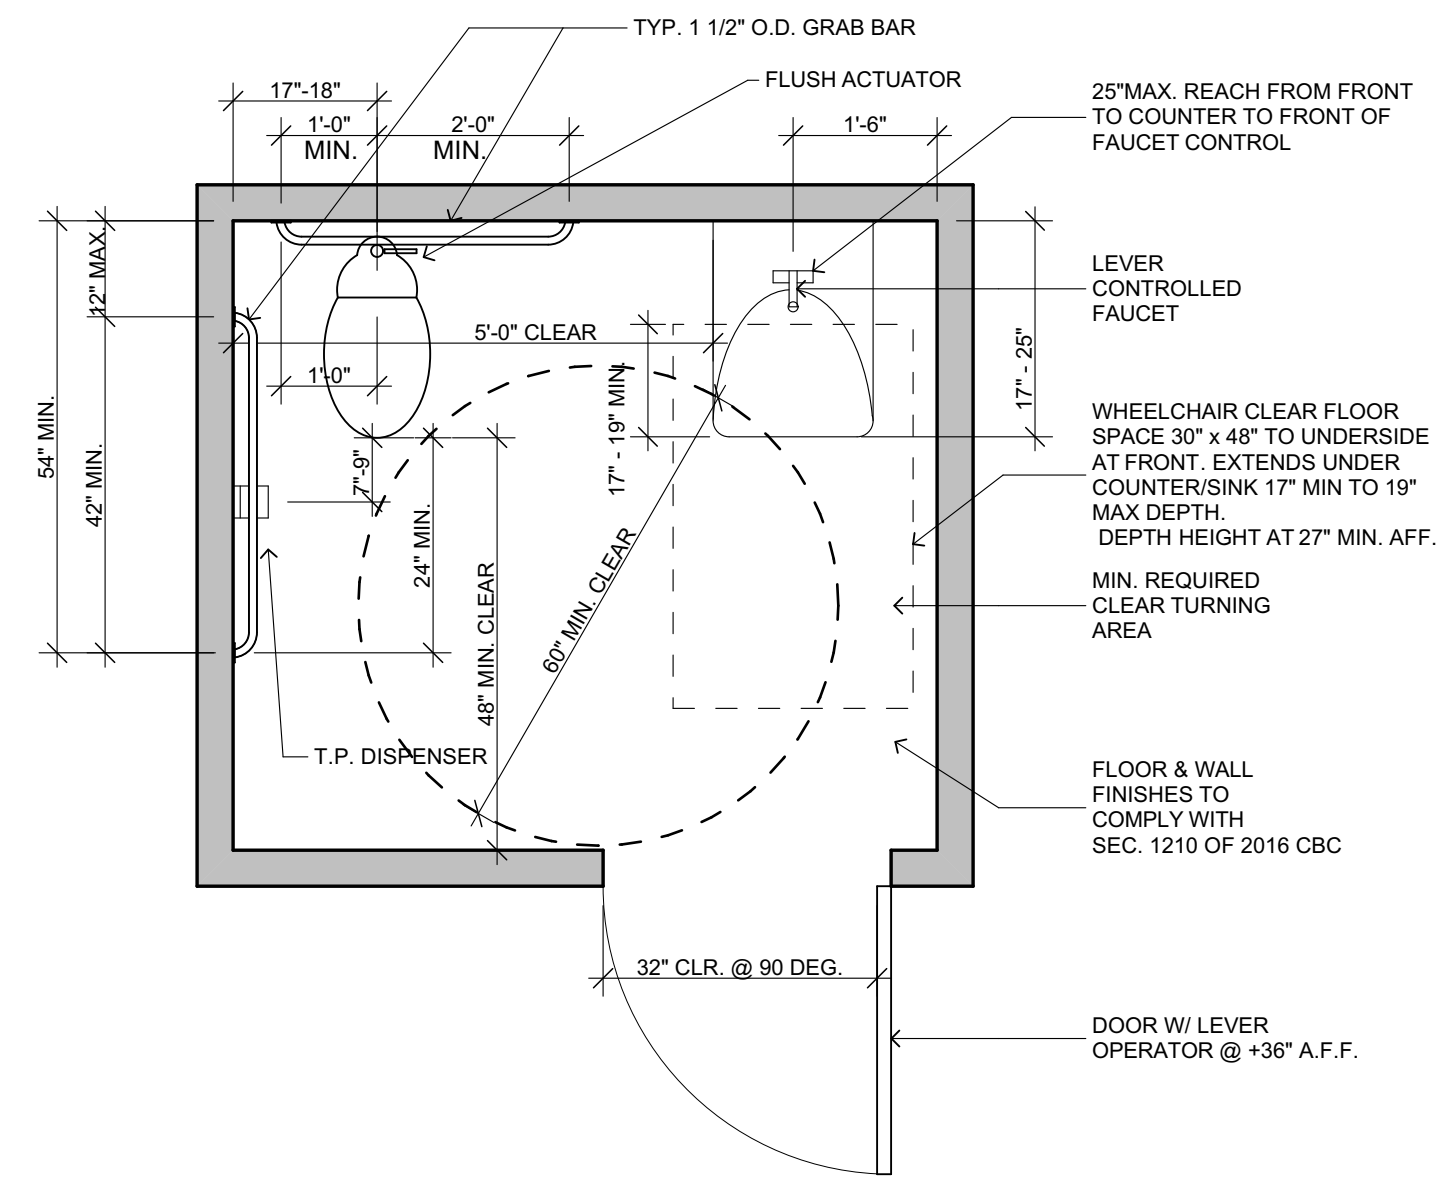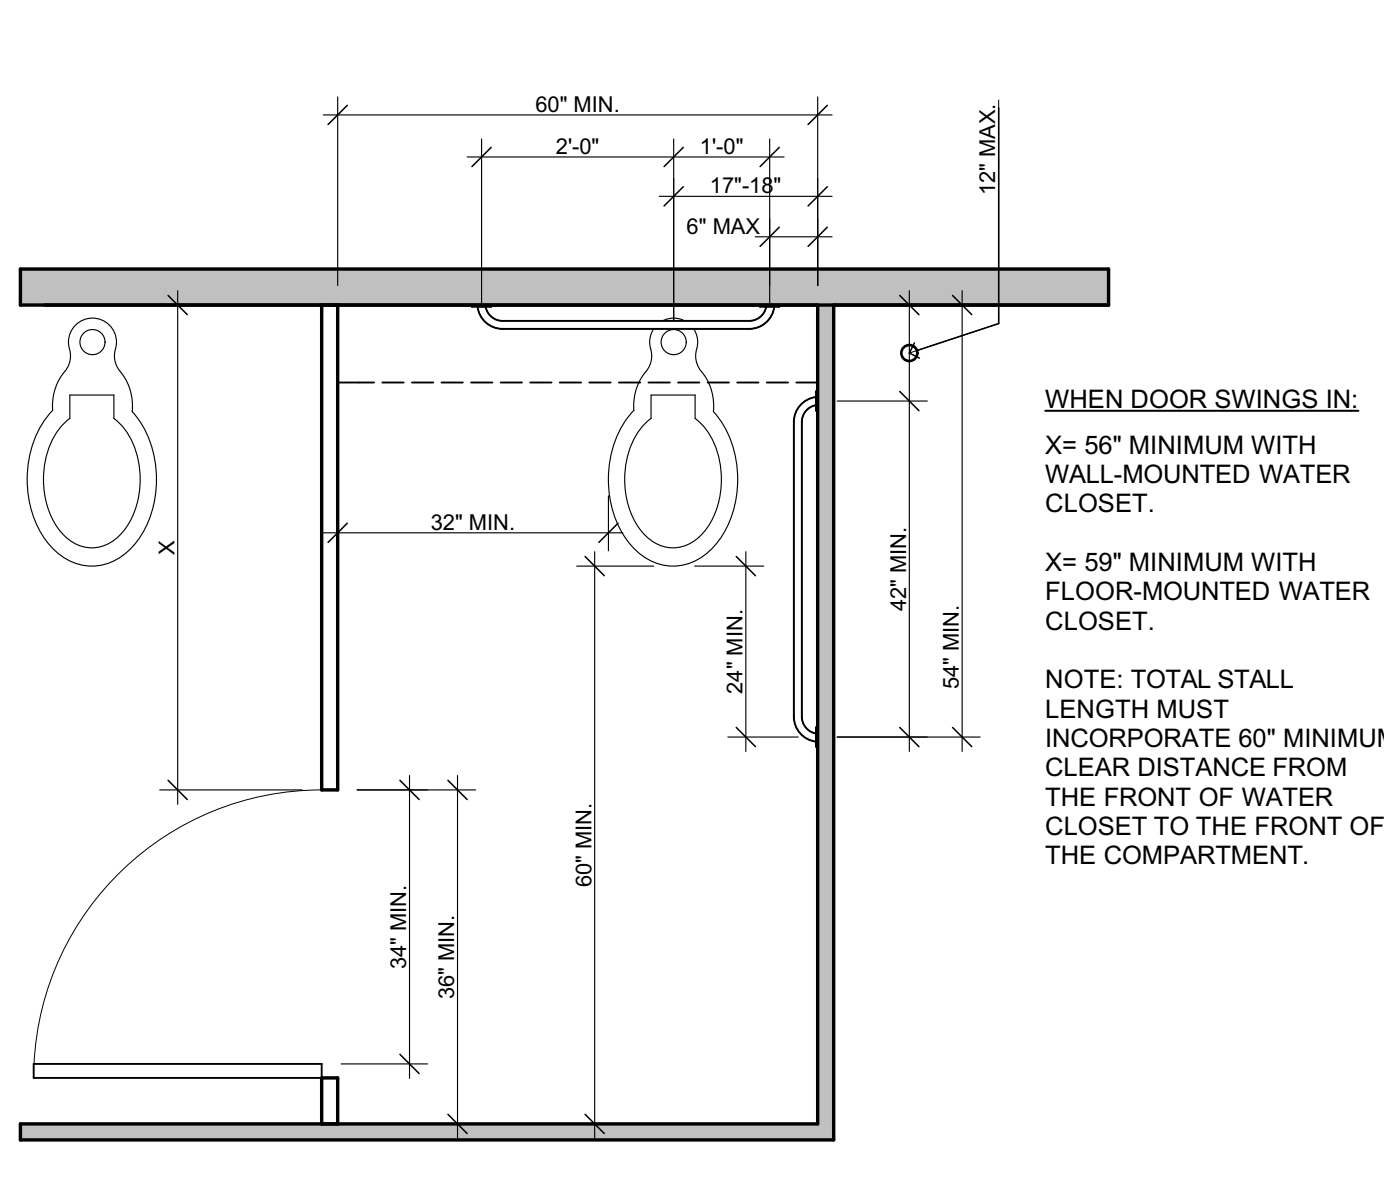- ALL PUBLIC SPACES INCLUDING THE BUILDING ENTRANCE, GARAGES, PLAZA, ENTRY COURT, LOBBY, PUBLIC HALLWAYS & STAIRS, AND ELEVATOR LOBBIES ARE TO BE FULLY ACCESSIBLE.
- ALL BATHROOMS, KITCHENS, CORRIDORS, AND CORRIDORS ON THE FLOORS DESCRIBED ABOVE ARE SUBJECT TO THE TYPICAL DETAILS DESCRIBED ON THIS SHEET.
- EVERY ACCESSIBLE PARKING SPACE SHALL BE IDENTIFIED BY A SIGN AT THE HEAD OF THE SPACE MOUNTED BETWEEN 36"-60" A.F.F. THE SIGN SHALL INCLUDE THE INTERNATIONAL SYMBOL OF ACCESSIBILITY AND STATE "RESERVED", OR EQUIVALENT LANGUAGE.
- A SIGN OF MIN. 17"x22" IN SIZE SHALL BE POSTED IN A CONSPICUOUS PLACE AT THE PARKING GARAGE ENTRY STATING THE FOLLOWING IN MIN. 1" HT. LETTERS: "UNAUTHORIZED VEHICLES PARKED IN DESIGNATED HANDICAPPED SPACES NOT DISPLAYING DISTINGUISHING PLACARDS OR LICENSE PLATES ISSUED FOR PHYSICALLY DISABLED PERSONS MAY BE TOWED AT THE OWNER'S EXPENSE. TOWED VEHICLES MAY BE RECLAIMED AT _____ OR BY TELEPHONING _____."
- ALL STAIR TREADS IN THE PUBLIC STAIRWAYS SHALL BE OF A SLIP-RESISTANT MATERIAL/TEXTURE.
- DOOR OPERATING HARDWARE SHALL BE LEVER-TYPE IN ALL ACCESSIBLE/ADAPTABLE LOCATIONS. HANDLES SHALL BE INSTALLED BETWEEN 30"-44" A.F.F. MAXIMUM EFFORT REQ'D TO OPEN DOORS SHALL NOT EXCEED 8.5LBS. FOR EXTERIOR DOORS, 5LBS. FOR INTERIOR DOORS, & 15LBS. FOR FIRE DOORS.
- THE CENTER OF THE GRIP OF THE OPERATING LEVER FOR SWITCHES USED TO CONTROL LIGHTS, THERMOSTATS, & ENVIRONMENTAL CONTROLS SHALL BE LOCATED BETWEEN 15"-48" A.F.F.
- ALL ACCESSIBLE/ADAPTABLE SINKS, VANITIES, TUBS AND SHOWERS SHALL BE EQUIPPED WITH LEVER-OPERATED FAUCETS.
- GRAB BARS NEED NOT BE INSTALLED IN ACCESSIBLE/ADAPTABLE BATHPOWDER ROOMS, HOWEVER THE BLOCKING REQUIRED FOR THEIR PROPER INSTALLATION SHALL BE INSTALLED. THE STRUCTURAL STRENGTH OF THE WALL FRAMING, BLOCKING, GRAB BARS AND MOUNTING DEVICES SHALL BE CAPABLE OF WITHSTANDING A 250 POUND LOAD.
- ALL MULTI-STORY RESIDENTIAL UNITS SHALL COMPLY WITH CBC SEC. 1102A.3.2.

NOTE: THIS INFORMATION IS PROVIDED FOR REFERENCE AND IS NOT INTENDED TO RELIEVE DESIGNER OF RESPONSIBILITY TO DIMENSION PLANS TO PROVIDE REQUIRED CLEARANCES.



**Kotas/
Pantaleoni
Architects**
Anthony A. Pantaleoni
LEED AP
70 Zoo Street Suite 200
San Francisco, California 94110
t 415 495 4051
design@kp-architects.com

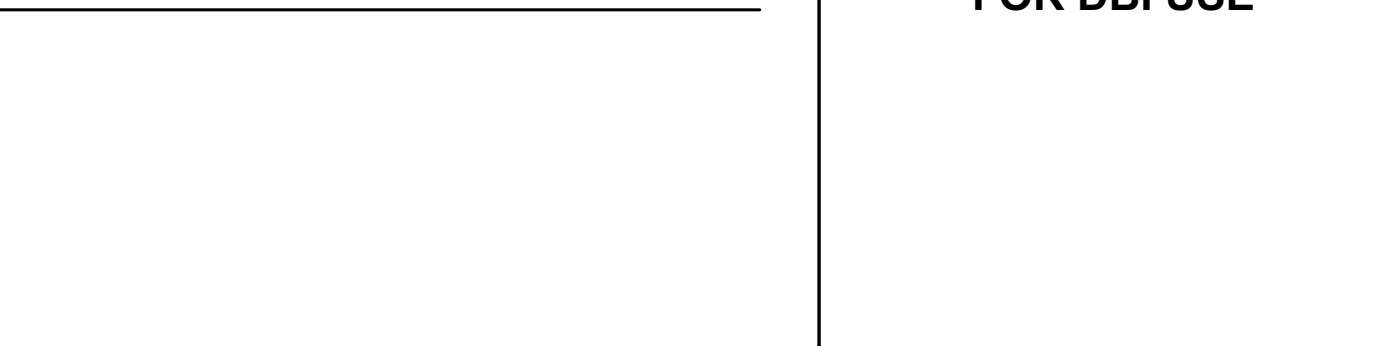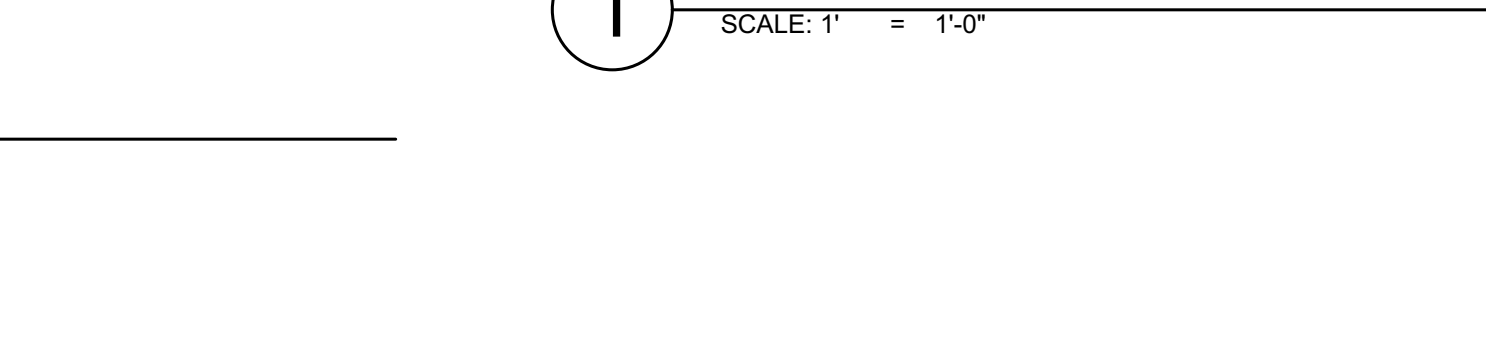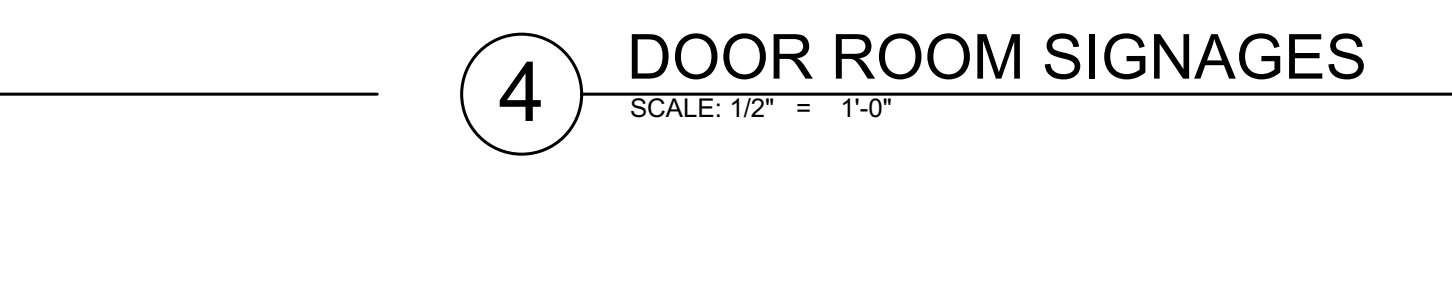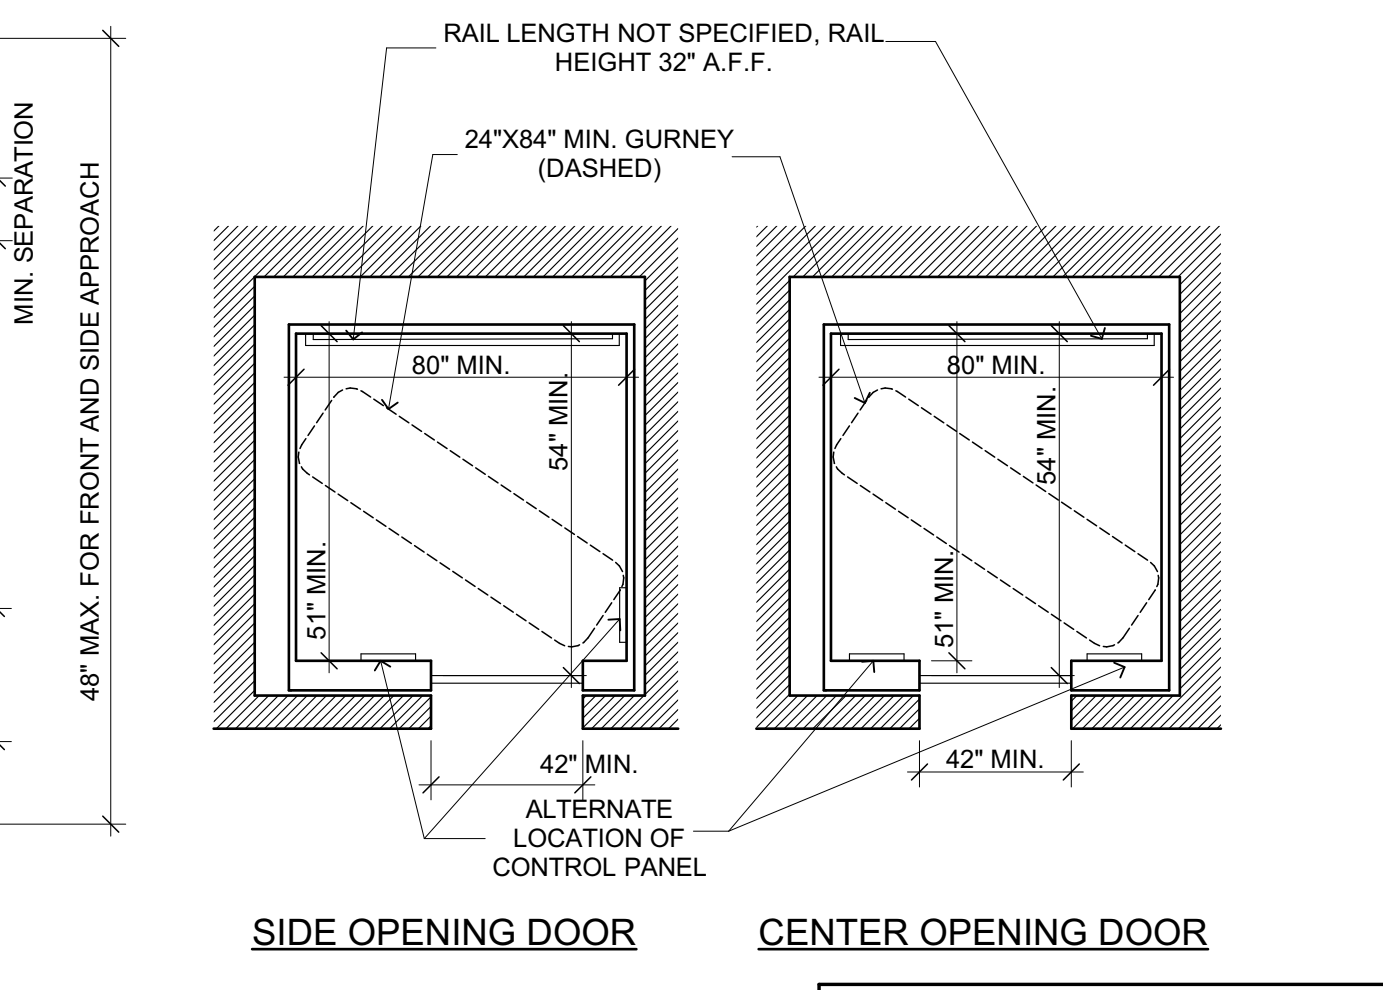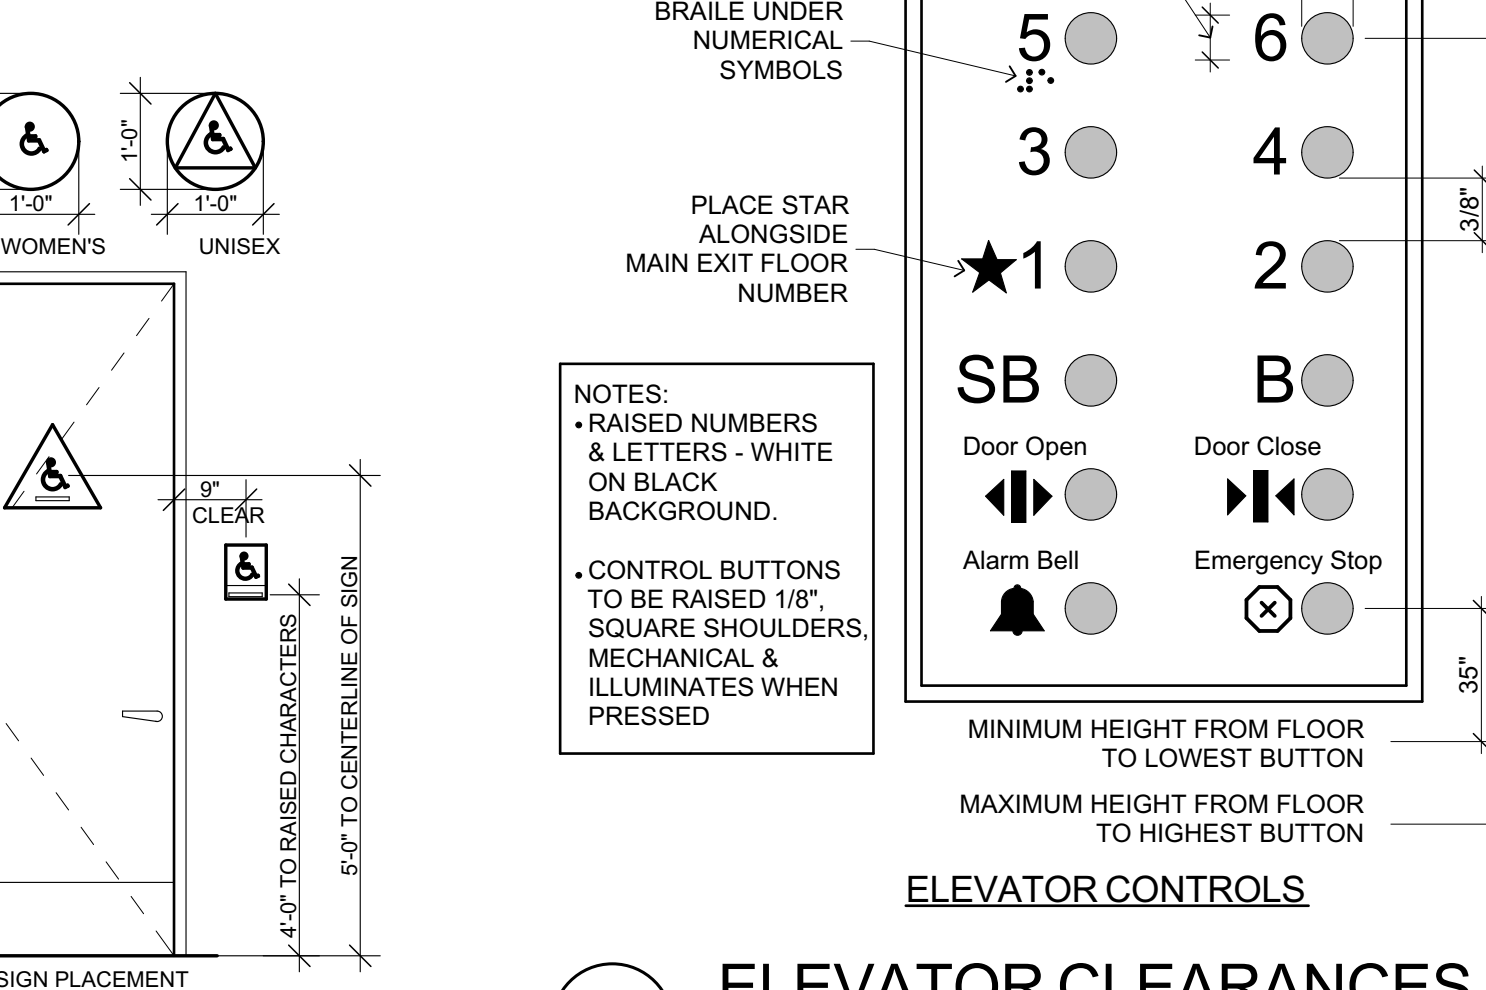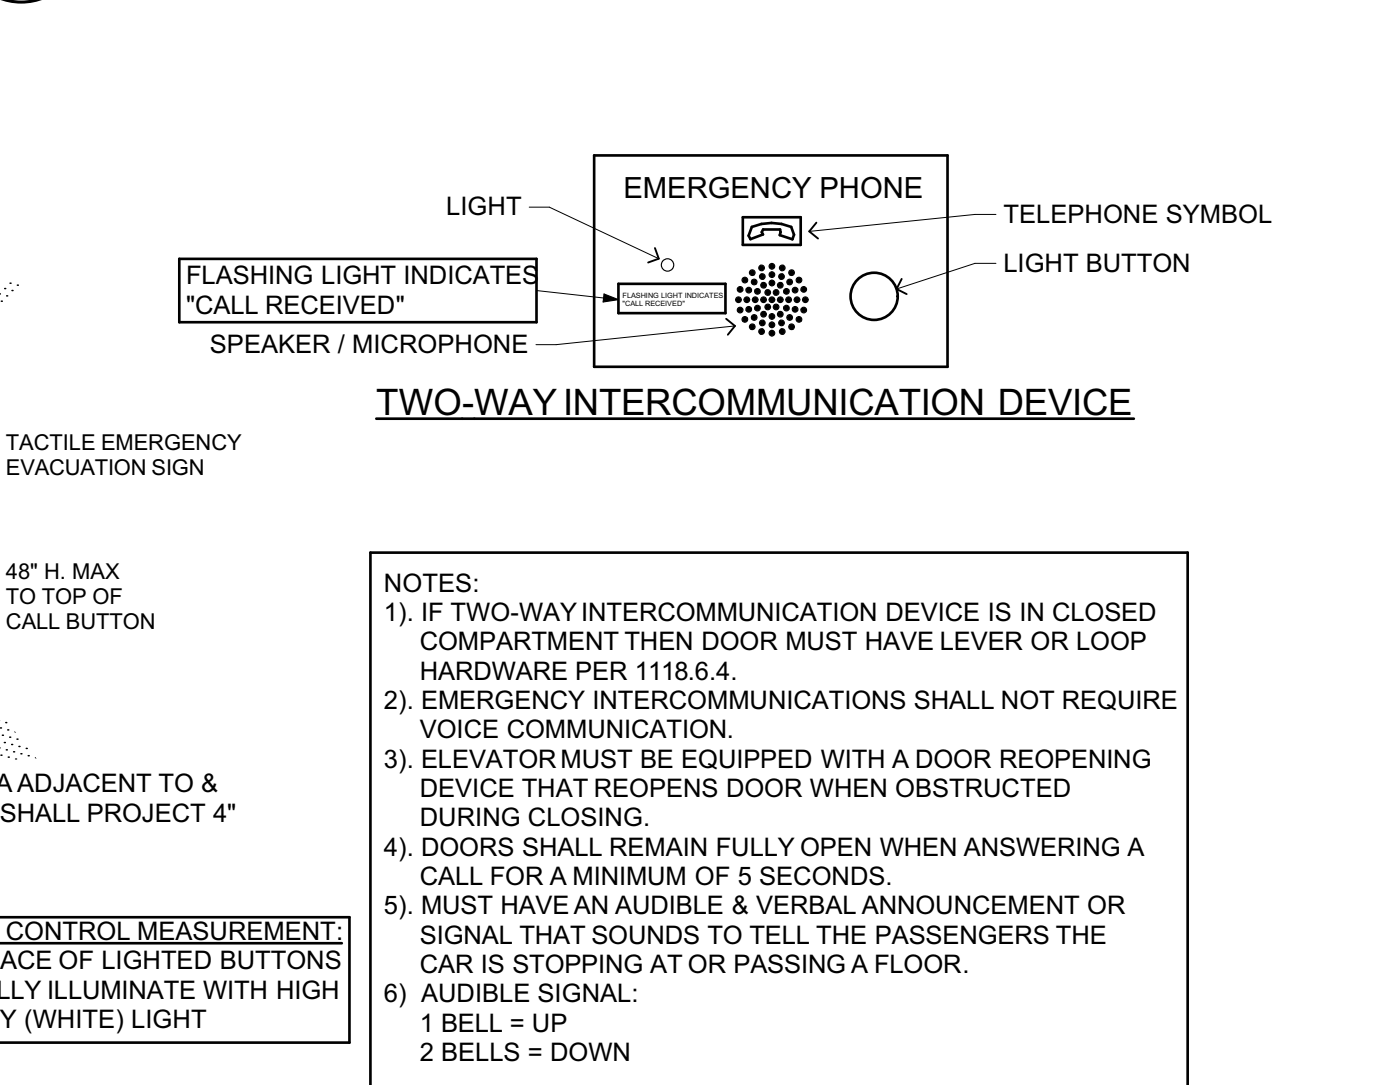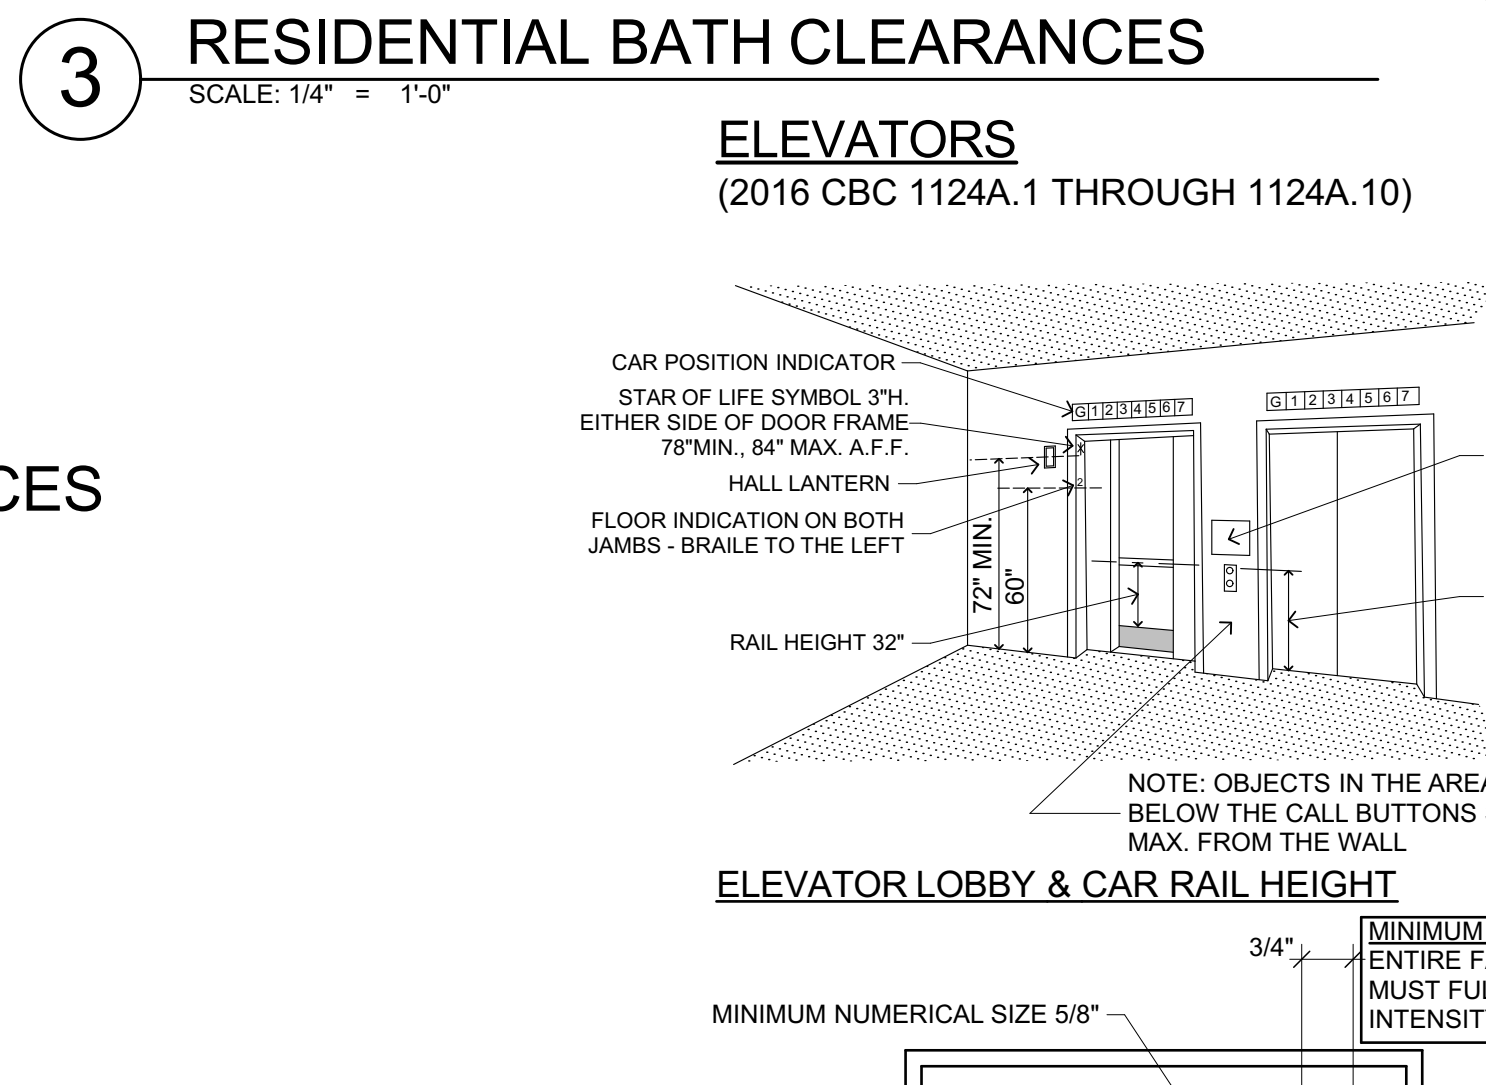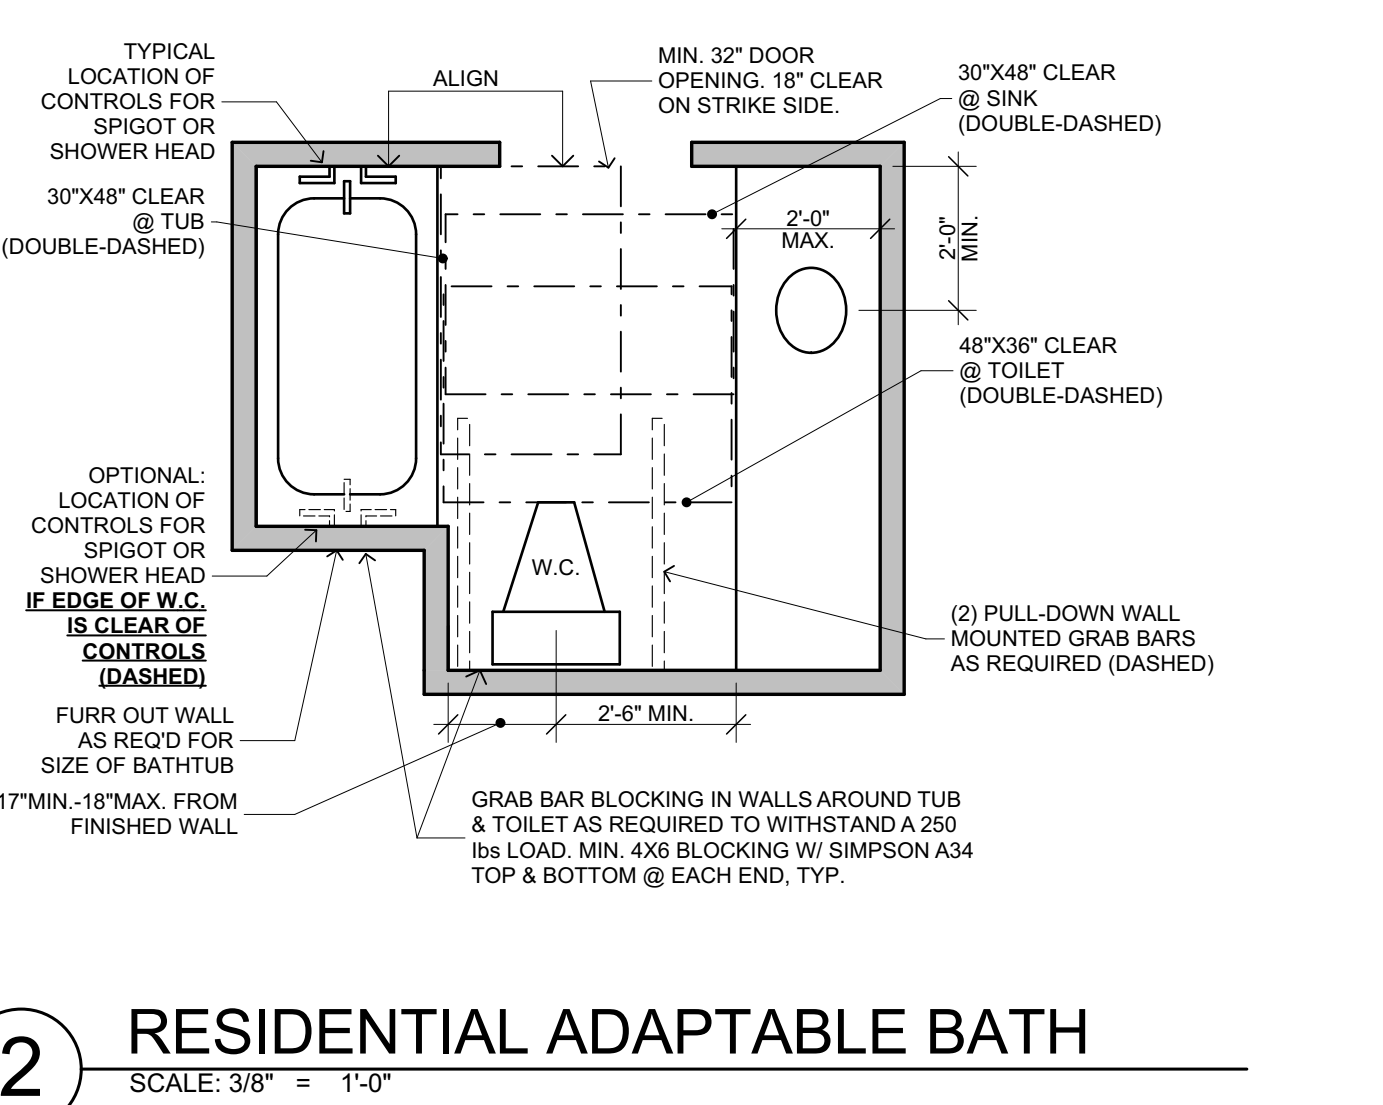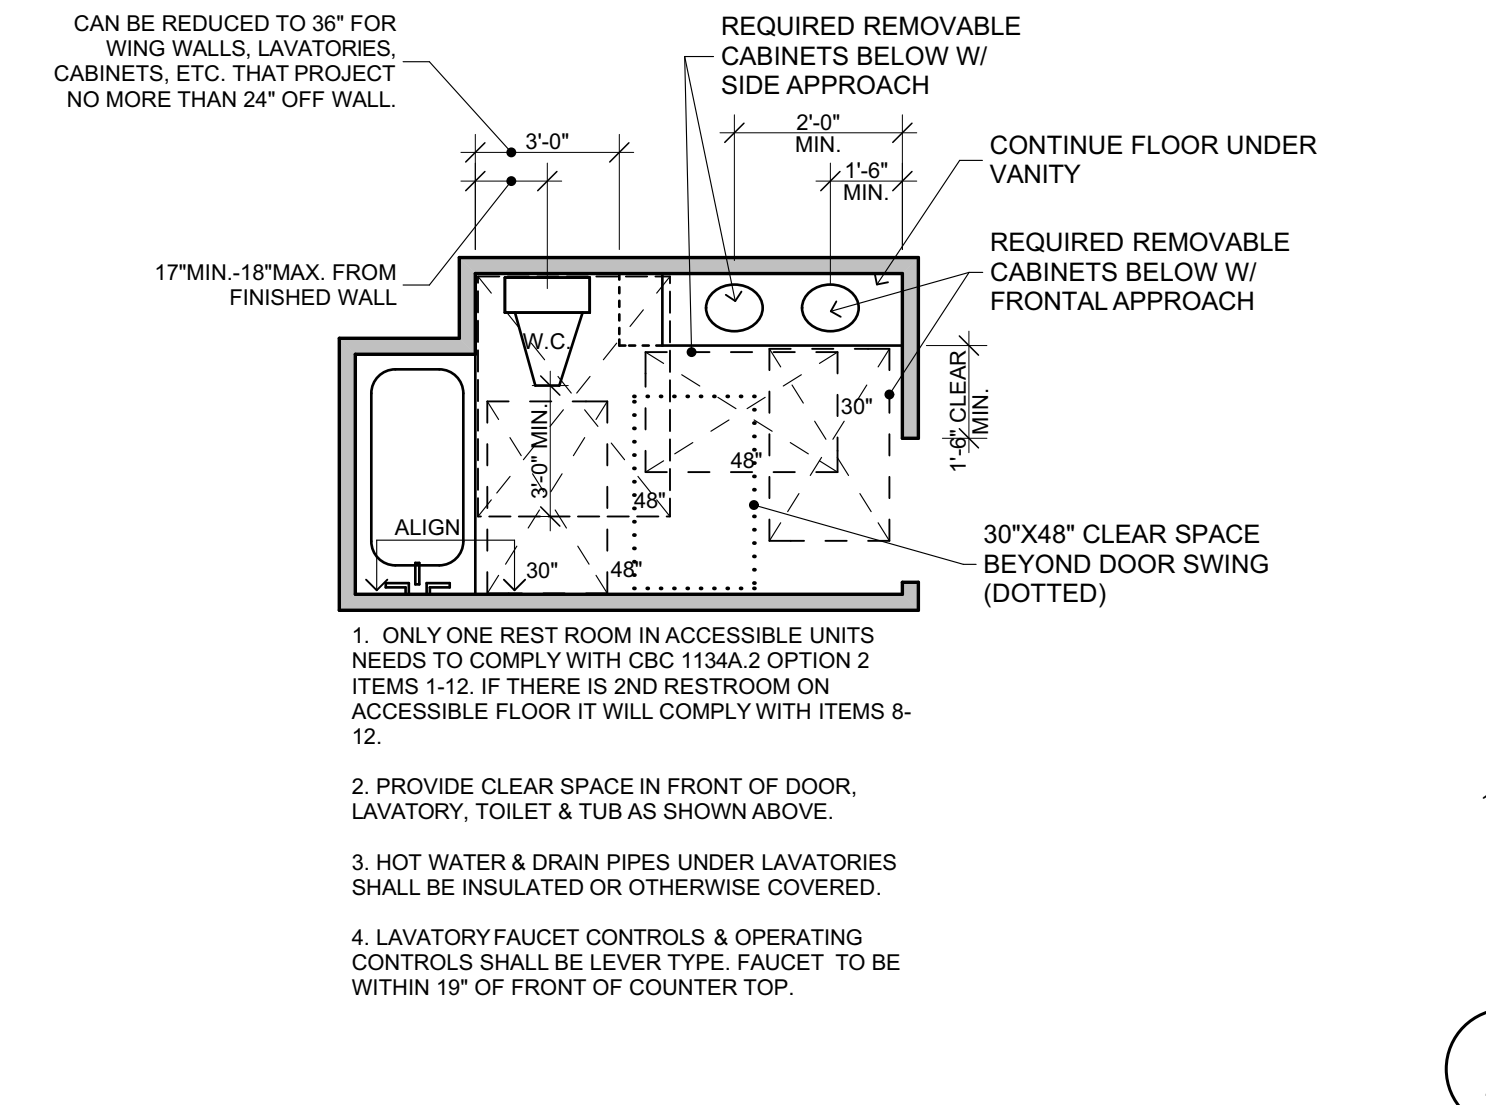

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**15 RESIDENTIAL UNITS
986 SOUTH VAN NESS AVENUE
SAN FRANCISCO, CA 94110**

Sheet Title:
**Details:
ADA DETAILS**

Date: 11.19

Drawn By: BM

Job Number: 2-1119

A5.0



Revisions	By
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15 RESIDENTIAL UNITS
986 SOUTH VAN NESS AVENUE
SAN FRANCISCO, CA 94110


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Details:
ADA DETAILS

Date: 11.19

Drawn By: BM


Job Number: 2-1119

A5.1

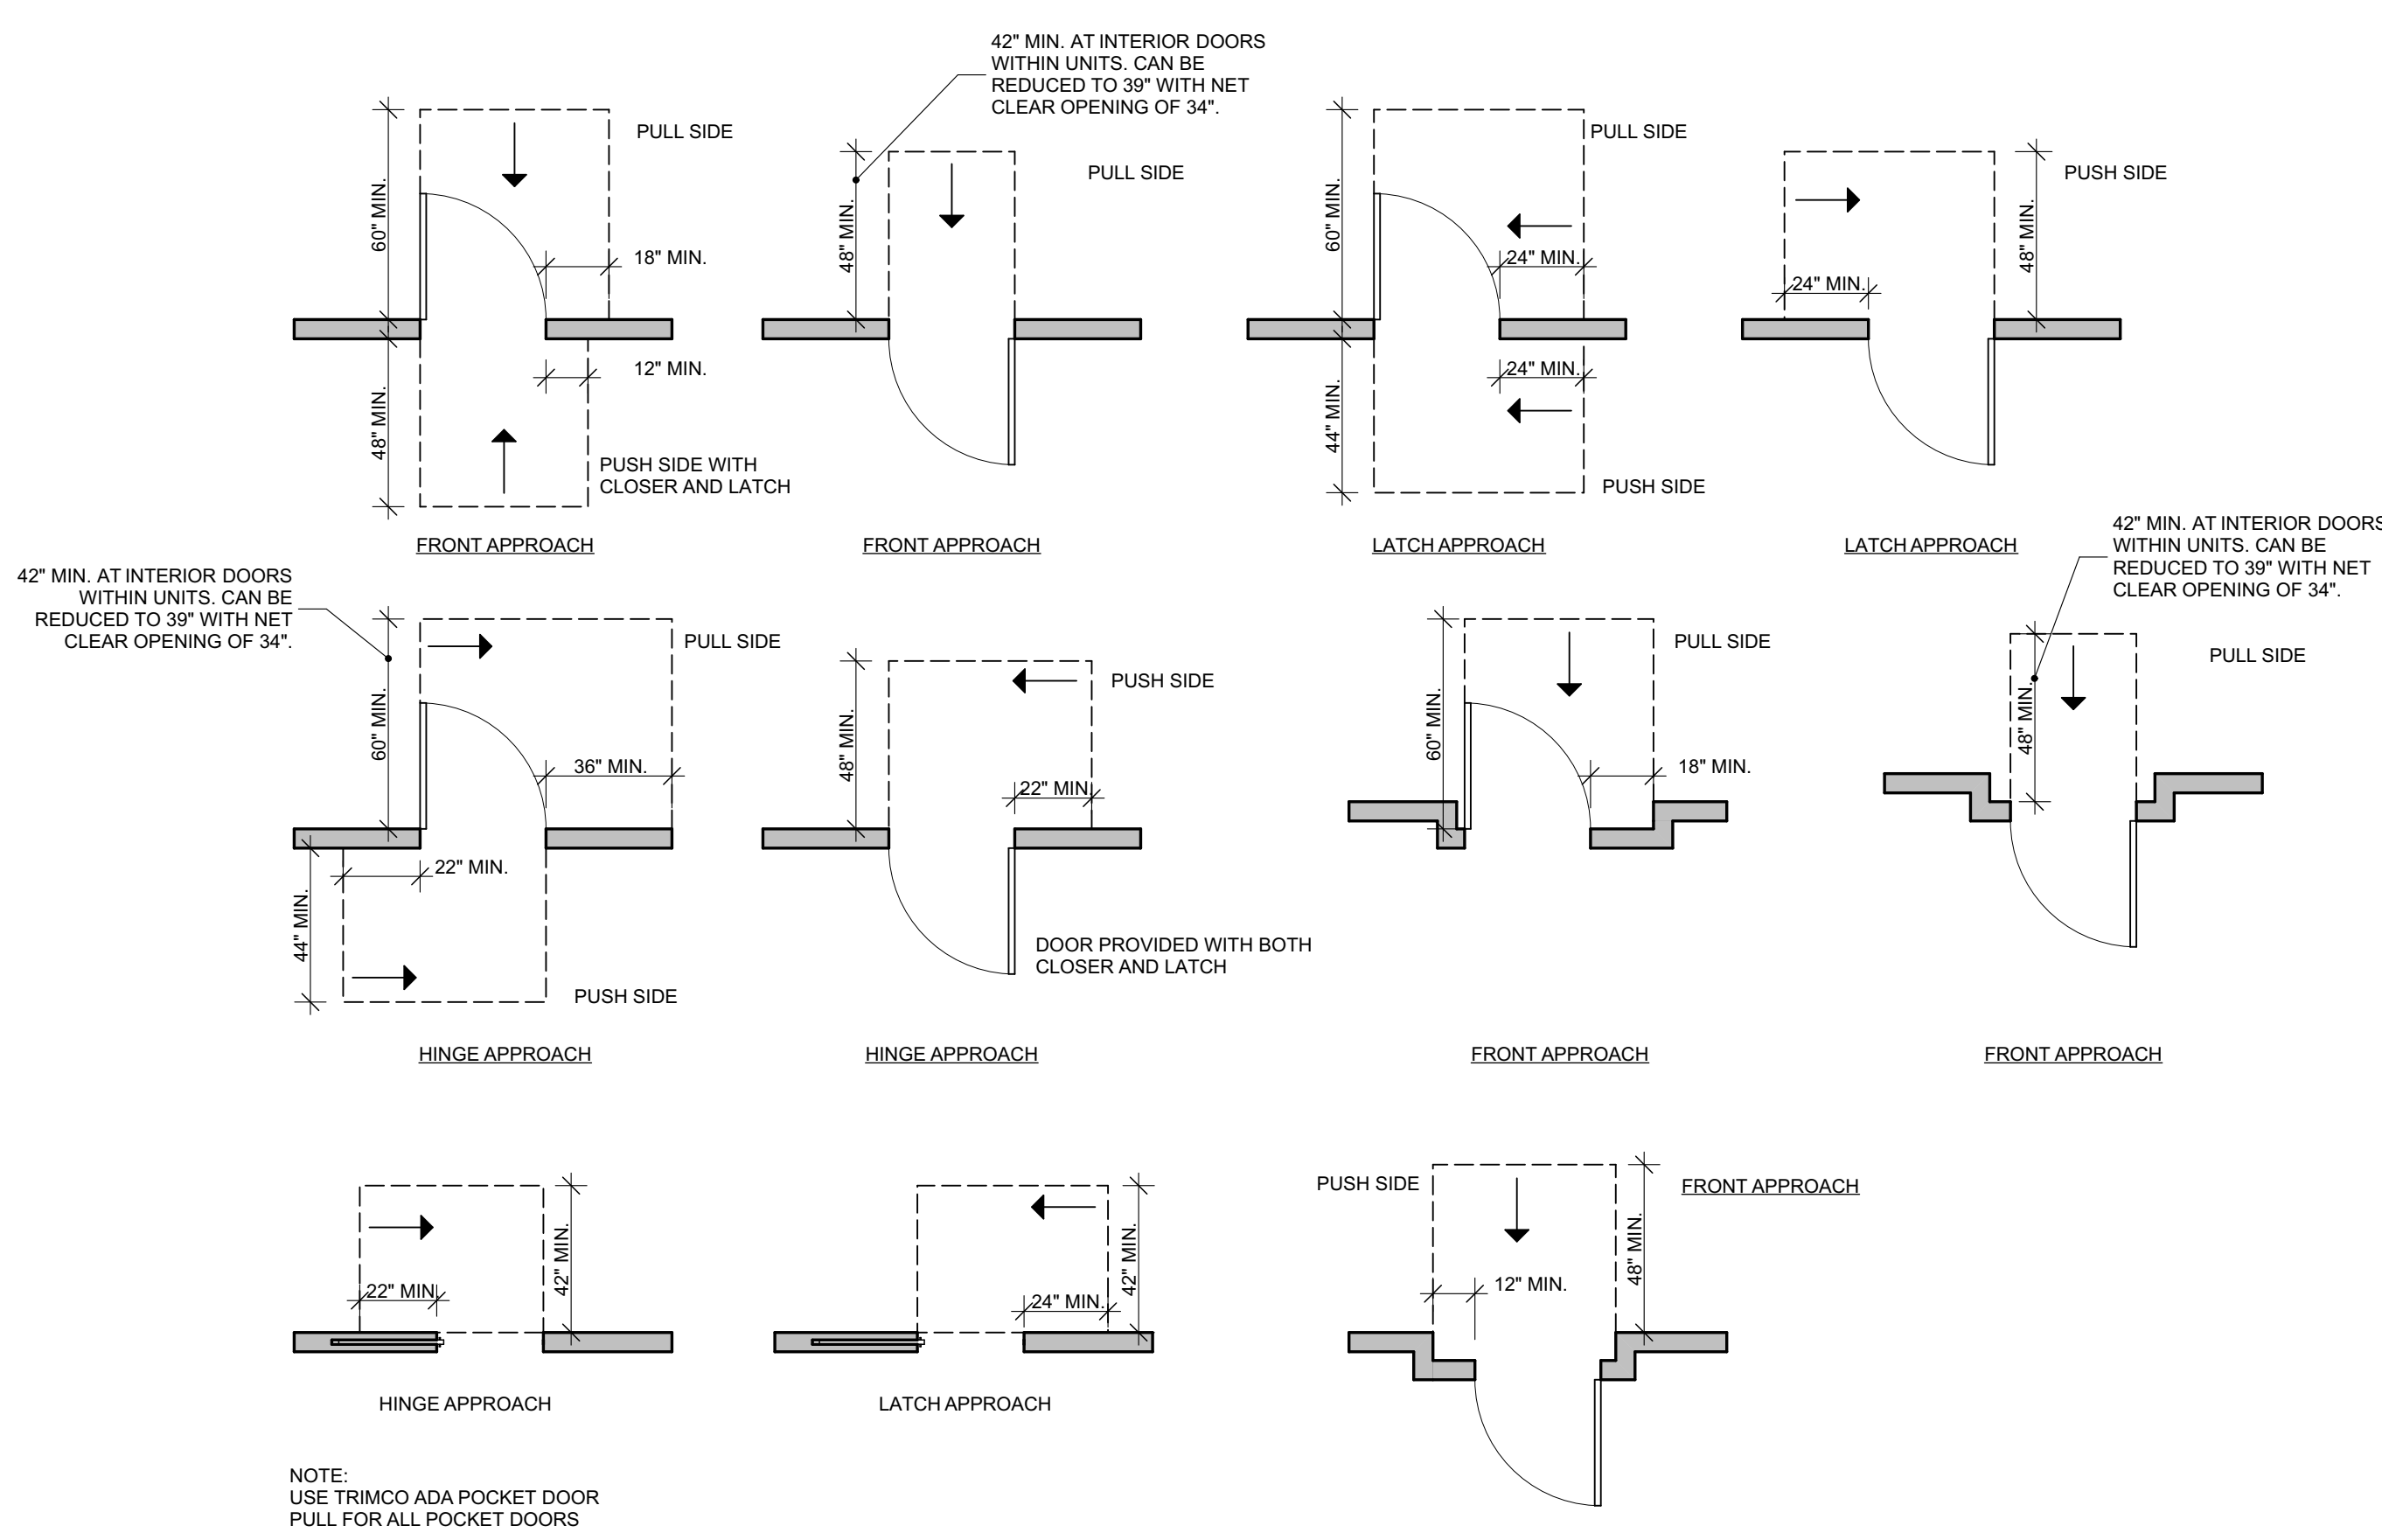

11 DOOR CLEARANCES

SCALE: 1/4" = 1'-0"

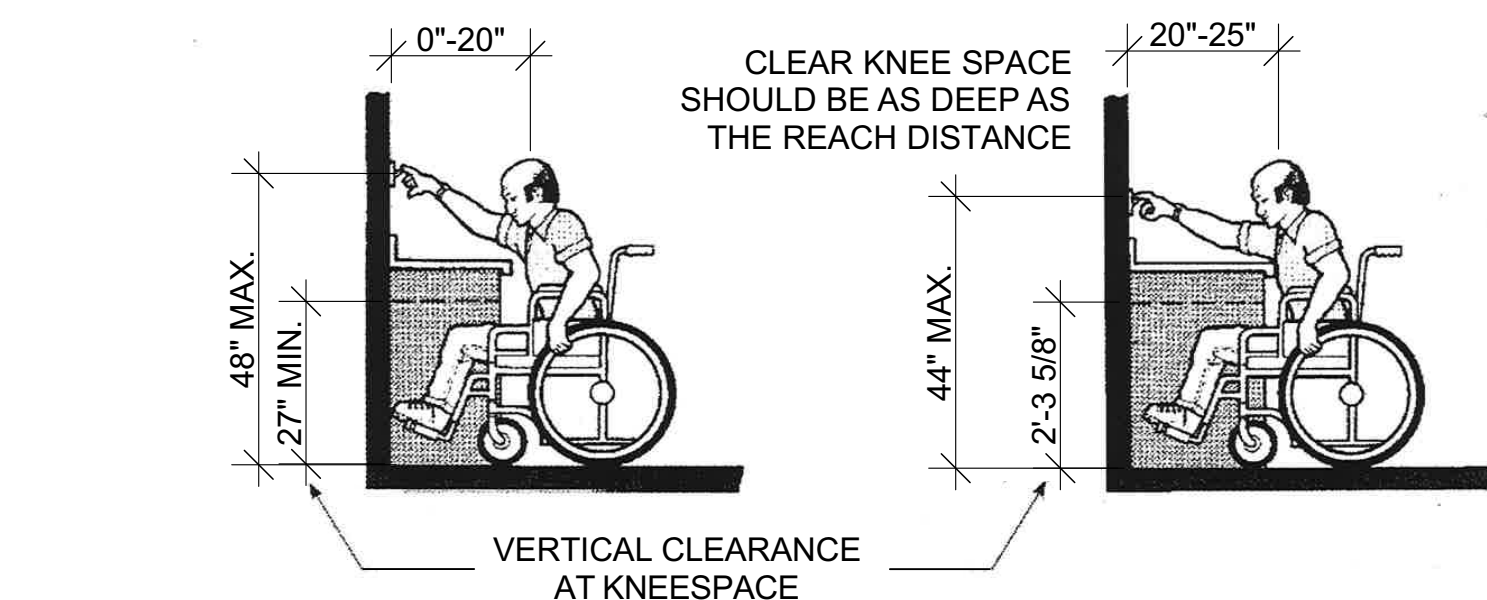


10 REACH DIAGRAM

SCALE: 3/8" = 1'-0"

9 STAIR CLEARANCES

SCALE: 1/4" = 1'-0"

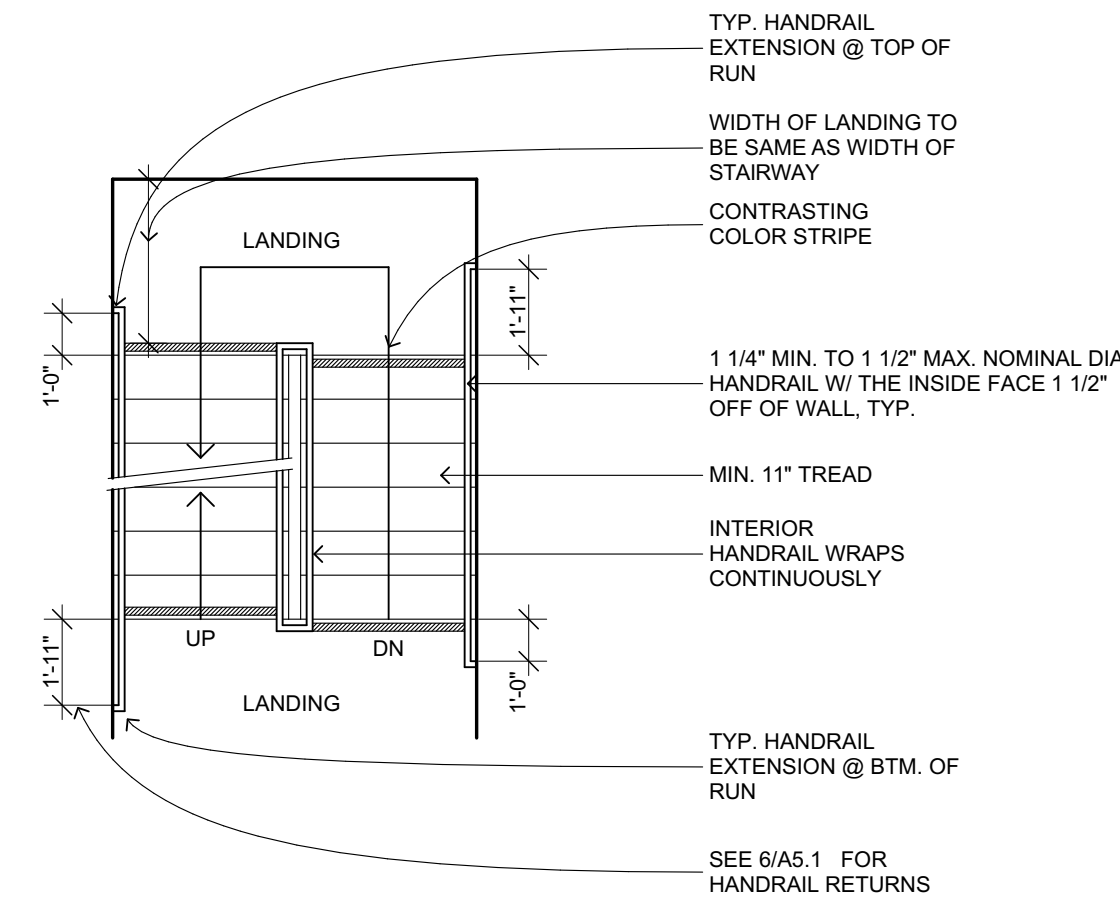


8 KITCHEN CLEARANCES

SCALE: 1/4" = 1'-0"


7 DOOR KICKPLATE

SCALE: 1 1/2" = 1'-0"

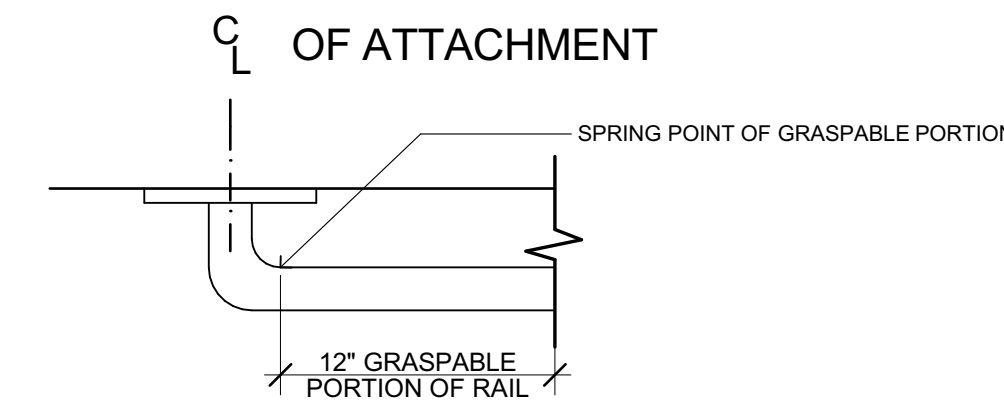


6 HANDRAIL EXTENSION RETURN

SCALE: 1/2" = 1'-0"

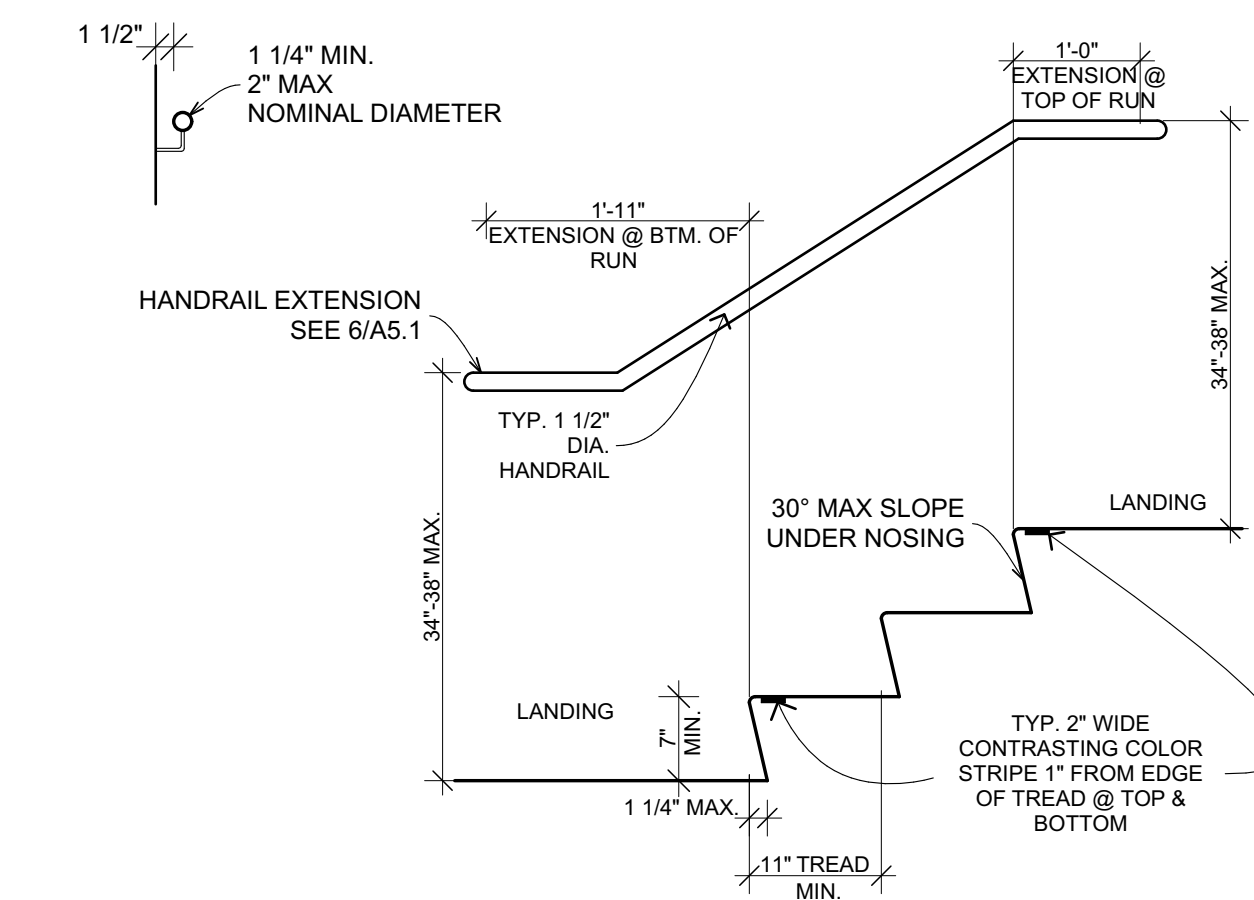


5 HANDRAIL TREAD DETAILS

SCALE: 3/4" = 1'-0"

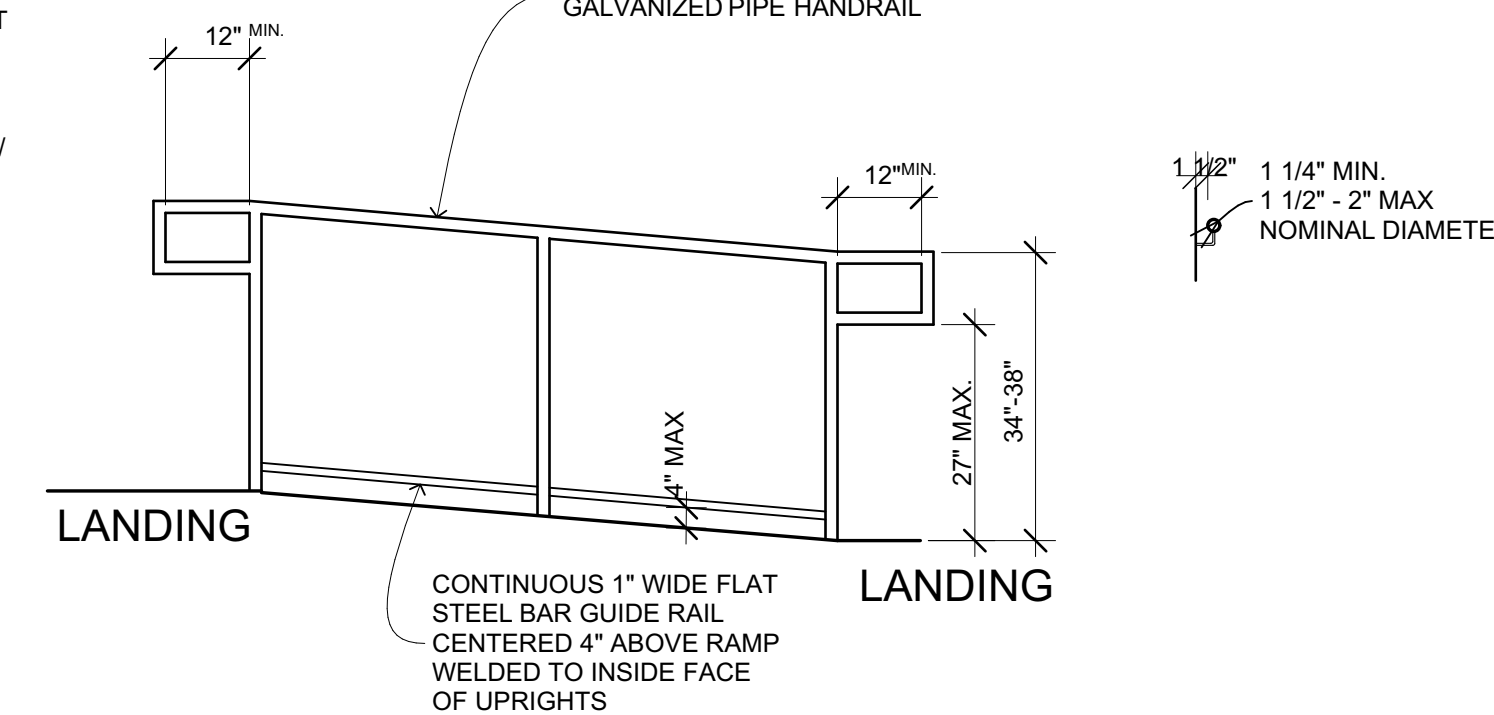


4 RAMP RAILING

SCALE: 1/2" = 1'-0"

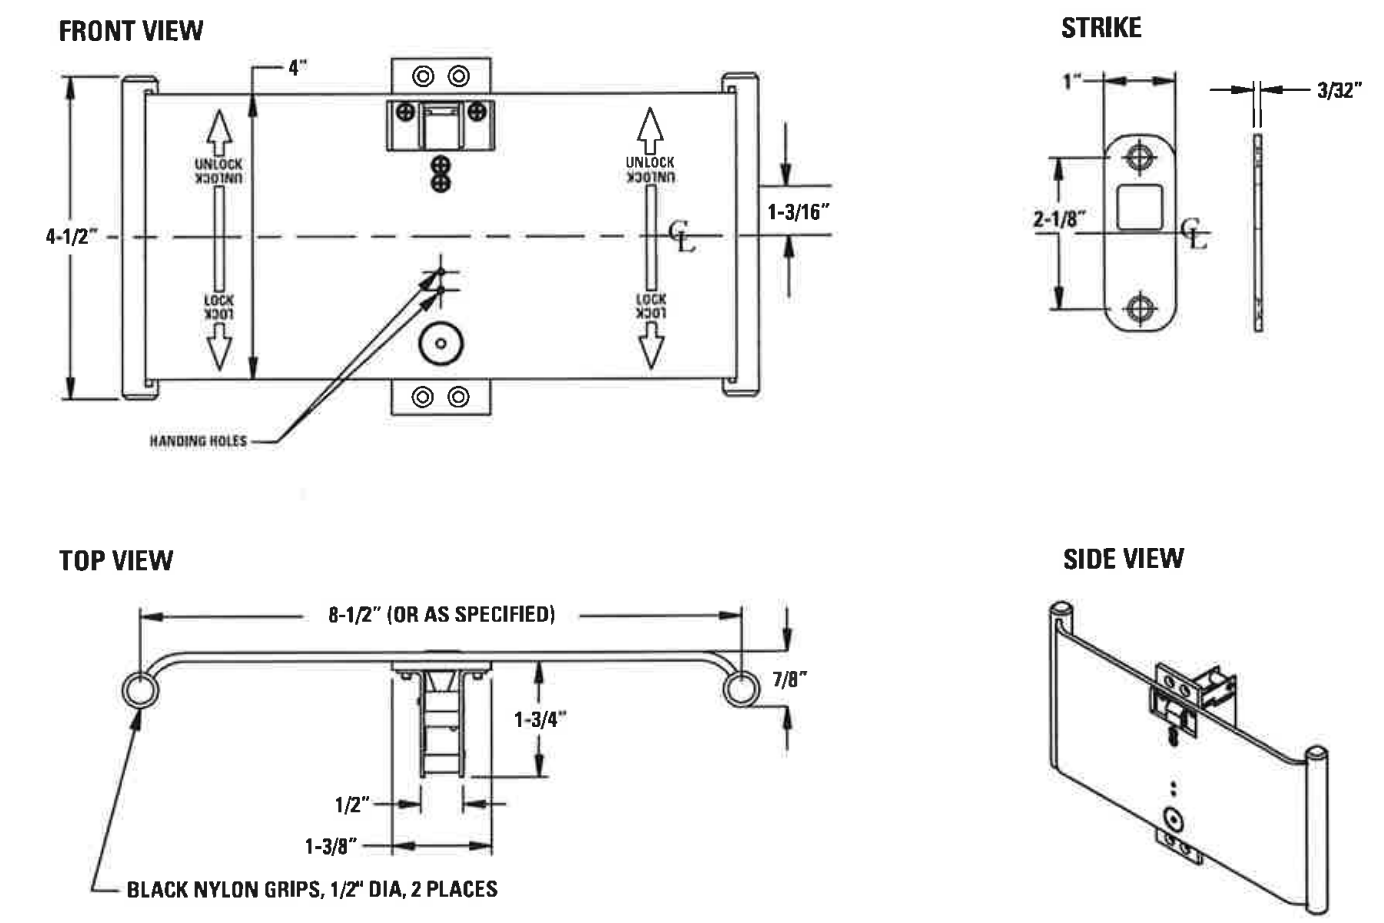

3 POCKET DOOR LATCH


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- NOTES:
- WHERE NO WALL EXISTS TO MOUNT SIGNAGE, MOUNT SIGN ON POLE W/ BOTTOM OF SIGN MIN. 80" A.F.F. WALL MOUNTED SIGNS TO BE 36" A.F.F. TYPICALLY.
 - DESIGNATE "VAN ACCESSIBLE" WHERE APPLIES.
 - DIAGONAL STRIPES TO BE SPACED 3'-0" APART.
 - FOR ASSIGNED PARKING SPACES NO SIGNAGE IS REQUIRED EXCEPT FOR "NO PARKING" IN ACCESS AISLE.

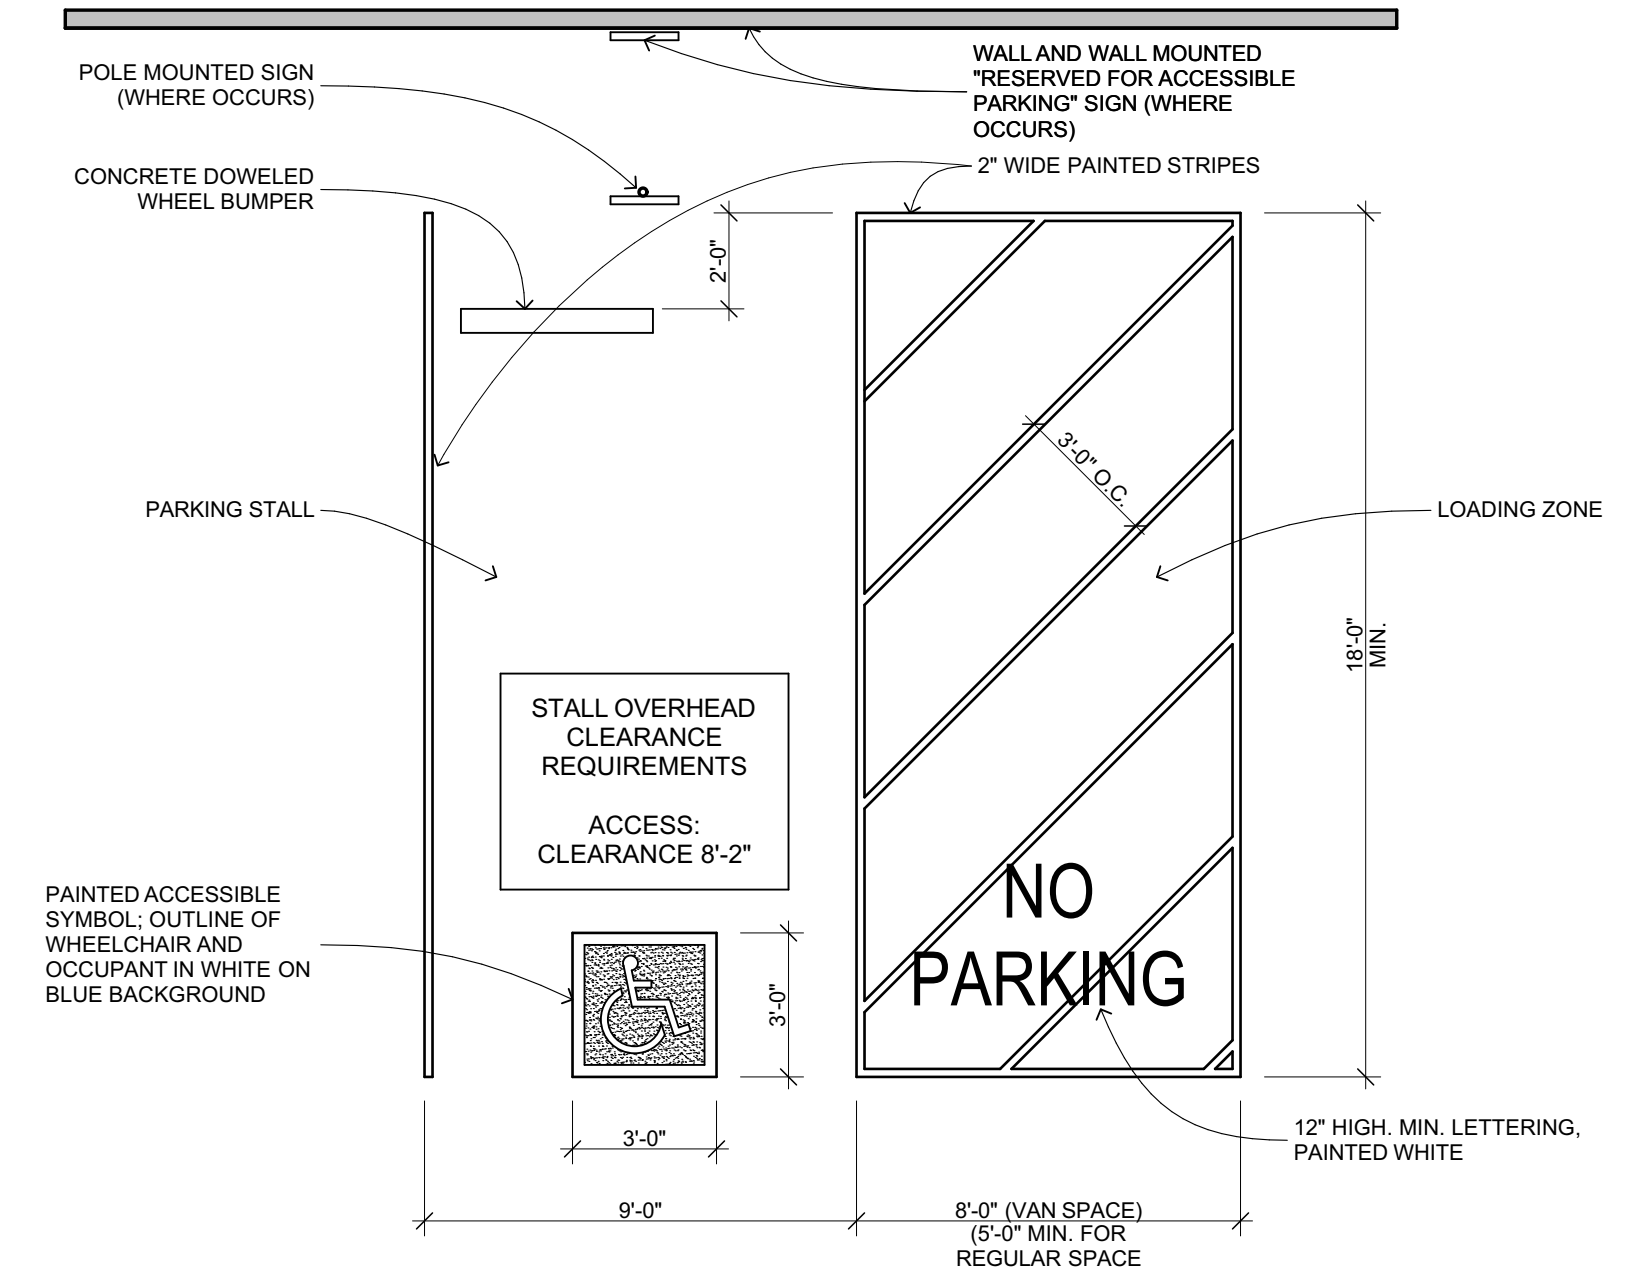2 ACCESSIBLE PARKING STALL

SCALE: 1/4" = 1'-0"



1 ACCESSIBLE PARKING SIGNAGE

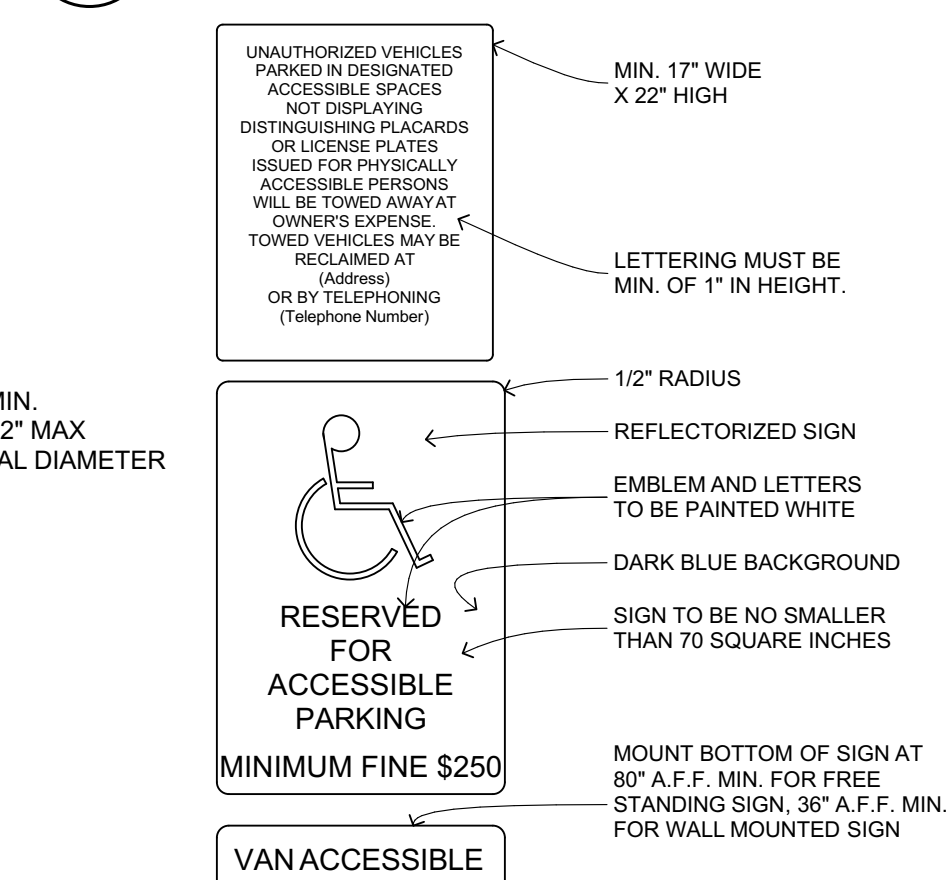SCALE: 1/2" = 1'-0"

FOR DBI USE